### **PROJECT ADDRESS**

205 W. KINCAID ST MOUNT VERNON, WA 98273

PARCEL NUMBER: P26637

## **BUILDING INFORMATION**

**DATE OF ORIGINAL CONSTRUCTION: 1923** 

**ZONING DESIGNATION:** PUBLIC (P)

**BUILDING CODE ASSUMPTIONS:** 

**BUILDING CODES USED: 2021 EXISTING BUILDING CODE** 

2021 INTERNATIONAL BUILDING CODE

OCCUPANCIES ASSUMED: A-3 (303.4-COURTROOMS) AND B (304.1 -CIVIC ADMINISTRATION) @ FLOORS 1-3 S-2 (ASSUMED FOR THE ROOF TOP MECHANICAL ROOM) @ FLOORS 4 ROOFTOP CONSTRUCTION TYPE ASSUMED: IIB (NON-COMBUSTIBLE)

603.1 IBC: COMBUSTIBLE MATERIALS PERMITTED IN TYPE I AN II CONSTRUCTION AS FOLLOWS: 1.3 FIRE-RETARDENT-TREATED WOOD PERMITTED IN ROOF CONSTRUCTION FOR THIS TYPE IIB 27. "COMBUSTIBLE" WOOD NAILERS FOR PARAPET FLASHING AND ROOF CANTS CONSTRUCTION TYPE IS ASSUMED BASED ON 2021 IBC TABLE 504.3 BASED ON HEIGHT OF EXISTING SPRINKLERED FLOORS 1-3 (75' MAXIMUM) AND EXISTING NON-SPRINKLERED ROOF TOP FLOOR 4 (55' MAXIMUM)

FIRE PROTECTION SYSTEMS: 4TH FLOOR: CLASS 2 STANDPIPES (TO BE RELOCATED PER PLAN) 3RD FLOOR AND BELOW: EXISTING SPRINKLER SYSTEM (NO CHANGES)

## LEGAL DESCRIPTION

(1.5800 ac) TAX 132: DK 3: BEG ON N LI KINCAID ST AT ITS INT WI W LI 3RD ST TH N ALG W LI 3RD ST TAP 224.5FT W & 224.5FT N OF SE C GOVERNMENT LOT 7, SECTION 19, TOWNSHIP 34 NORTH, RANGE 4 EAST, W.M., TH N 81-54 W 78.24FT TH W 107.25FT TH S 100FT TH W 93FT TO E LI 2ND ST TH S ALG E LI 2ND ST TO INT WI N LI KINCAID TH E ALG N LI KINCAID TPB BEING TAX 31 32 33 36 38 31 1/2

## PROJECT DESCRIPTION

THE PROJECT CONSIST OF FURNISHING ALL LABOR, MATERIALS, AND OTHER INCIDENTALS TO REMOVE MAJOR PORTIONS OF THIS ROOFTOP JAIL STRUCTURE. ELIMINATION OF THE UNUSED CONCRETE JAIL STRUCTURE IS BEING PERFORMED TO REDUCE THE SEISMIC DEMANDS ON THE THREE FLOORS OF THE WORKING SUPERIOR COURTHOUSE BUILDING BELOW. THE PROJECT INCLUDES RETENTION OF THE EXISTING STAIR, ELEVATOR, AND MECHANICAL ROOM EQUIPMENT SPACES SERVICING THE FLOORS BELOW. ALL EXISTING ROOF ASSEMBLIES AND A COOLING TOWER WILL BE REMOVED AND REPLACED AS PART OF THE WORK. AS THE COURTHOUSE WILL BE IN USE DURING THE CONSTRUCTION PERIOD, THE EXISTING COOLING TOWER AND SELECT PLUMBING EQUIPMENT IN MECHANICAL ROOM SHALL REMAIN OPERABLE DURING WORKING HOURS OF THE COURTHOUSE. ADDITIONALLY, ALL WORK ON PROJECT CAUSING NOISE, ODORS OR AIR-BORNE DEBRIS SHALL BE PERFORMED ONLY WHEN THE COURTHOUSE IS NOT IN USE.

## **ABBREVIATIONS & ACRONYMS:**

ABB OR ABBAE: ALLANA BUICK & BERS. INC. A/B: AIR BARRIER A/E: ARCHITECT/ENGINEER AOR: ARCHITECT OF RECORD AHJ: AUTHORITY HAVING JURISDICTION AL: ALUMINUM ALT: ALTERNATE ARCHT: ARCHITECT **BEC: BUILDING ENCLOSURE** CONSULTANT BSAM: BUTYL SAM C.I.: CONTINUOUS INSULATION CFS: COLD FORMED STEEL CL: CENTER LINE **CLNG: CEILING** CMU: CONCRETE MASONRY **CONT: CONTINUOUS DEIFS: DRAINABLE EXTERIOR** INSULATED FINISH SYSTEM DS: DOWN SPOUT (E) OR EXIST: EXISTING ELEC: ELECTRICAL **ENG: ENGINEER EXIST: EXISTING** EQ: EQUAL EXT GWB: 5/8" TYPE 'X" EXTERIOR RATED GWB FAF: FLUID APPLIED FLASHING FAWB: FLUID APPLIED WEATHER RESISTIVE BARRIER

FC: FIBER CEMENT SIDING

FEC: FIRE EXTINGUISHER

CABINET

FOIC: FURNISH BY OWNER INSTALL BY CONTRACTOR FOIO: FURNISH BY OWNER **INSTALL BY OWNER** GA: GAUGE **GALV: GALVANIZED** GC: GENERAL CONTRACTOR GFRGWB: GLASS FIBER **REINFORCED GWB** (5/8" TYPE "X" DENSGLASS OR EQUAL) GLS: GLASS GWB: GYPSUM WALL BOARD HR: HAND RAIL (AT STAIRS. PER CURRENT CODE) MANUF: MANUFACTURER MECH: MECHANICAL MTL: METAL (N): NEW O.D.: OUTSIDE DIAMETER I.D.: INSIDE DIAMETER NTS: NOT TO SCALE NIC: NOT IN CONTRACT PL: PROPERTY LINE PLMBG: PLUMBING POLYISO: POLYISOCYANURATE

PSI: POUNDS PER SQUARE

REQD: REQUIRED

FF: FINISH FLOOR

FIN: FINISH

(INSUL)

FOOT

INCH

OVERFLOW WHERE REQD) R.O.: ROUGH OPENING (IN FRAMING) REF: REFERENCE SAM: SELF ADHERED **MEMBRANE** (BUTYL BACKED ADHESIVE IS REQUIRED) SF: SQUARE FEET (OR FOOT) SFTY: SAFETY SGD: SLIDING GLASS DOORS SIM: SIMILAR SPEC: SPECIFICATIONS SUSP: SUSPENDED STD: STANDARD STL: STEEL SS: STAINLESS STEEL SUSP: SUSPENDED MECHANICAL/ELECTRICAL/PLUMBINGSTRUCT: STRUCTURAL SUB: SUB-CONTRACTOR TBD: TO BE DETERMINED T&G: TONGUE AND GROOVE TS: TEMPERED SAFETY (GLASS) TYP: TYPICAL WD: WOOD WOCD: WINDOW OPERATION CONTROL DEVICE (LIMITS WINDOW OPENING TO 4" MAXIMUM) PSF:POUNDS PER SQUARE VCT: VINYL COMPOSITION TILE VIF: VERIFY IN FIELD

WRB: WEATHER RESISTIVE

BARRIER

RD: ROOF DRAIN (WITH

## **GENERAL NOTES**

- 1. THE INTENT OF THE DRAWINGS AND SPECIFICATIONS IS TO PROVIDE FOR A WATERTIGHT AND WEATHER TIGHT BUILDING. THE GENERAL CONTRACTOR (GC) SHALL REVIEW ALL DETAILS RELATING TO THIS INTENT AND BY BIDDING OR ENTERING INTO THIS CONSTRUCTION CONTRACT, WARRANTS FOR ONE FULL YEAR THE ADEQUACY OF THESE DETAILS. SHOULD THE GC TAKE EXCEPTION TO THESE DETAILS, THEY SHALL NOTIFY ABB (ALLANA BUICK AND BERS) PRIOR TO BIDDING. ANY DEVIATION FROM THIS GENERAL INTENT SHOULD BE BROUGHT TO THE ATTENTION OF THE DESIGN PROFESSIONAL FOR CLARIFICATION.
- 2. THE BUILDING SHALL BE CONSTRUCTED IN FULL COMPLIANCE WITH ALL APPLICABLE CODES. ORDINANCES AND REGULATIONS AS WELL AS THE DRAWINGS AND SPECIFICATIONS. ANY CODE DEFICIENCIES IN THE DRAWINGS RECOGNIZED BY THE GC SHALL BE BROUGHT TO THE ATTENTION OF ABB FOR CLARIFICATION.
- 3. THE GC SHALL BE RESPONSIBLE FOR THE ACCURATE CONSTRUCTION AND VERIFY ALL DIMENSIONS AND EXISTING CONDITIONS. QUANTITY TAKE OFFS AND DIMENSIONS FOR WINDOWS, DOORS AND ALL MATERIALS INSTALLED ON SITE ARE RESPONSIBILITY OF THE GC. DISCREPANCIES BETWEEN DRAWINGS AND ACTUAL SITE CONDITIONS SHALL BE BROUGHT TO THE ATTENTION OF ABB BEFORE BIDDING THE PROJECT OR THE COMMENCEMENT OF THE WORK. THE OWNER SHALL NOT BE RESPONSIBLE FOR CHANGES TO THE WORK DUE TO THE FAILURE OF THE GENERAL CONTRACTOR TO FAMILIARIZE THEMSELVES WITH THE EXISTING CONDITIONS.
- 4. DO NOT SCALE DRAWINGS; ALL DIMENSIONS SHALL HAVE PREFERENCE OVER SCALE AND SHALL BE FIELD VERIFIED AND COORDINATED WITH WORK OF ALL TRADES. IF NO DIMENSIONS ARE GIVEN OR DISCREPANCIES FOUND, THE CONTRACTOR SHALL NOTIFY ABB FOR CLARIFICATION BEFORE BIDDING OR COMMENCING WITH THE WORK.
- 5. DETAILS ARE INTENDED TO SHOW METHOD AND MANNER OF ACCOMPLISHING WORK. MINOR MODIFICATIONS MAY BE REQUIRED TO SUIT JOB DIMENSIONS OR CONDITIONS. ALL INCLUDED AS PART OF
- 6. ABB SHALL SUBMIT AND PICK UP PERMIT DOCUMENTS AT OWNERS EXPENSE. CONTRACTOR SHALL CALL FOR REQUIRED INSPECTIONS NECESSARY FOR THE PROPER EXECUTION OF THE WORK IN ACCORDANCE WITH APPLICABLE CODES AND GOVERNING AUTHORITY
- 7. GC SHALL PROTECT ALL EXISTING BUILDINGS AND TREES TO REMAIN THROUGHOUT CONSTRUCTION OF THIS PROJECT. GC SHALL PROMPTLY REPAIR ANY DAMAGE AT NO ADDITIONAL COST TO THE OWNER.
- 8. GC SHALL REMOVE DEBRIS FROM PROJECT SITE ON A DAILY BASIS. DISPOSE OF ALL ITEMS IN ACCORDANCE WITH APPLICABLE LOCAL, STATE AND FEDERAL STANDARDS OR REQUIREMENTS
- 9. GC SHALL SCHEDULE AND COMPLETE THEIR WORK SO AS TO KEEP MECHANICAL, ELECTRICAL TELEPHONE, DATA, HVAC CONTROLS, INTERCOM, FIRE PROTECTION AND OTHER EXISTING SYSTEMS OPERATIONAL. ANY DISRUPTION TO SYSTEMS REQUIRES A MINIMUM OF SEVENTY TWO (72) HOUR NOTIFICATION TO THE OWNER AND TENANTS. WORK REQUIRING LOUD NOISE OR VIBRATION SHALL ALSO BE COORDINATED IN A SIMILAR MANNER.
- 10. THESE DRAWINGS DESCRIBE GENERAL REQUIREMENTS FOR WEATHERIZATION DETAILS. REFER TO ABB DRAWINGS FOR CLADDING TYPES, COLORS, WALL ASSEMBLIES, AND THERMAL RESISTANCE VALUES REQUIRED.
- 11. GENERAL NOTES LISTED ON THIS PAGE ARE NOT INTENDED TO BE AT THE EXCLUSION OF NOTES LISTED ELSEWHERE; THIS DOCUMENT SET IS MEANT TO BE COMPLIMENTARY, AND NOTES LISTED ON OTHER SHEETS, ON SPECIFICATIONS AND MANUFACTURERS RECOMMENDATION SHALL HAVE BEARING/APPLICATION TO WORK SHOWN ON THIS SHEET. SHOULD A DISCREPANCY OCCUR BIDDER CONTRACTOR SHALL UTILIZE THE MORE STRINGENT CONDITION.
- 12. THERE ARE SPECIFICATIONS BOUND SEPARATELY FROM THE CONSTRUCTION DRAWINGS THAT ARE A PART OF THE CONTRACT. THE SPECIFICATIONS AND DRAWINGS ARE COMPLIMENTARY TO ONE ANOTHER AND ARE BOTH REQUIRED TO FULLY DESCRIBE THE GC'S RESPONSIBILITIES UNDER THE CONTRACT. THE DRAWINGS TYPICALLY INDICATE SIZE, FORM, RELATIONSHIP AND GENERIC TYPE; THE SPECIFICATIONS TYPICALLY DEFINE THE QUALITATIVE REQUIREMENTS FOR PRODUCTS, MATERIALS, AND WORKMANSHIP. WHAT IS CALLED FOR BY EITHER ONE SHALL BE AS BINDING AS IF CALLED FOR BY ALL
- 13. ALL NOTES DESCRIBING COMPONENTS, SYSTEMS, OR CONSTRUCTION NOT NOTED AS "(E)" OR "EXISTING" ARE NEW, AND ARE REQUIRED TO BE PROVIDED AND INSTALLED IN ACCORDANCE WITH THE CONTRACT DOCUMENTS.  $\sim$
- 14. GENERAL CONTRACTOR TO PROVIDE TEMPORARY OVERHEAD PROTECTION FOR PEDESTRIAN WHERE WORK IS OCCURRING.

## WATERPROOFING NOTES

- 1. FLASHINGS SHALL BE INSTALLED IN SUCH A MANNER SO AS TO PREVENT MOISTURE FROM ENTERING THE WALL OR TO REDIRECT IT TO THE EXTERIOR, FLASHING MATERIALS SHALL BE TYPICALLY 24 GAUGE PRE-FINISHED KYNAR COATED GALVANIZED METAL, UNLESS NOTED AS OTHERWISE ON DRAWINGS.
- 2. WALL PENETRATIONS SHALL BE TARGET FLASHED.
- 3. WEATHER RESISTIVE BARRIERS (WRB) SHALL HAVE POSITIVE LAPPING (SHINGLE STYLE) WHEN INSTALLED. LAPPING AND SEALING OF SEAMS AND JOINTS SHALL BE BY MANUFACTURER'S REQUIREMENTS. LAP WEATHER RESISTANT BARRIER OVER VERTICAL FLASHING A MIN OF 4". UNLESS NOTED OTHERWISE.
- 4. BUILDING INTERFACES SHALL BE FLASHED TO PREVENT MOISTURE FROM ENTERING THE WALL.
- 5. HARDSCAPE SURFACES SHALL HAVE ADEQUATE SLOPING FOR DRAINAGE.
- 6. REFER TO MATERIAL DATA SHEETS AND MANUFACTURER'S INSTRUCTIONS BEFORE INSTALLING MATERIALS
- 7. PROVIDE FOLLOWING CLEARANCES TYPICALLY:
  - A) 2" MIN CLEAR @ ALL CLADDING TO HORIZONTAL HARD SURFACES
- 6" MIN CLEAR @ ALL CLADDING TO FINISH GRADE
- 9. EXPOSED FASTENERS SHALL BE SEALED OR HAVE INTEGRAL RUBBER GASKETS. INSTALL & LOCATE FASTENERS PER S.M.A.C.N.A.
- 10. HEM METAL FLASHING DRIP EDGES, TYPICAL. PROVIDE FULLY SOLDERED JOINTS IN SECTIONS OF FLASHING JOINED TOGETHER AS INDICATED ON DRAWINGS
- 11.PROVIDE GALVANIC SEPARATION MATERIAL BETWEEN DISSIMILAR METALS. 12. NOTIFY THE DESIGN PROFESSIONAL AND/OR CONSTRUCTION MANAGER OF ANY PREVIOUSLY
- UNDISCOVERED DAMAGE, DEFICIENCIES OR THREATS THAT COMPROMISE THE FIRE AND/OR LIFE SAFETY OF THE BUILDING OCCUPANTS. 13. ALL SEALANT WORK SHALL BE IN ACCORDANCE WITH THE SWRI AND THE SEALANT MATERIAL
- MANUFACTURER. REQUIREMENTS SHOWN IN THE CONSTRUCTION DOCUMENTS ARE ABOVE AND BEYOND THAT REQUIRED BY THE REFERENCED STANDARDS. IF CONFLICTS SHOULD OCCUR BETWEEN STANDARDS AND/OR THE CONSTRUCTION DOCUMENTS, UTILIZE THE HIGHEST QUALITY OR MORE STRINGENT REQUIREMENT.
- 14. ROOFING WORK SHALL BE IN ACCORDANCE WITH NRCA, SMACNA, AND THE ROOFING MATERIAL MANUFACTURER. REQUIREMENTS SHOWN IN THE CONSTRUCTION DOCUMENTS ARE ABOVE AND BEYOND THAT REQUIRED BY THE REFERENCED STANDARDS. SHOULD CONFLICTS OCCUR BETWEEN THE REFERENCED STANDARDS AND/OR THE CONSTRUCTION DOCUMENTS, UTILIZE THE HIGHEST QUALITY OR MORE STRINGENT REQUIREMENT. (ONLY USE WHERE ROOFING WORK IS APPLICABLE)

## **MOCK UPS**

- 1. MATERIALS TO BE USED FOR MOCK-UP MUST BE SUBMITTED FOR REVIEW AND APPROVAL BY ABB BEFORE
- 2. MOCK-UP REVIEW SHALL CONSIST OF A STEP BY STEP INSTALLATION SEQUENCING DONE ON SITE IN AN AREA SELECTED BY ABB.
- 3. IN-PLACE MOCK-UPS MUST BE PERFORMED BY PERSONNEL WHO WILL BE PROVIDING THE ACTUAL INSTALLATION.
- 4. CONTACT ABB 48 HOURS PRIOR TO SCHEDULE MOCK UPS AND TESTING. MOCK UP AND TESTING SHALL BE INCLUDED IN CONTRACTORS OVERALL CONSTRUCTION SCHEDULE
- 5. THIS LIST MAY NOT INCLUDE ALL ITEMS REQUIRING MOCK UP REVIEW. ADDITIONAL MOCK UPS AND/OR WATER TESTING MAY BE REQUESTED AS REQUIRED BY ABB:
  - PROPOSED NEW EXTERIOR WALL AND ROOF ASSEMBLIES AND PENETRATIONS

  - PROPOSED ROOF ASSEMBLIES AND CONNECTIONS TO WALLS
  - DRAIN CONNECTIONS
  - EXTERIOR DOORS
  - CANOPIES

#### INDEX TO DRAWINGS

#### ABB ARCHITECTURE DRAWINGS

- COVER SHEET
- SITE PLAN AND CODES
- PHOTO SHEET #1
- A0.4 PHOTO SHEET #2
- A0.5 PHOTO SHEET #3 A0.6 PHOTO SHEET #4
- 3RD FLOOR PLAN EXISTING
- 4TH FLOOR & ROOF DEMOLITION PLAN UPPER ROOF DEMOLITION PLAN
- **EXISTING ELEVATIONS**
- **DEMOLITION 4TH FLOOR JAIL ELEVATIONS DEMOLITION 4TH FLOOR JAIL SECTIONS**
- A2.1 4TH FLOOR AND ROOF PLAN / DOOR
- **SCHEDULE**
- UPPER ROOF PLAN
- MECHANICAL ROOM ELEVATIONS STAIR AND ELEVATOR TOWER
- **ELEVATIONS**
- PROPOSED CROSS AND LONG SECTIONS

#### WATERPROOFING DRAWINGS

- W100 ROOF AND WALL ASSEMBLIES
- W201 DEIFS WALL DETAILS
- W202 DEIFS WALL DETAILS W203 DEIFS WALL DETAILS
- W204 DEIFS WALL DETAILS
- W205 DEIFS WALL DETAILS
- W301 WINDOW, DOOR, LOUVER DETAILS W401 ROOF DETAILS

- W402 ROOF DETAILS
- W403 ROOF & CANOPY DETAILS
- W404 ROOF & CANOPY DETAILS

#### **PSE STRUCTURAL DRAWINGS:**


- **GENERAL NOTES & DESIGN CRITERIA**
- PROPOSED ROOF LAYOUT
- PARAPET BRACE DETAILS
- CFS WALL DETAILS STRUCTURAL DETAILS
- DEMO PLAN AND LOAD MAP

#### INTERFACE MEP DRAWINGS:

- SYMBOL LIST AND GENERAL NOTES -
- P1.1 4TH FLOOR AND ROOF DEMO PLAN -
- **PLUMBING**
- 4TH FLOOR AND ROOF PLAN PLUMBING
- SYMBOL LIST AND GENERAL NOTES -
- **MECHANICAL**
- 4TH FLOOR AND ROOF DEMO PLAN -
- **MECHANICAL** 4TH FLOOR AND ROOF PLAN -
- SYMBOL LIST AND GENERAL NOTES -
- **ELECTRICAL**

**MECHANICAL** 

- LUMINARIES SCHEDULE 4TH FLOOR AND ROOF DEMO PLAN -
- **ELECTRICAL** 4TH FLOOR AND ROOF PLAN - ELECTRICAL

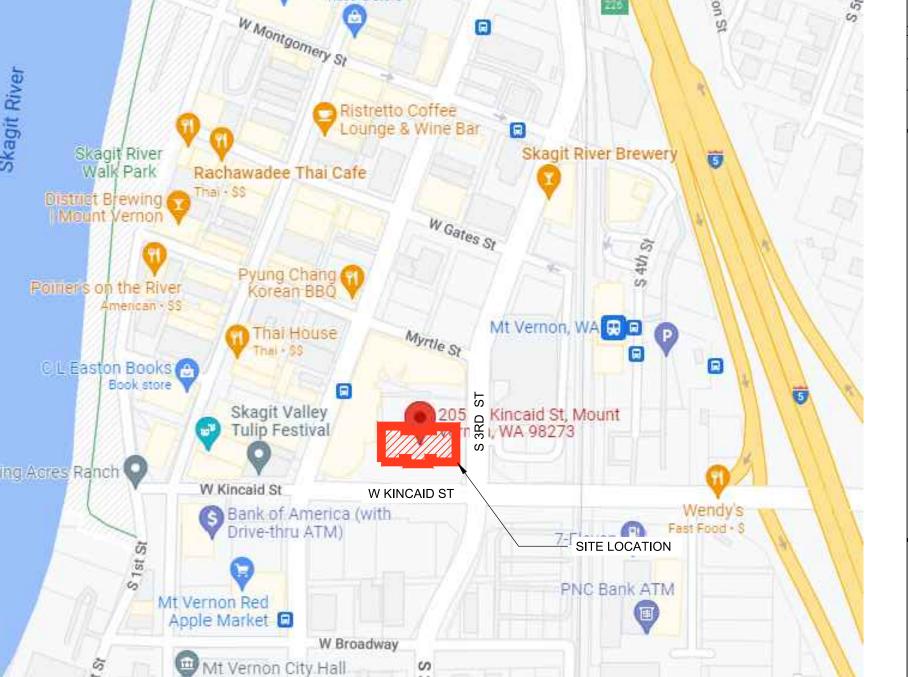






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**ABB Project** # 22-7763.01

Skagit County Facilities **Project # 3809** Skagit County Superior Court Rooftop Jailhouse Removal OWNER NAME / ADDRESS:

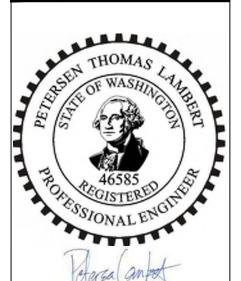Skagit County, a Municipal Corporation 1800 Continental Place Mount Vernon, WA 98273 PROPERTY ADDRESS: 205 W. Kincaid Street

Mount Vernon, WA 98273 PROPERTY MANAGER: Skagit County Facilities Management

1800 Continental Place Mount Vernon, WA 98273 Contact: Ken Hansen

Description Date CONSTRUCTION PLANS 03/20/23 (REVISED) BID SET ISSUE |PERMIT CORRECTION| 06/21/23 ∐BID SET BID SET ISSUE


> CITY OF MOUNT VERNON **PERMIT NUMBER** BLDG23-0137

SHEET TITLE

**COVER SHEET** 

SCALE: NOTED ON DRAWINGS

**A0.1** 

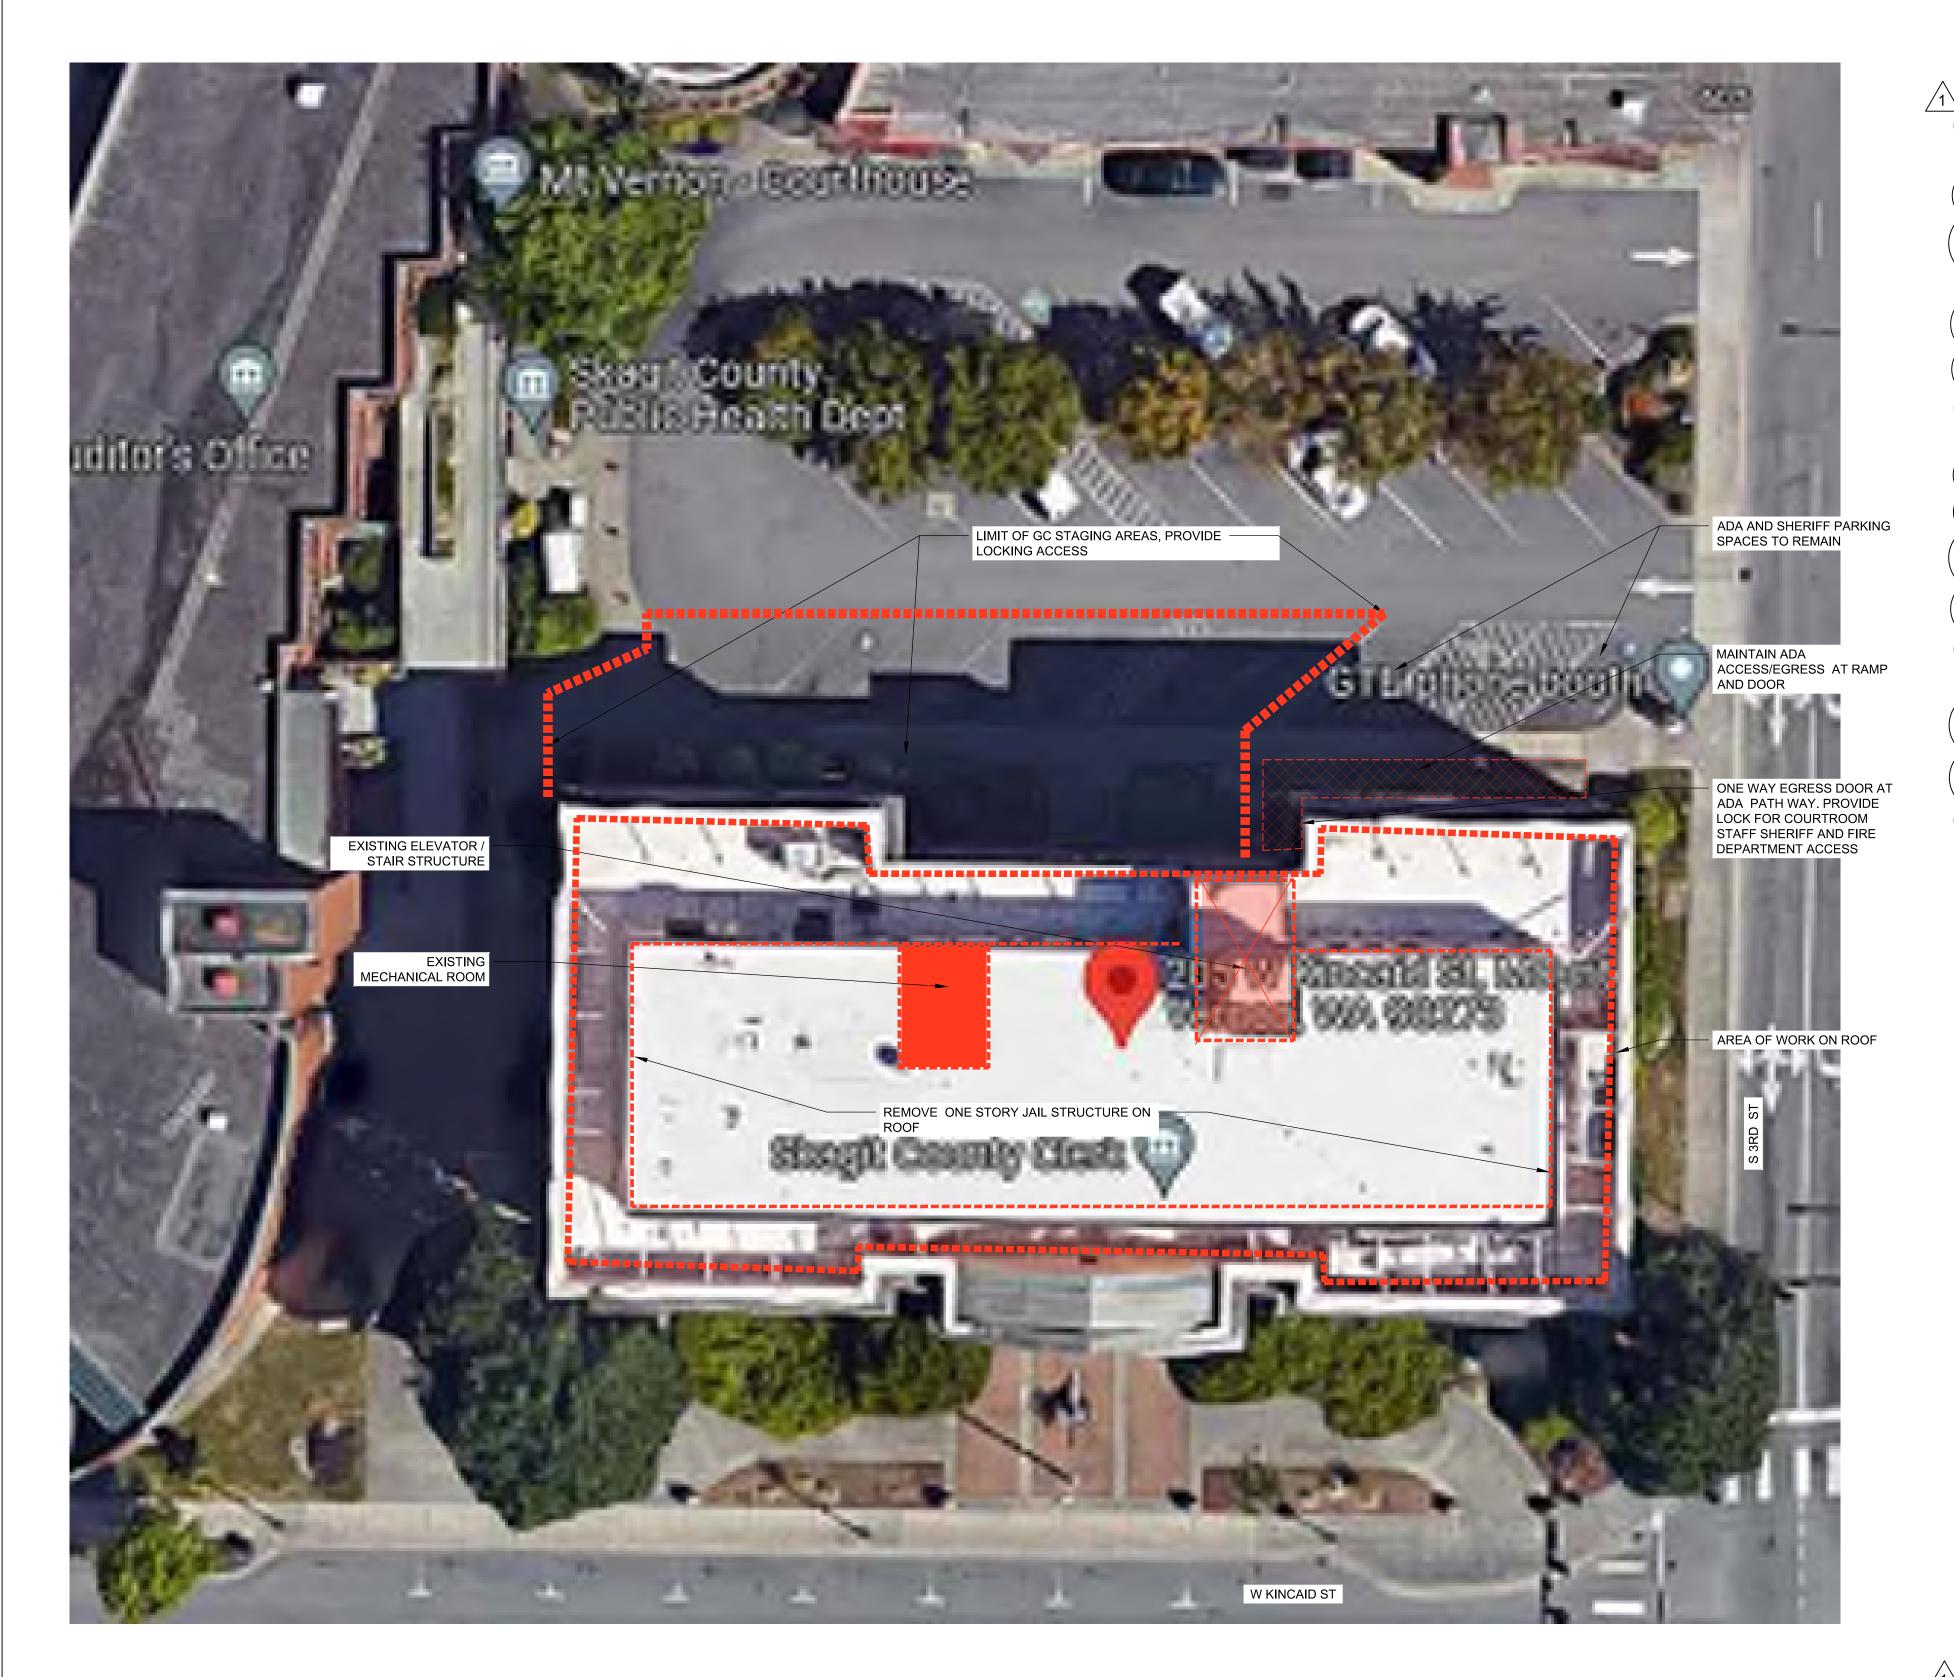

## north Site Plan not to scale

## **CODE COMPLIANCE**

2021 INTERNATIONAL EXISTING BUILDING CODE (IEBC)

THERE IS NO CHANGE IN OCCUPANCY NOR ANY ADDITION TO THE EXISTING FOOTPRINT FOR THIS ROOF TOP JAIL DEMOLITION, MECHANICAL ROOM REPLACEMENT, ROOFTOP ACCESS HALL REPLACEMENT, AND ROOF REPLACEMENT PROJECT.

PROJECT APPEARS TO CONFORM TO FOLLOWING SECTIONS OF THE IEBC:

CHAPTER 8 - ALTERATIONS LEVEL 2 (PRIMARY) AND CHAPTER 7 - ALTERATIONS LEVEL 1 (WHERE APPLICABLE):

- **801.2 COMPLIANCE:** IN ADDITION TO THE REQUIREMENTS OF THIS CHAPTER, ALL WORK SHALL COMPLY WITH THE REQUIREMENTS OF CHAPTER 7.
- <u>701.2 CONFORMANCE:</u> THE EXISTING BUILDING SHALL NOT BE ALTERED SUCH THAT THE BUILDING BECOMES LESS SAFE THAN ITS EXISTING CONDITION.
- 803 FIRE PROTECTION:
- ALTERATION SHALL BE DONE THAT MAINTAINS THE LEVEL OF FIRE PROTECTION PROVIDED.
   804.1 MEANS OF EGRESS: ALTERATIONS DONE TO THIS PROJECT WILL MAINTAIN THE LEVEL
- OF PROTECTION PROVIDED FOR THE EXISTING MEANS OF EGRESS.
- 705 REROOFING:
- **705.1 GENERAL:**MATERIALS AND METHOD SHALL COMPLY WITH CHAPTER 15 OF THE INTERNATIONAL BUILDING CODE.
- 705.2 ROOF REPLACEMENT:
- ROOF REPLACEMENT SHALL INCLUDE THE REMOVAL OF ALL EXISTING LAYERS OF ROOF COVERINGS TO THE ROOF DECK.
- **705.2 FLASHINGS**:FLASHINGS SHALL BE RECONSTRUCTED IN ACCORDANCE WITH APPROVED MANUFACTURER'S INSTRUCTIONS.
- 805 STRUCTURAL:

805.2 ADDITION OR REPLACEMENT OF ROOFING OR REPLACEMENT OF EQUIPMENT: ANY EXISTING GRAVITY LOAD-CARRYING STRUCTURAL ELEMENT FOR WHICH AN ALTERATION CAUSES AN INCREASE IN DESIGN DEAD, SNOW LOAD.. OF MORE THAN 5% SHALL BE REPLACED OR ALTERED AS NEEDED TO CARRY THE GRAVITY LOADS REQUIRED BY THE INTERNATIONAL BUILDING CODE FOR NEW STRUCTURES.

<u>COMMENT</u>: THIS PROJECT REDUCES DESIGN LOADS BY REMOVING 90% OF EXISTING CONCRETE JAILHOUSE STRUCTURE ON THE ROOF. ALTERATION OF ROOF STRUCTURE IS NOT REQUIRED.

- **807 MECHANICAL:** ALTERATIONS TO THIS PROJECT WILL MAINTAIN THE EXISTING LEVEL OF MECHANICAL SYSTEMS FOR THE REMAINING AND UNALTERED FLOORS 1-3.
- MECHANICAL SYSTEMS FOR THE REMAINING AND UNALTERED FLOORS 1-3. 809 ENERGY CONSERVATION:

809.1 LEVEL 2 ALTERATIONS TO EXISTING BUILDINGS ARE PERMITTED WITHOUT REQUIRING THE ENTIRE BUILDING TO COMPLY WITH THE ENERGY REQUIREMENTS O F THE INTERNATIONAL ENERGY CONSERVATION CODES.

REPLACEMENT WINDOWS WILL MEET WASHINGTON STATE ENERGY CODE REQUIREMENTS (U = .30 MAX TYPICALLY)

## **ENERGY CODE COMPLIANCE**

**W2018 WASHINGTON STATE ENERGY CODE (WSEC):** 

#### C503 ALTERATIONS:

C503.1 GEMERAL: ALTERATIONS TO ...BUILDING SHALL COMPLY WITH SECTION C503 AND CODES FOR NEW CONSTRUCTION. ALTERATION TO AN EXISTING BUILDING...SHALL CONFORM TO THE PROVISIONS OF THIS CODE AS THEY RELATE TO NEW CONSTRUCTION WITHOUT REQUIRING THE UNALTERED PORTIONS OF THE EXISTING BUILDING TO COMPLY WITH THIS CODE. ALTERATIONS SHALL BE SUCH THAT THE EXISTING BUILDING ... IS NO LESS CONFORMING TO THE PROVISIONS OF THIS CODE THAN THE EXISTING BUILDING ... WAS PRIOR TO THE ALTERATION.

EXCEPTIONS USED: 7. REPLACEMENT OF EXISTING DOORS TO OUTSIDE.

C503.3 BUILDING ENVELOPE (AIR LEAKAGE TESTING) IS NOT REQUIRED PER EXCEPTION:
EXCEPTION: AIR LEAKAGE TESTING IS NOT REQUIRED FOR ALTERATIONS AND REPAIRS,
UNLESS THE PROJECT INCLUDES A CHANGE IN SPACE CONDITIONING PER C503.2 OR A
CHANGE IN OCCUPANCY.

TABLE C402.1.3: MINIMUM THERMAL REQUIREMENTS:

ROOFS:

INSULATION ENTIRELY ABOVE DECK: R-38 C.I. WALLS:

STEEL FRAMED: R-13 + R13 C.I.

#### **FIRE CODE NOTES:**

PER REQUEST OF FIRE MARSHALL, WORK WILL INCLUDE RELOCATION OF (2) EXISTING CLASS 2 STANDPIPES. CONTRACTOR SHALL OBTAIN NECESSARY PERMITS FOR SUCH WORK.

BUILDING IS EQUIPPED WITH AN EXISTING FIRE PROTECTION SYSTEM. NO CHANGES TO EXISTING SYSTEM ARE ANTICIPATED.

GENERAL CONTRACTOR IS RESPONSIBLE FOR NOTIFYING FIRE DEPARTMENT IF FIRE ALARM SYSTEM REQUIRES TEMPORARY SHUT OFF OR RELOCATION TO PERFORM REPAIR WORK.

## **DEFERRED SUBMITTAL:**


FOR THE FOLLOWING WORK, CONTRACTOR SHALL SUBMIT TO THE BUILDING INSPECTOR DRAWINGS AND CALCULATIONS STAMPED AND SIGNED BY A WASHINGTON STATE LICENSED STRUCTURAL ENGINEER:

- 1. BIDDER DESIGN STEEL CANOPY WITH KNIFE PLATE ATTACHMENT TO STRUCTURE.
- 2. MODIFICATION TO FIRE SPRINKLER, STAND PIPE AND FIRE PUMPS.



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Potersa Campat

ABB Project # 22-7763.01 Skagit County Facilities Project # 3809

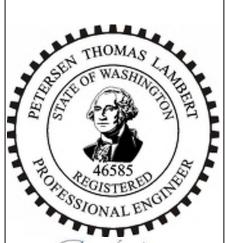Skagit County Superior Court Rooftop Jailhouse Removal OWNER NAME / ADDRESS: Skagit County, a Municipal Corporation 1800 Continental Place Mount Vernon, WA 98273 PROPERTY ADDRESS: 205 W. Kincaid Street Mount Vernon, WA 98273 PROPERTY MANAGER: Skagit County Facilities Management 1800 Continental Place Mount Vernon, WA 98273 Contact: Ken Hansen

Cont	act: Ken Hansen	
Mark	Description	Date
	CONSTRUCTION PLANS (REVISED)	03/20/2
	BID SET ISSUE	04/24/2
1	PERMIT CORRECTION BID SET	06/21/2
	BID SET ISSUE	09/25/2


CITY OF MOUNT VERNON PERMIT NUMBER BLDG23-0137

SHEET TITLE

SITE PLAN AND CODES

SCALE: NOTED ON DRAWINGS

A0.2

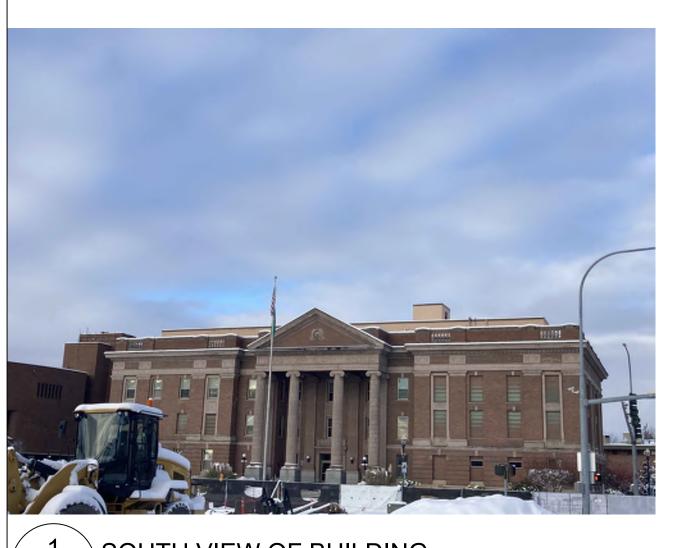


SOUTH VIEW OF BUILDING



RECEIVING ROOM NOT TO SCALE



PROVIDE STRUCTURE TO SUPPORT COOLING **TOWER** 

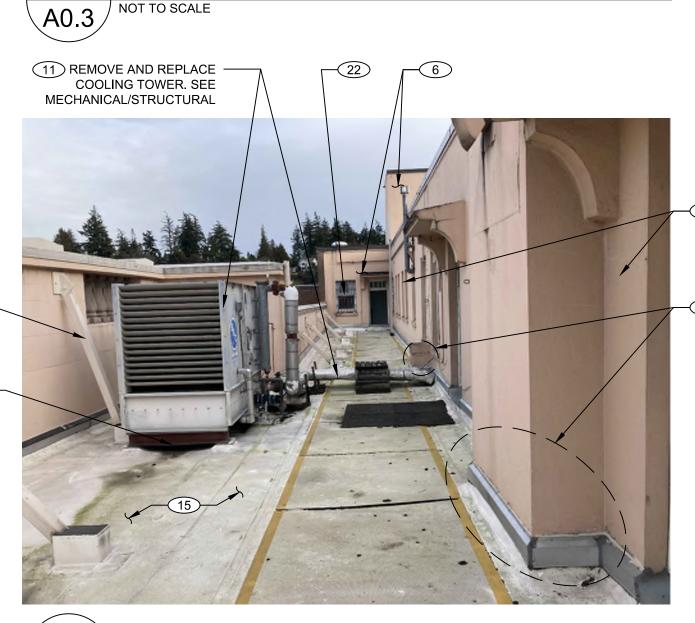

NORTH VIEW OF BUILDING

RECEIVING ROOM

WALL REMOVED, SEE -

RELOCATION

ELECTRICAL FOR PANEL

NOT TO SCALE

NORTH PERIMETER WALK FACING EAST NOT TO SCALE \A0.3



ACCESS TO ELEVATOR


STAIR INTERIOR NOT TO SCALE



SOUTH EAST PARKING



COOLING PIPES INTO MECHANICAL ROOM NOT TO SCALE \A0.3/

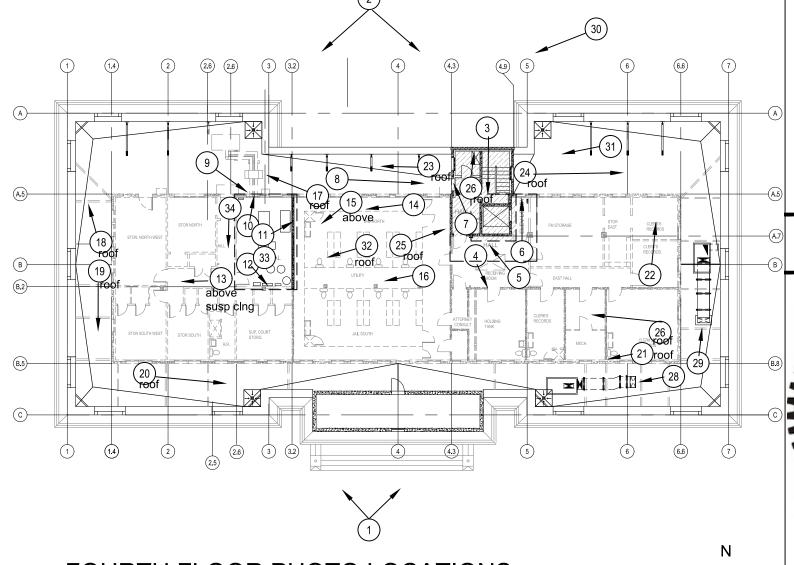

FOURTH FLOOR PHOTO LOCATIONS

NOT TO SCALE

**DEMOLITION KEY NOTES** - INDICATED WITH FOLLOWING TYPICAL TAGS: (#) NOT ALL LOCATIONS ARE TAGGED. TAGS INDICATED TYPICAL LOCATIONS. REFER ALSO TO WALL LEGEND ON DEMO PLAN

- 1. REMOVE EXTERIOR 5" CONCRETE WALLS WITH 4" TILE AT INTERIOR
- REMOVE INTERIOR 5" CONCRETE WALLS.
- REMOVE INTERIOR 4" TILE WALLS.
- REMOVE CONCRETE COLUMNS.
- RETAIN CONCRETE COLUMNS.
- RETAIN EXTERIOR WALLS. PREP FOR NEW FINISHES AND ASSEMBLIES PER WALL TYPES AND DETAILS, TYPICAL
- 7. RETAIN 5" CONCRETE WALLS. PROVIDE TEMPORARY SUPPORT AS **NEEDED**
- MECHANICAL WATER TANK AND BRACE SUPPORT TO REMAIN.
- REMOVE DOOR AND TRANSOM AND PREP OPENING FOR REPLACEMENT DOOR.
- 10. REMOVE AND SEAL OFF UNUSED SHAFTS TYPICAL.
- 11. REMOVE COOLING TOWER AND PIPING. PREP FOR REPLACEMENT -PER MECHANICAL.
- 12. REMOVE PLUMBING FIXTURES AND CAP WATER/WASTE LINES PER
- 13. REMOVE STEEL JAIL BARS, WALLS, CEILINGS, BEDS AND OTHER MATERIALS IN AREAS OF DEMOLITION. PROVIDE LEAD PAINT ABATEMENT PROCEDURES WHERE REQUIRED.
- 14. REMOVE DOORS. WINDOWS AND OTHER MATERIALS IN AREAS OF DEMOLITION. PROVIDE LEAD/ASBESTOS ABATEMENT WHERE REQUIRED.
- 15. REMOVE AND PREP FOR REPLACEMENT EXISTING 3RD FLOOR ROOF ASSEMBLY TO CONCRETE STRUCTURE. ALL ROOFING ACCESSORIES SHALL BE REMOVED/REPLACED.
- 16. REMOVE AND PREP FOR REPLACEMENT OF STEEL PARAPET BRACES WHERE ATTACHED TO JAIL WALLS. REFER TO STRUCTURAL DOCUMENTS FOR REPLACEMENT DETAILS.
- 17. RELOCATE CLASS 2 STANDPIPE-BY FIRE SPRINKLER SUB. RUN NEW PIPING UNDER NEW ROOF INSULATION, SEE SHEET A2.1.
- 18. PROVIDE TEMPORARY SUPPORT FOR ELECTRICAL PANELS AND CONDUITS DURING REMOVAL OF WALLS AND COLUMNS.
- 19. RETAIN ROOF STRUCTURES ABOVE IN THIS AREA. ALL OTHER ROOFS AND BEAMS TO BE REMOVED.
- 20. 4" ROOF DRAIN IN SUMP.
- 21. RETAIN WATER HEATER VENT DURING DEMOLITION.
- 22. AT STORAGE WINDOW OPENING, REMOVE EXTERIOR JAIL BARS, REMOVE WINDOW FRAME AND TRIMS. REMOVE LOUVER AND PREP FOR REPLACEMENT IN NEW FRAMING AND DEIFS PER ELEVATIONS AND SECTIONS.
- 23. REMOVE SHORT PARAPET BRACE AND PREP FOR REPLACEMENT PER STRUCTURAL.
- 24. PRIOR TO DEMOLITION, PROVIDE STEEL BRACES TO SUPPORT ELEVATOR OVERRUN CANTILEVER. SEE STRUCTURAL.
- 25. REMOVE WINDOW IN STAIR WELL. INSTALL NEW FRAMING, FIXED ALUMINUM STOREFRONT WINDOW IN DEIFS WALL ASSEMBLY. SEAL SPRINKLER DRAIN PIPE PER DETAILS.
- 26. WINDOW AT ELEVATOR OVERRUN TO REMAIN. SAND AND PAINT FRAME. INTEGRATE WITH NEW DEIFS TYPICAL.

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300 Elliot Ave. West, Suite 250 Seattle, WA 98119 206-443-6499



**ABB Project** # 22-7763.01 Skagit County Facilities **Project # 3809** 

Skagit County Superior Court Rooftop Jailhouse Removal OWNER NAME / ADDRESS: Skagit County, a Municipal Corporation 1800 Continental Place Mount Vernon, WA 98273 PROPERTY ADDRESS: 205 W. Kincaid Street Mount Vernon, WA 98273 PROPERTY MANAGER: Skagit County Facilities Management 1800 Continental Place Mount Vernon, WA 98273

CONSTRUCTION PLANS (REVISED)  BID SET ISSUE  PERMIT CORRECTION BID SET	Mark	Description
PERMIT CORRECTION		
/ 1 \ I		BID SET ISSUE
	1	
BID SET ISSUE		BID SET ISSUE

CITY OF MOUNT VERNON PERMIT NUMBER BLDG23-0137


SHEET TITLE

PHOTO SHEET#1

SCALE: NOTED ON DRAWINGS

A0.3




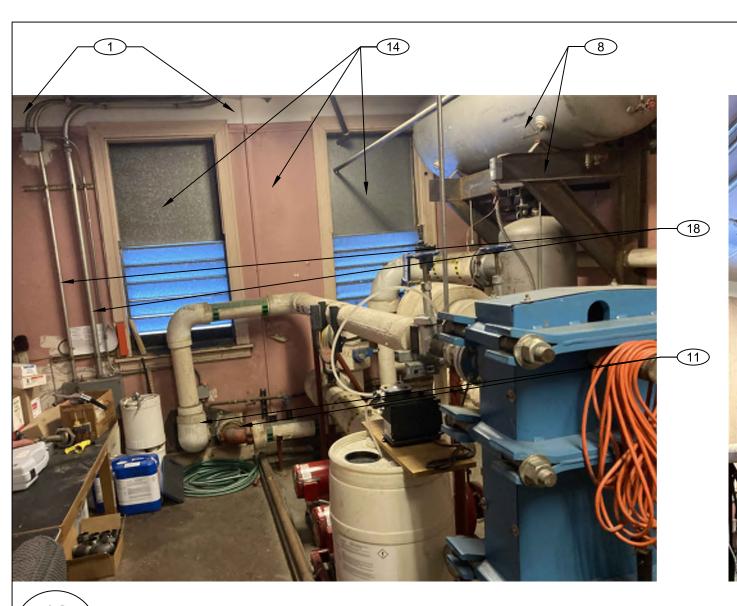


MECHANICAL ROOM FACING NORTH



MECHANICAL ROOM FACING EAST

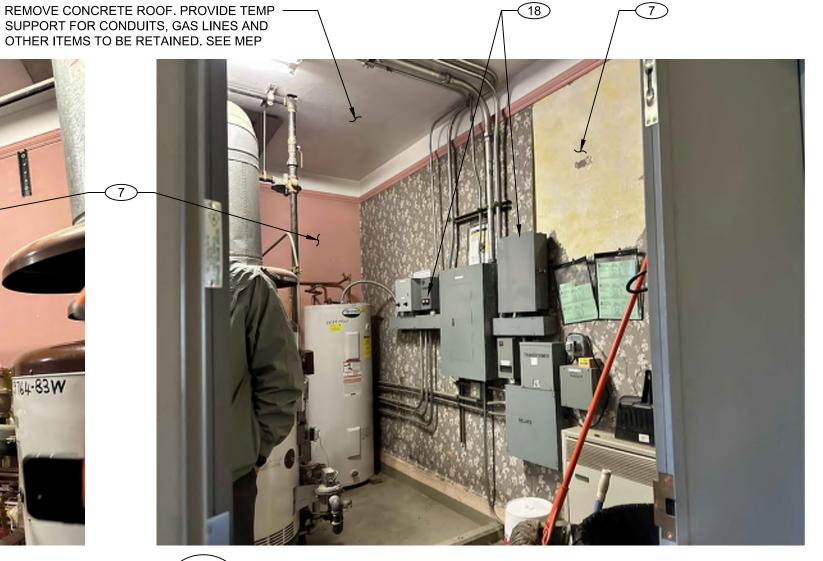

MECHANICAL ROOM FACING SOUTH

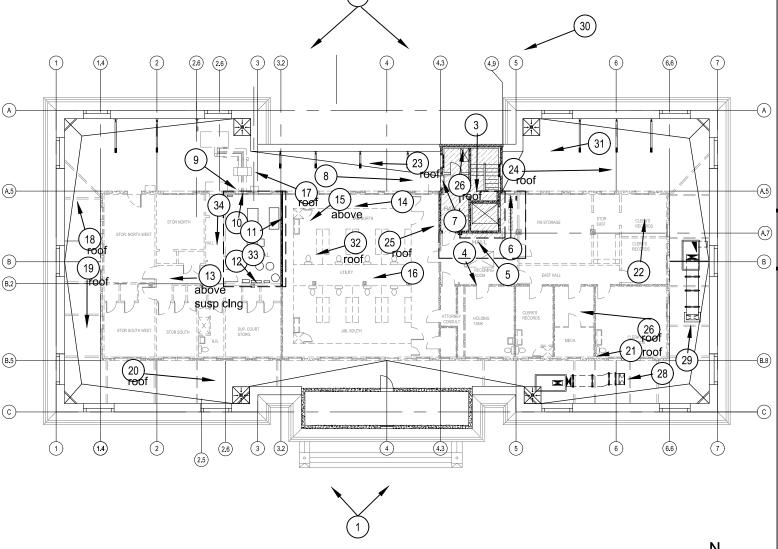

FOURTH FLOOR PHOTO LOCATIONS

NOT TO SCALE



ALLANA BUICK & BERS

300 Elliot Ave. West, Suite 250 Seattle, WA 98119 206-443-6499

# 22-7763.01 Skagit County Facilities

**Project # 3809** 

Skagit County Superior Court

Rooftop Jailhouse Removal OWNER NAME / ADDRESS:

a Municipal Corporation

Mount Vernon, WA 98273 PROPERTY ADDRESS:

Mount Vernon, WA 98273

1800 Continental Place

205 W. Kincaid Street

PROPERTY MANAGER:

Skagit County Facilities

1800 Continental Place

Contact: Ken Hansen

ackslash BID SET

Mount Vernon, WA 98273

Description

(REVISED)

**BID SET ISSUE** 

CONSTRUCTION PLANS 03/20/23

PERMIT CORRECTION 06/21/23

BID SET ISSUE 09/25/23

CITY OF MOUNT VERNON

PERMIT NUMBER

BLDG23-0137

Management

Skagit County,

**DEMOLITION KEY NOTES** - INDICATED WITH FOLLOWING TYPICAL TAGS: # NOT ALL LOCATIONS ARE TAGGED. TAGS INDICATED TYPICAL LOCATIONS. REFER ALSO TO WALL LEGEND ON DEMO PLAN


- 1. REMOVE EXTERIOR 5" CONCRETE WALLS WITH 4" TILE AT INTERIOR
- REMOVE INTERIOR 5" CONCRETE WALLS.
- REMOVE INTERIOR 4" TILE WALLS.
- REMOVE CONCRETE COLUMNS.
- RETAIN CONCRETE COLUMNS. RETAIN EXTERIOR WALLS. PREP FOR NEW FINISHES AND ASSEMBLIES PER WALL TYPES AND DETAILS, TYPICAL
- 7. RETAIN 5" CONCRETE WALLS. PROVIDE TEMPORARY SUPPORT AS
- MECHANICAL WATER TANK AND BRACE SUPPORT TO REMAIN. 9. REMOVE DOOR AND TRANSOM AND PREP OPENING FOR
- REPLACEMENT DOOR.
- 10. REMOVE AND SEAL OFF UNUSED SHAFTS TYPICAL.
- 11. REMOVE COOLING TOWER AND PIPING. PREP FOR REPLACEMENT -PER MECHANICAL.
- 12. REMOVE PLUMBING FIXTURES AND CAP WATER/WASTE LINES PER
- 13. REMOVE STEEL JAIL BARS, WALLS, CEILINGS, BEDS AND OTHER MATERIALS IN AREAS OF DEMOLITION. PROVIDE LEAD PAINT ABATEMENT PROCEDURES WHERE REQUIRED.
- 14. REMOVE DOORS, WINDOWS AND OTHER MATERIALS IN AREAS OF DEMOLITION. PROVIDE LEAD/ASBESTOS ABATEMENT WHERE REQUIRED. 15. REMOVE AND PREP FOR REPLACEMENT EXISTING 3RD FLOOR
- ROOF ASSEMBLY TO CONCRETE STRUCTURE. ALL ROOFING ACCESSORIES SHALL BE REMOVED/REPLACED. 16. REMOVE AND PREP FOR REPLACEMENT OF STEEL PARAPET

BRACES WHERE ATTACHED TO JAIL WALLS. REFER TO

- STRUCTURAL DOCUMENTS FOR REPLACEMENT DETAILS. 17. RELOCATE CLASS 2 STANDPIPE-BY FIRE SPRINKLER SUB. RUN NEW PIPING UNDER NEW ROOF INSULATION, SEE SHEET A2.1.
- 18. PROVIDE TEMPORARY SUPPORT FOR ELECTRICAL PANELS AND CONDUITS DURING REMOVAL OF WALLS AND COLUMNS.
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NOT TO SCALE A0.4



**COOLING TOWER NORTH** 

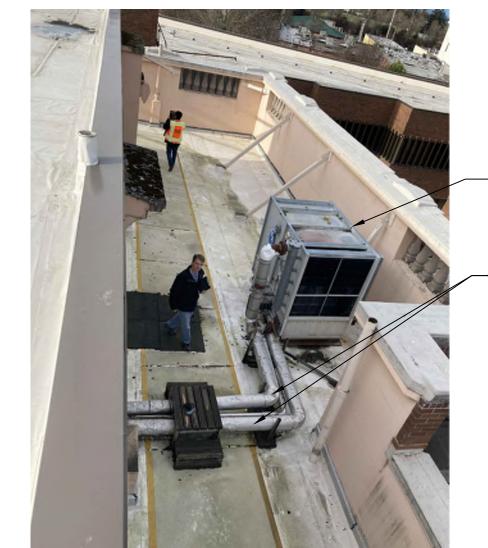


NOT TO SCALE A0.4

**JAIL INTERIOR** 

NOT TO SCALE

A0.4

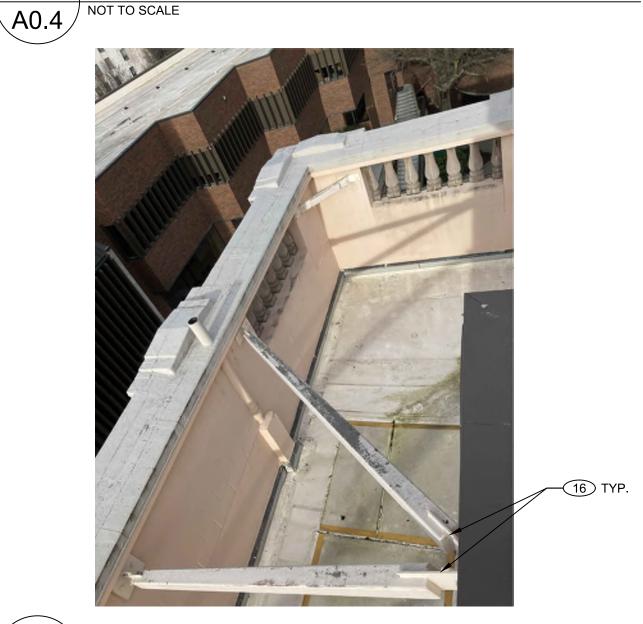

TOP OF JAIL ROOMS (STEEL PLATES)

PERIMETER WALKWAY NORTH WEST

NOT TO SCALE ∖A0.4 /

SHEET TITLE

PHOTO SHEET#2

SCALE: NOTED ON DRAWINGS

**A0.4** 

SHEET




CONC. BEAM ABOVE JAIL SUSP. CLNG.



TOP OF JAIL ROOMS (STEEL PLATES)

NOT TO SCALE

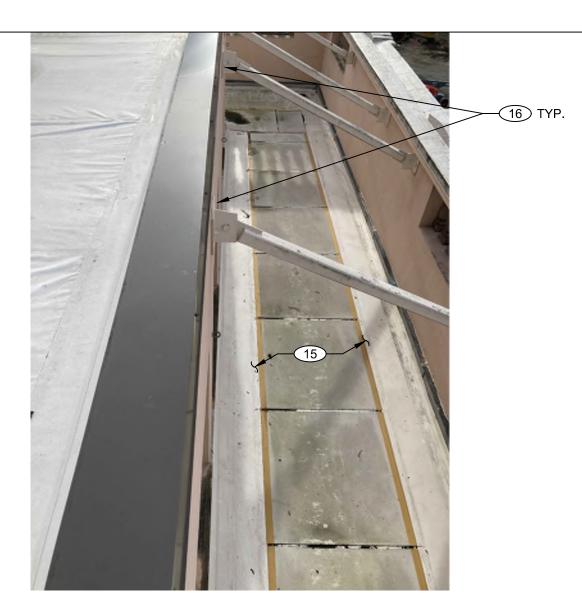

19 PERIMETER WALKWAY WEST FACING NORTH
A0.5 NOT TO SCALE




PERIMETER WALKWAY EAST (RTU-2)

A0.5 NOT TO SCALE




20 PERIMETER WALKWAY SOUTH

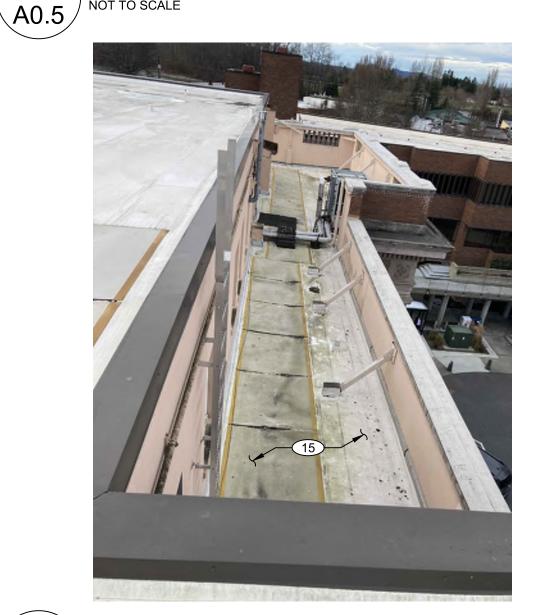

23 PERIMETER WALL NORTH FACING WEST A0.5 NOT TO SCALE



25 ELEVATOR TOWER FACING EAST

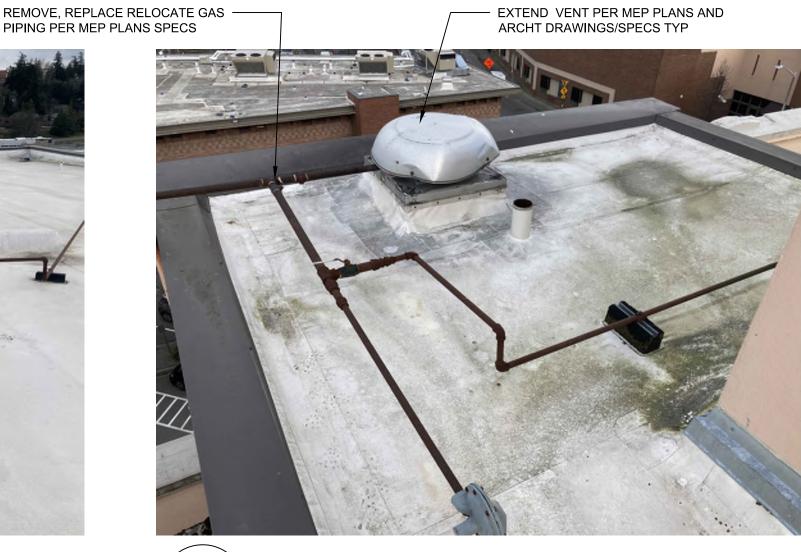


26 BASE OF ELEVATOR TOWER/STAIR ROOF
A0.5 NOT TO SCALE




21 PERIMETER WALKWAY SOUTH (RTU-1)



24 PERIMETER WALL NORTH FACING EAST

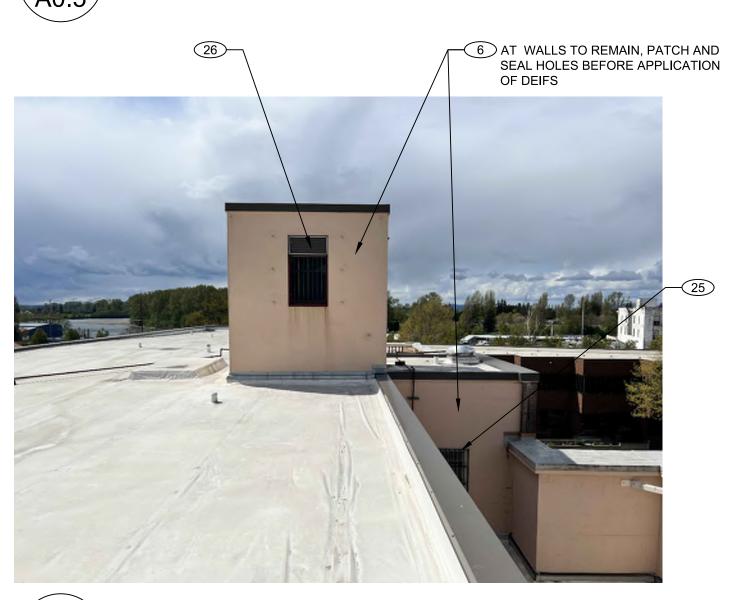

26 BASE OF ELEVATOR TOWER AND JAIL ROOF
A0.5 NOT TO SCALE

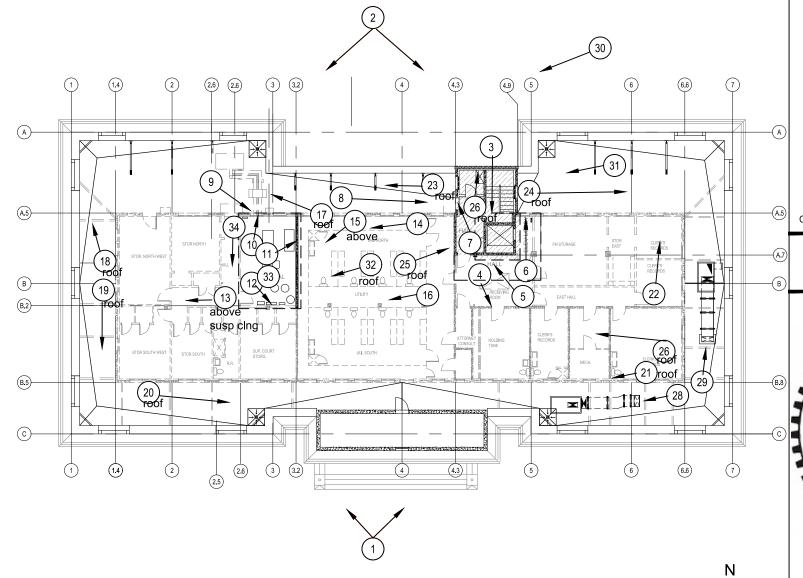

FOURTH FLOOR PHOTO LOCATIONS

NOT TO SCALE

HOTO LOCATIONS

W
S

E

<u>DEMOLITION KEY NOTES</u> - INDICATED WITH FOLLOWING TYPICAL TAGS: #
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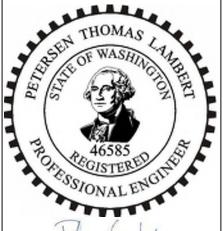
- 1. REMOVE EXTERIOR 5" CONCRETE WALLS WITH 4" TILE AT INTERIOR SIDE.
- 2. REMOVE INTERIOR 5" CONCRETE WALLS.
- 3. REMOVE INTERIOR 4" TILE WALLS.
- 4. REMOVE CONCRETE COLUMNS.
- 5. RETAIN CONCRETE COLUMNS.6. RETAIN EXTERIOR WALLS. PREP FOR NEW FINISHES AND
- ASSEMBLIES PER WALL TYPES AND DETAILS, TYPICAL

  7. RETAIN 5" CONCRETE WALLS. PROVIDE TEMPORARY SUPPORT AS NEEDED.
- 8. MECHANICAL WATER TANK AND BRACE SUPPORT TO REMAIN.
- 9. REMOVE DOOR AND TRANSOM AND PREP OPENING FOR REPLACEMENT DOOR.
- 10. REMOVE AND SEAL OFF UNUSED SHAFTS TYPICAL.
- 11. REMOVE COOLING TOWER AND PIPING. PREP FOR REPLACEMENT PER MECHANICAL.
- 12. REMOVE PLUMBING FIXTURES AND CAP WATER/WASTE LINES PER PLUMBING.
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- 20. 4" ROOF DRAIN IN SUMP.
- 21. RETAIN WATER HEATER VENT DURING DEMOLITION.
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Potersa Cantot

ABB Project # 22-7763.01 Skagit County Facilities Project # 3809

Skagit County Superior Court
Rooftop Jailhouse Removal

OWNER NAME / ADDRESS:
Skagit County,
a Municipal Corporation
1800 Continental Place
Mount Vernon, WA 98273

PROPERTY ADDRESS:
205 W. Kincaid Street
Mount Vernon, WA 98273

PROPERTY MANAGER:
Skagit County Facilities
Management
1800 Continental Place
Mount Vernon, WA 98273

Contact: Ken Hansen

Cont	act: Ken Hansen	
Mark	Description	Date
	CONSTRUCTION PLANS (REVISED)	03/20/2
	BID SET ISSUE	04/24/2
1	PERMIT CORRECTION BID SET	06/21/2
	BID SET ISSUE	09/25/2

CITY OF MOUNT VERNON PERMIT NUMBER BLDG23-0137

SHEET TITLE

PHOTO SHEET#3

SCALE: NOTED ON DRAWINGS

A0.5



27 ELEVATOR TOWER ROOF

A0.6 NOT TO SCALE



29A TYPICAL ROOF DRAIN

NOT TO SCALE

AREA OF MECHANICAL ROOM BELOW


32 JAIL ROOF FACING WEST



28 RTU 1 - SOUTH SIDE




30 NORTH BUILDING FACADE
A0.6 NOT TO SCALE

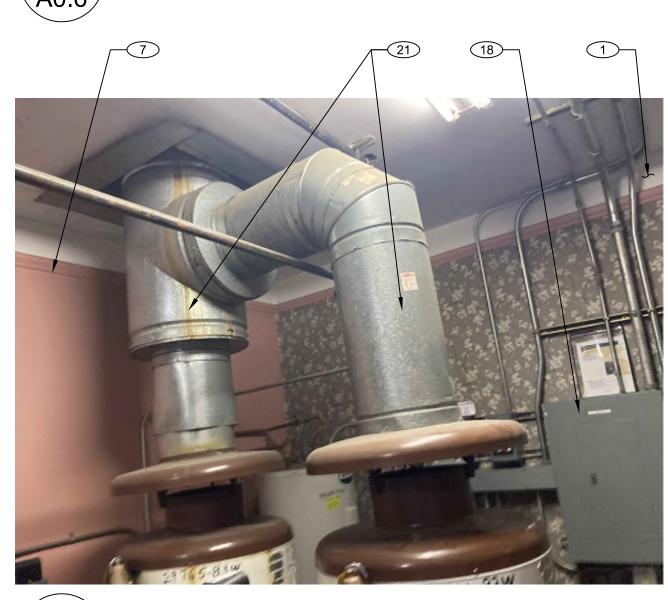

33 MECHANICAL ROOM WATER HEATER VENTING
A0.6 NOT TO SCALE




29 RTU 2 - EAST SIDE

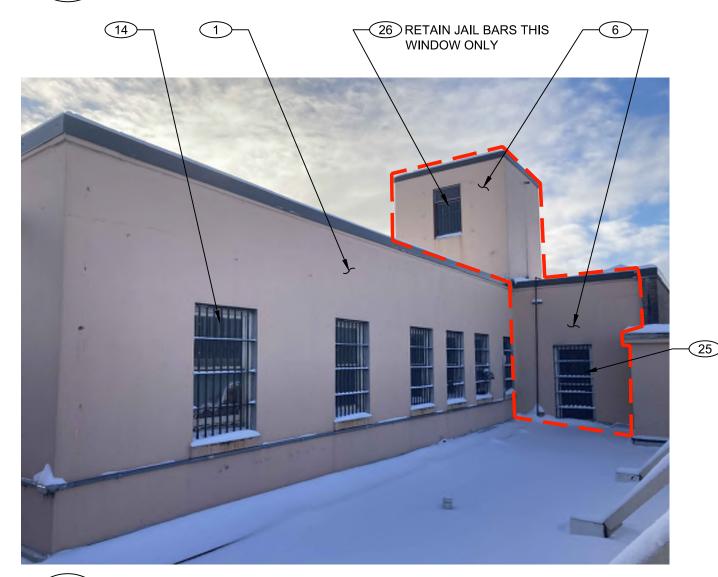

31 NORTH JAIL FACADE - EAST PORTION




34 CLASS 2 STANDPIPE OUTSIDE MECHANICAL ROOM
A0 6 NOT TO SCALE

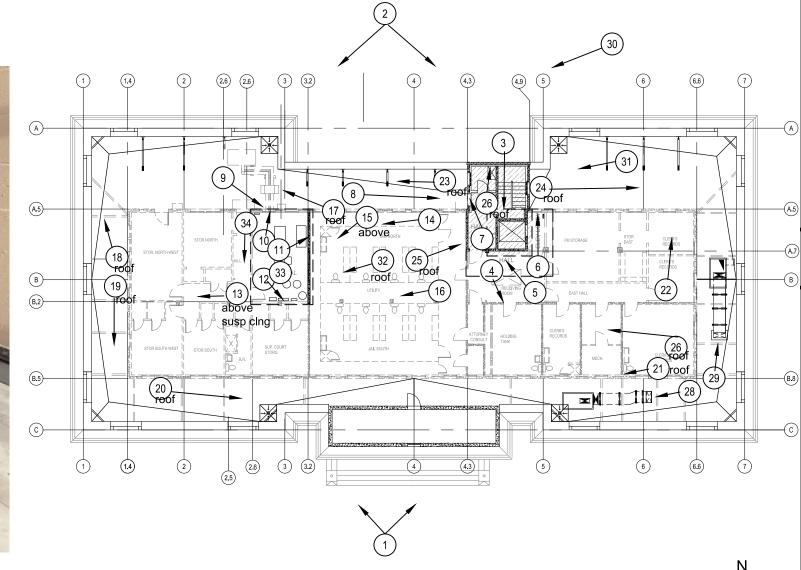

## FOURTH FLOOR PHOTO LOCATIONS

NOT TO SCALE

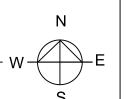

<u>DEMOLITION KEY NOTES</u> - INDICATED WITH FOLLOWING TYPICAL TAGS: #
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LOCATIONS. REFER ALSO TO WALL LEGEND ON DEMO PLAN

- 1. REMOVE EXTERIOR 5" CONCRETE WALLS WITH 4" TILE AT INTERIOR SIDE.
- 2. REMOVE INTERIOR 5" CONCRETE WALLS.
- 3. REMOVE INTERIOR 4" TILE WALLS.
- 4. REMOVE CONCRETE COLUMNS.
- 5. RETAIN CONCRETE COLUMNS.
- 6. RETAIN EXTERIOR WALLS. PREP FOR NEW FINISHES AND ASSEMBLIES PER WALL TYPES AND DETAILS, TYPICAL
- 7. RETAIN 5" CONCRETE WALLS. PROVIDE TEMPORARY SUPPORT AS NEEDED
- 8. MECHANICAL WATER TANK AND BRACE SUPPORT TO REMAIN.9. REMOVE DOOR AND TRANSOM AND PREP OPENING FOR
- REPLACEMENT DOOR.
- 10. REMOVE AND SEAL OFF UNUSED SHAFTS TYPICAL.
- 11. REMOVE COOLING TOWER AND PIPING. PREP FOR REPLACEMENT PER MECHANICAL.
- REMOVE PLUMBING FIXTURES AND CAP WATER/WASTE LINES PER PLUMBING.
- 13. REMOVE STEEL JAIL BARS, WALLS, CEILINGS, BEDS AND OTHER MATERIALS IN AREAS OF DEMOLITION. PROVIDE LEAD PAINT ABATEMENT PROCEDURES WHERE REQUIRED.
- 14. REMOVE DOORS, WINDOWS AND OTHER MATERIALS IN AREAS OF DEMOLITION. PROVIDE LEAD/ASBESTOS ABATEMENT WHERE REQUIRED.
- 15. REMOVE AND PREP FOR REPLACEMENT EXISTING 3RD FLOOR ROOF ASSEMBLY TO CONCRETE STRUCTURE. ALL ROOFING ACCESSORIES SHALL BE REMOVED/REPLACED.
- 16. REMOVE AND PREP FOR REPLACEMENT OF STEEL PARAPET BRACES WHERE ATTACHED TO JAIL WALLS. REFER TO
- 17. RELOCATE CLASS 2 STANDPIPE-BY FIRE SPRINKLER SUB. RUN NEW PIPING UNDER NEW ROOF INSULATION, SEE SHEET A2.1.

STRUCTURAL DOCUMENTS FOR REPLACEMENT DETAILS.

- 18. PROVIDE TEMPORARY SUPPORT FOR ELECTRICAL PANELS AND CONDUITS DURING REMOVAL OF WALLS AND COLUMNS.
- RETAIN ROOF STRUCTURES ABOVE IN THIS AREA. ALL OTHER ROOFS AND BEAMS TO BE REMOVED.
- 20. 4" ROOF DRAIN IN SUMP.
- 21. RETAIN WATER HEATER VENT DURING DEMOLITION.
- 22. AT STORAGE WINDOW OPENING, REMOVE EXTERIOR JAIL BARS, REMOVE WINDOW FRAME AND TRIMS. REMOVE LOUVER AND PREP FOR REPLACEMENT IN NEW FRAMING AND DEIFS PER ELEVATIONS AND SECTIONS.
- 23. REMOVE SHORT PARAPET BRACE AND PREP FOR REPLACEMENT PER STRUCTURAL.
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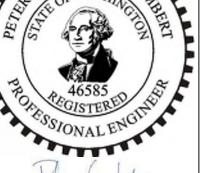


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300 Elliot Ave. West, Suite 250

Seattle, WA 98119 206-443-6499



(ctarsa (gm. Pa)

ABB Project # 22-7763.01 Skagit County Facilities Project # 3809

PROJECT NAME:
Skagit County Superior Court
Rooftop Jailhouse Removal
OWNER NAME / ADDRESS:
Skagit County,
a Municipal Corporation
1800 Continental Place
Mount Vernon, WA 98273
PROPERTY ADDRESS:
205 W. Kincaid Street
Mount Vernon, WA 98273
PROPERTY MANAGER:
Skagit County Facilities
Management
1800 Continental Place
Mount Vernon, WA 98273
Contact: Ken Hansen

CONSTRUCTION PLANS (REVISED)  BID SET ISSUE  PERMIT CORRECTION BID SET	Mark	Description
PERMIT CORRECTION		
/ 1 \ I		BID SET ISSUE
	1	
BID SET ISSUE		BID SET ISSUE

CITY OF MOUNT VERNON PERMIT NUMBER BLDG23-0137

SHEET TITLE


PHOTO SHEET#4

SCALE: NOTED ON DRAWINGS

A0.6

#### **DEMOLITION GENERAL NOTES**


- A. DEMOLITION SHALL BE PERFORMED WITH SENSITIVITY TO COURTROOMS IN DAILY USE.
- B. GC SHALL PHOTO DOCUMENT CONDITIONS BELOW AREAS OF WORK BEFORE STARTING DEMOLITION.
- C. GC SHALL INSPECT CEILING AND WALL CONDITIONS AT FLOOR BELOW AFTER EACH DAY OF WORK. ANY DAMAGE TO MATERIALS BELOW SHALL BE REPAIRED IN KIND.
- D. REFER TO STRUCTURAL, MECHANICAL AND ELECTRICAL
- DOCUMENTS FOR RELATED DEMOLITION NOTES.
- E. REFER TO OWNER PROVIDED ASBESTOS AND LEAD TESTING REPORTS IN SPECIFICATION APPENDICES. GC SHALL INCLUDE COST OF ABATEMENT IN THEIR BID. GC IS RESPONSIBLE FOR PROVIDING ANY ADDITIONAL REQUIRED TESTING AND ABATEMENT REPORTS FOR SUSPECTED MATERIALS NOT INCLUDED IN PROVIDED REPORTS.

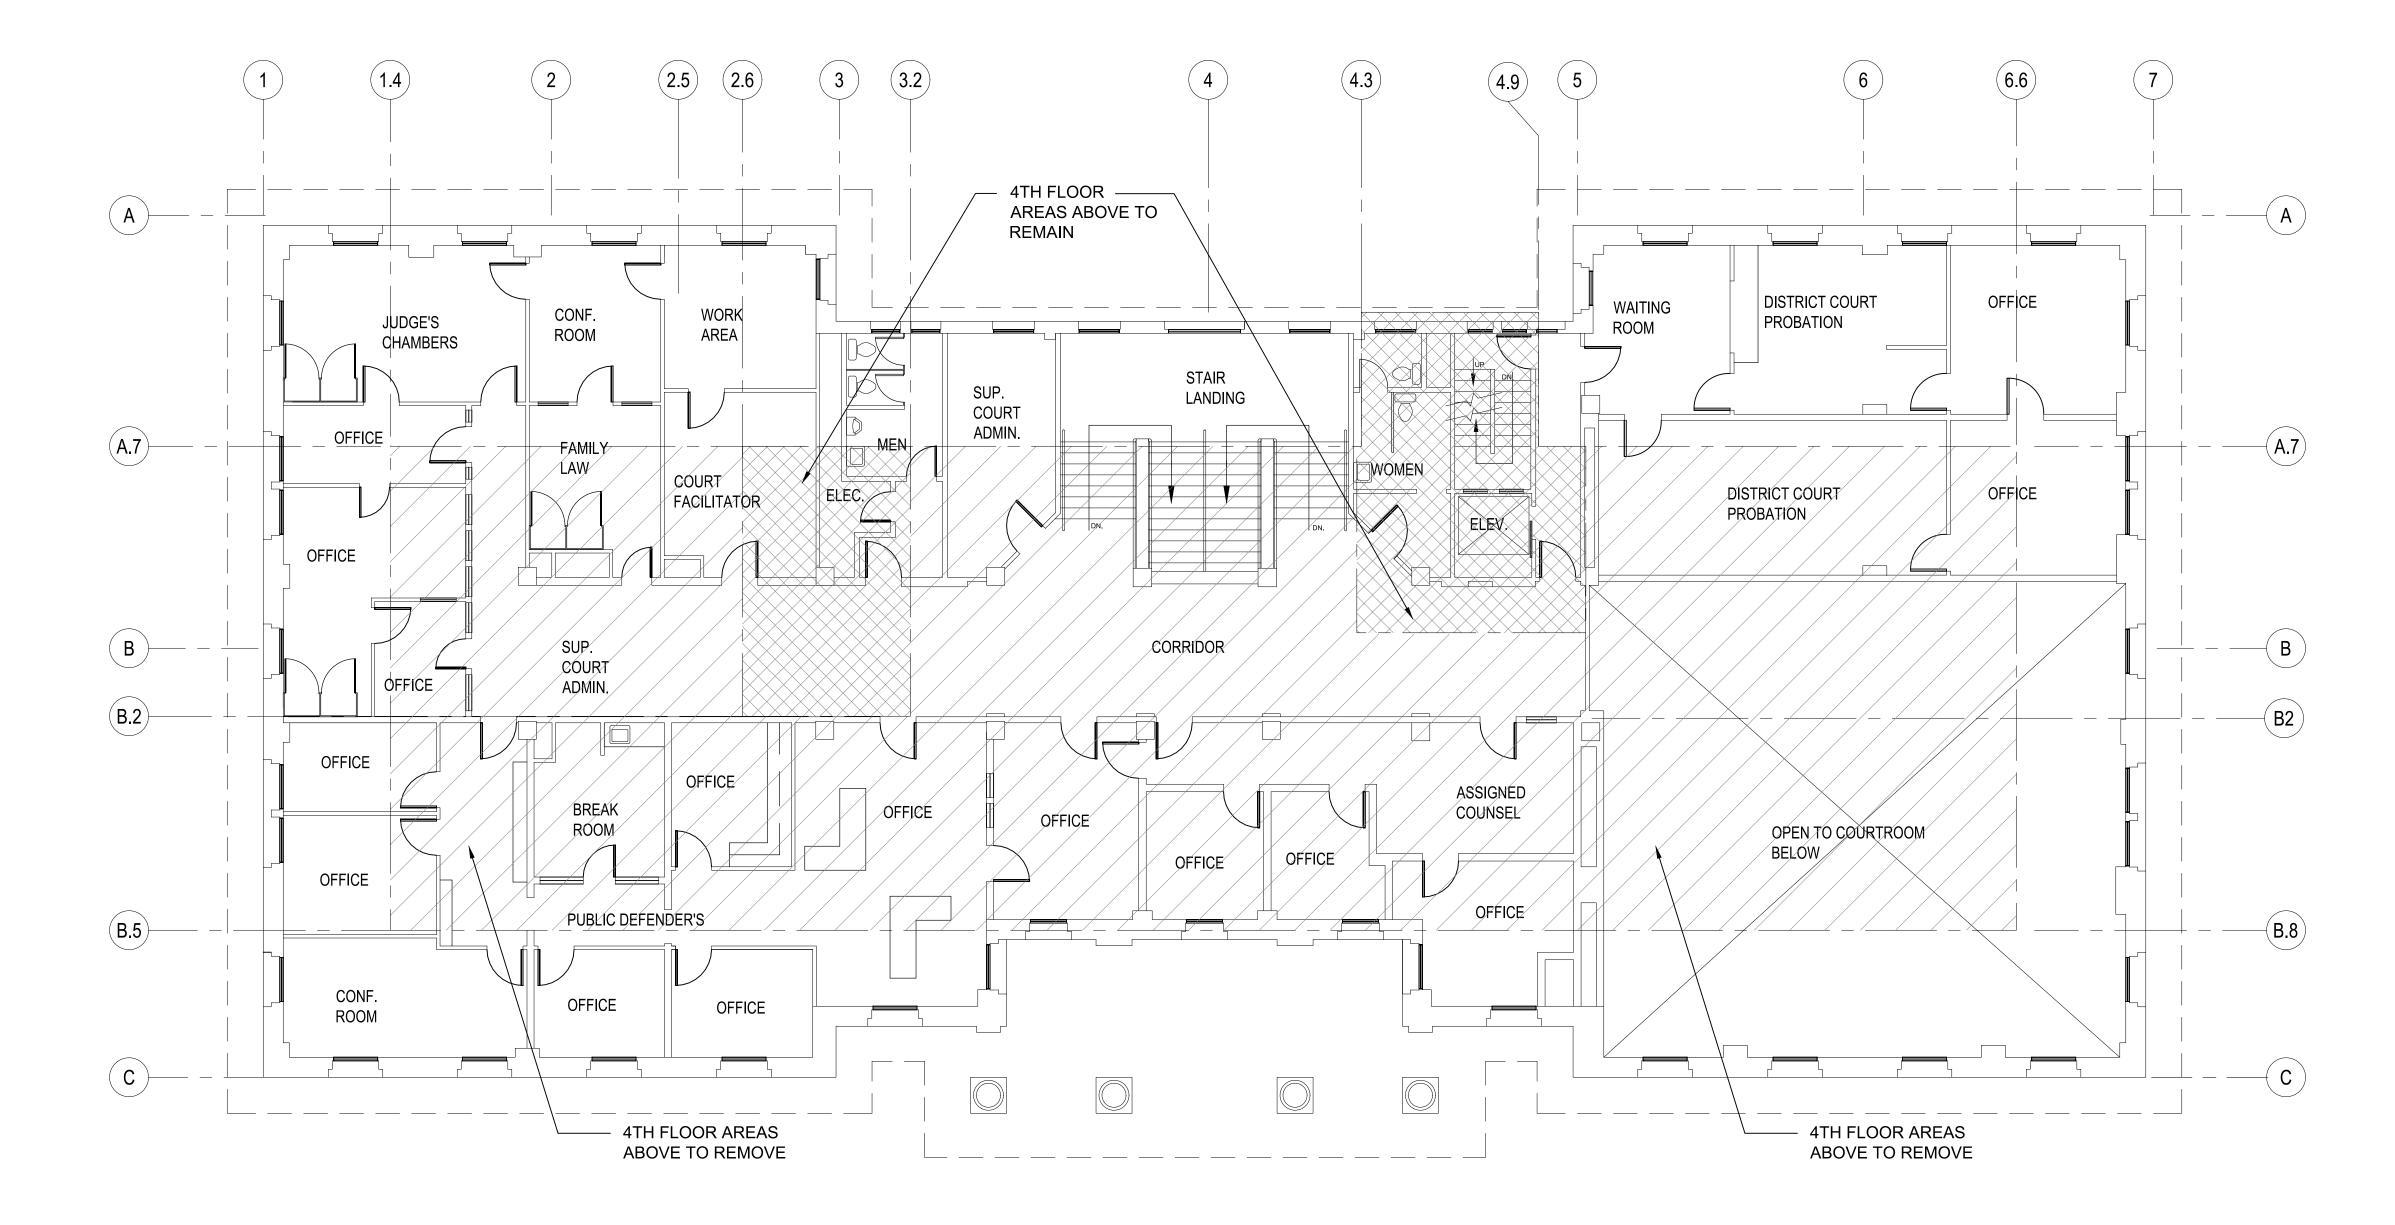



THIRD FLOOR PLAN (FOR INFORMATION)

SCALE: 1/8" = 1'-0". DO NOT SCALE!

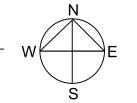



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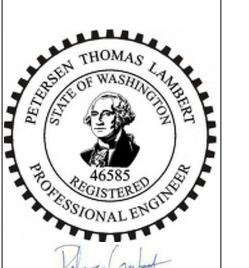


ABB Project # 22-7763.01 Skagit County Facilities

**Project # 3809** PROJECT NAME: Skagit County Superior Court Rooftop Jailhouse Removal OWNER NAME / ADDRESS: Skagit County, a Municipal Corporation 1800 Continental Place Mount Vernon, WA 98273 PROPERTY ADDRESS: 205 W. Kincaid Street Mount Vernon, WA 98273 PROPERTY MANAGER: Skagit County Facilities Management 1800 Continental Place Mount Vernon, WA 98273 Contact: Ken Hansen

L			
<u> </u>	Mark	Description	Date
		CONSTRUCTION PLANS (REVISED)	03/20/2
		BID SET ISSUE	04/24/2
4	1	PERMIT CORRECTION BID SET	06/21/2
		BID SET ISSUE	09/25/23


CITY OF MOUNT VERNON
PERMIT NUMBER
BLDG23-0137

SHEET TITLE

3RD FLOOR PLAN EXISTING

SCALE: NOTED ON DRAWINGS

D2.1

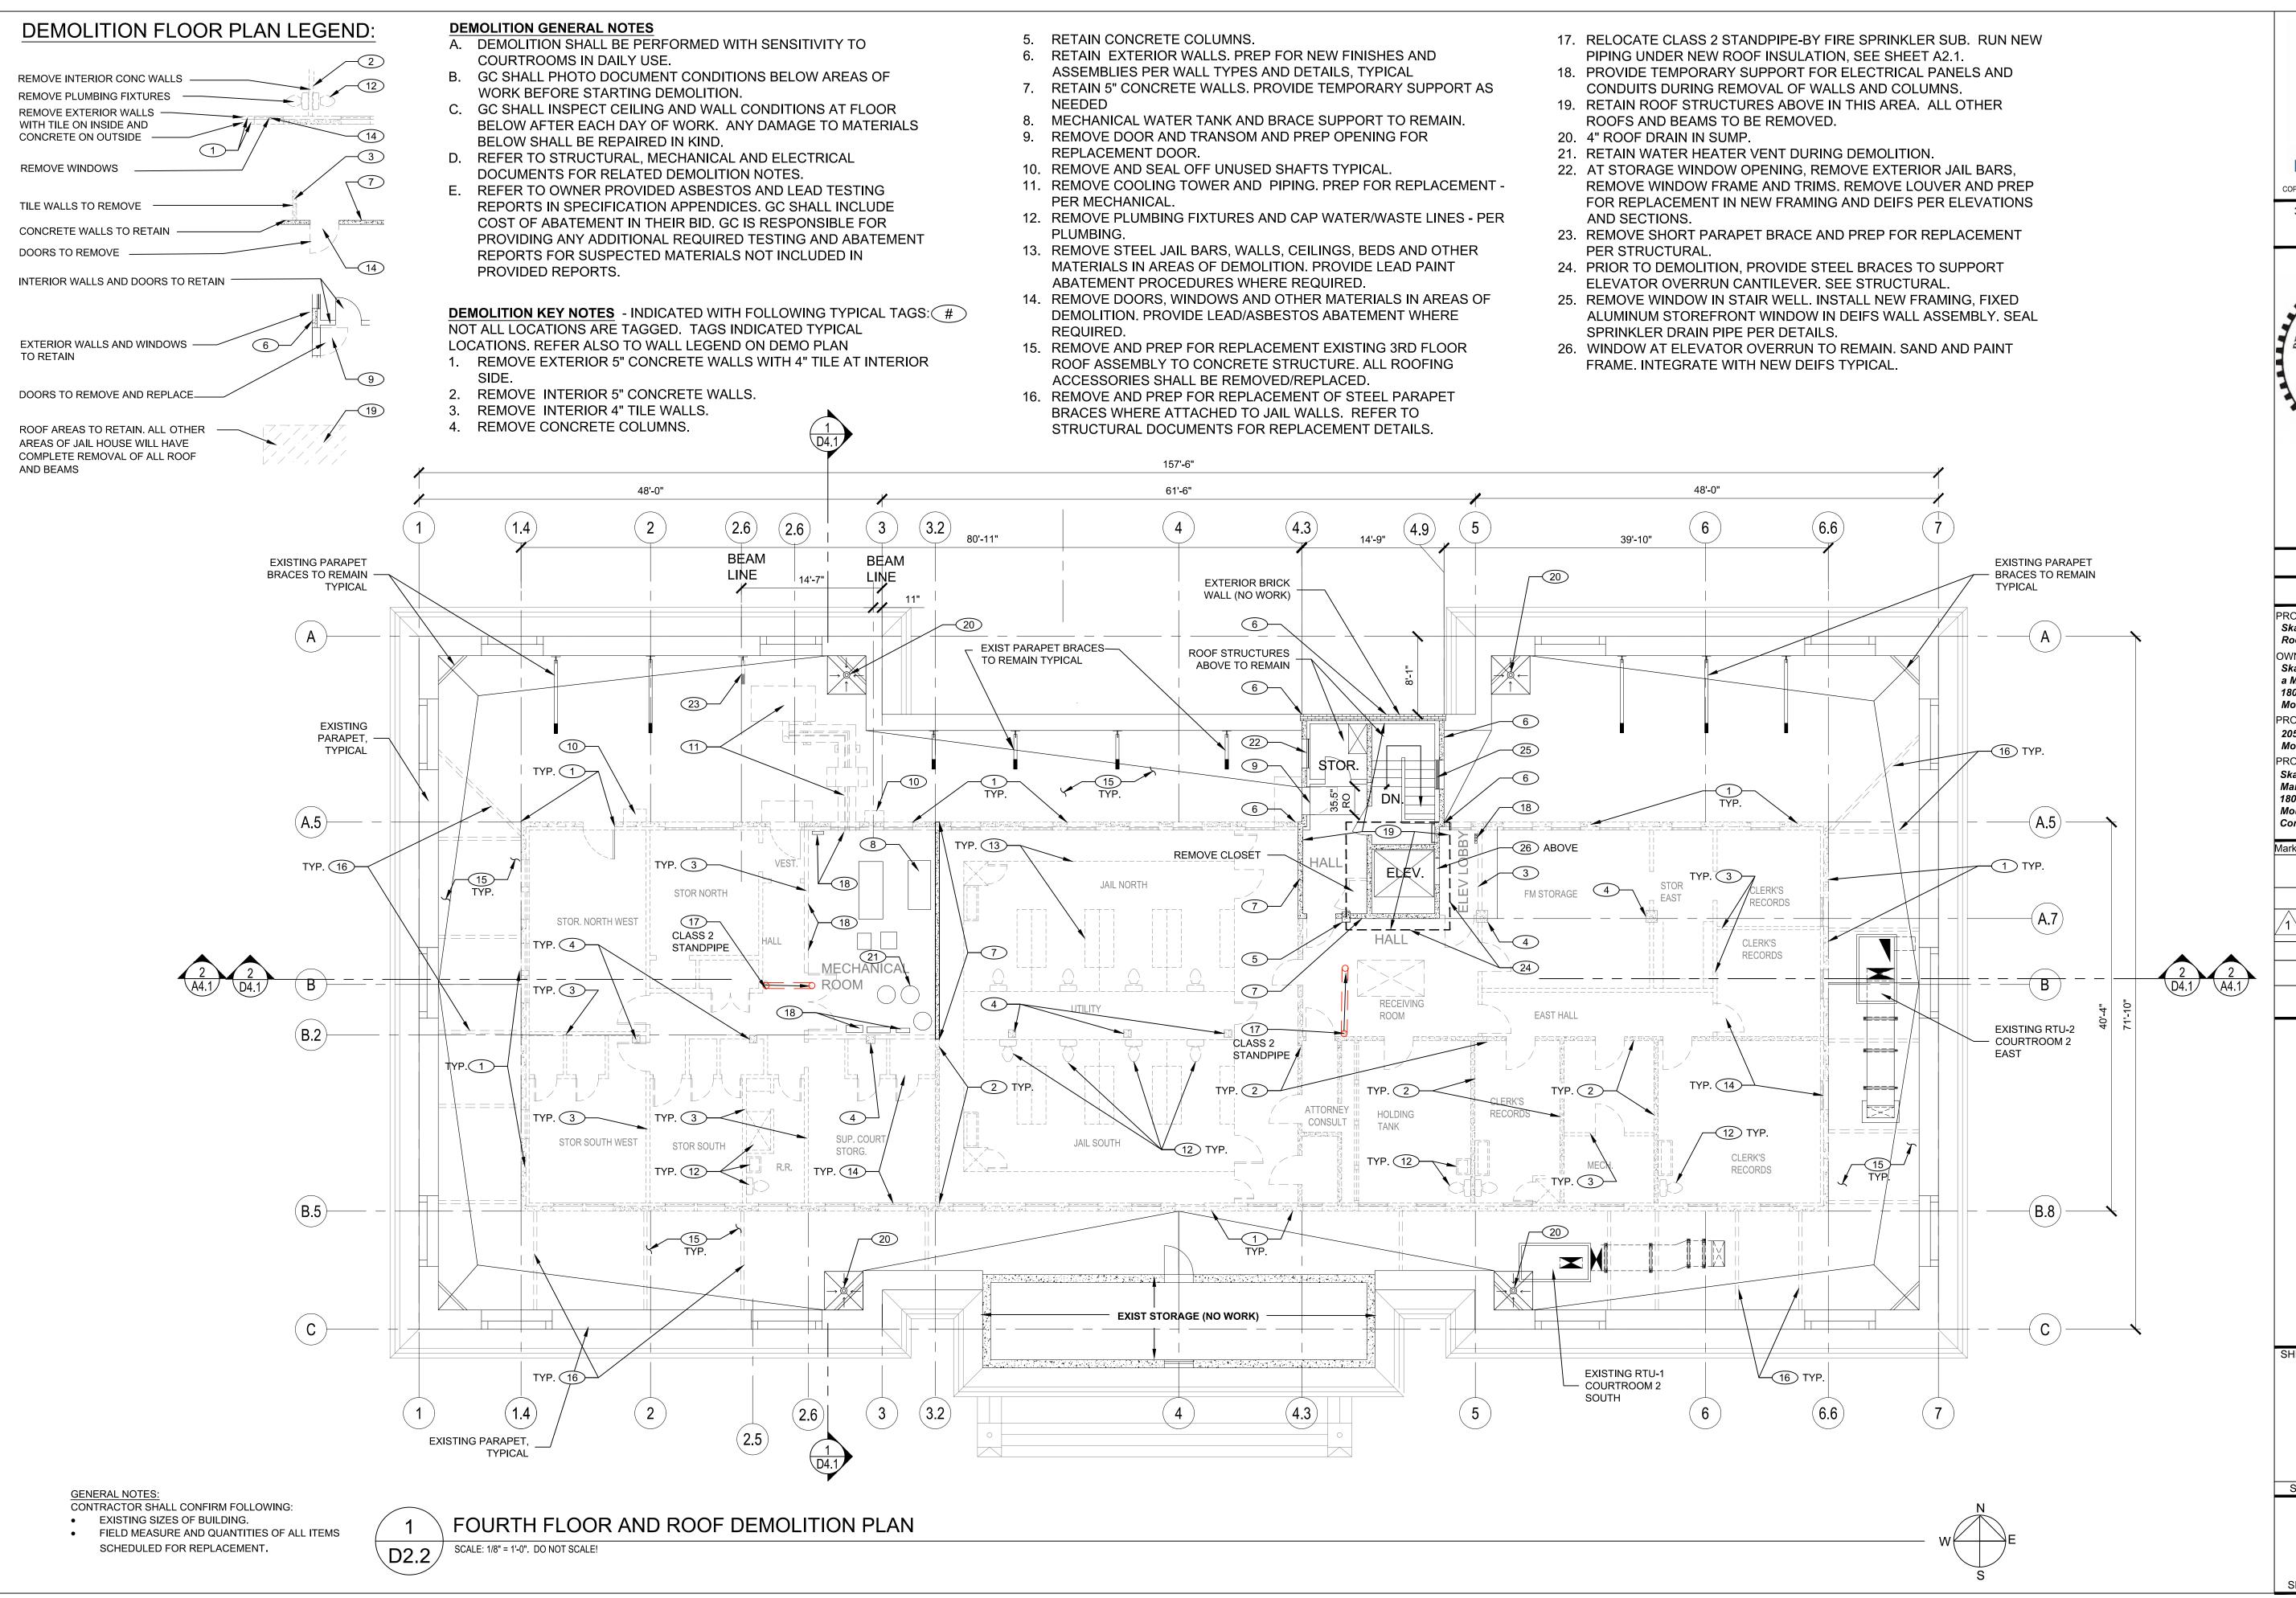

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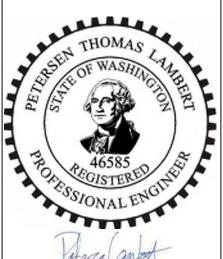


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	BID SET ISSUE	09/25/2
		·


CITY OF MOUNT VERNON PERMIT NUMBER BLDG23-0137

SHEET TITLE

4TH FLOOR AND ROOF DEMOLITION PLAN

SCALE: NOTED ON DRAWINGS

**D2.2** 

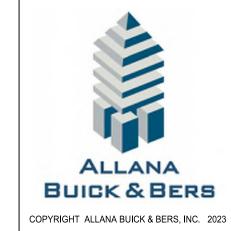

300 Elliot Ave. West, Suite 250 Seattle, WA 98119 206-443-6499




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CITY OF MOUNT VERNON PERMIT NUMBER BLDG23-0137


SHEET TITLE

**UPPER** ROOF **DEMOLITION** PLAN

SCALE: NOTED ON DRAWINGS

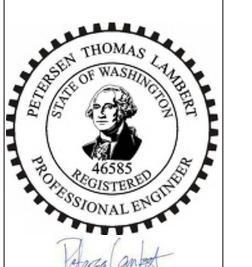**D2.3** 

SHEET

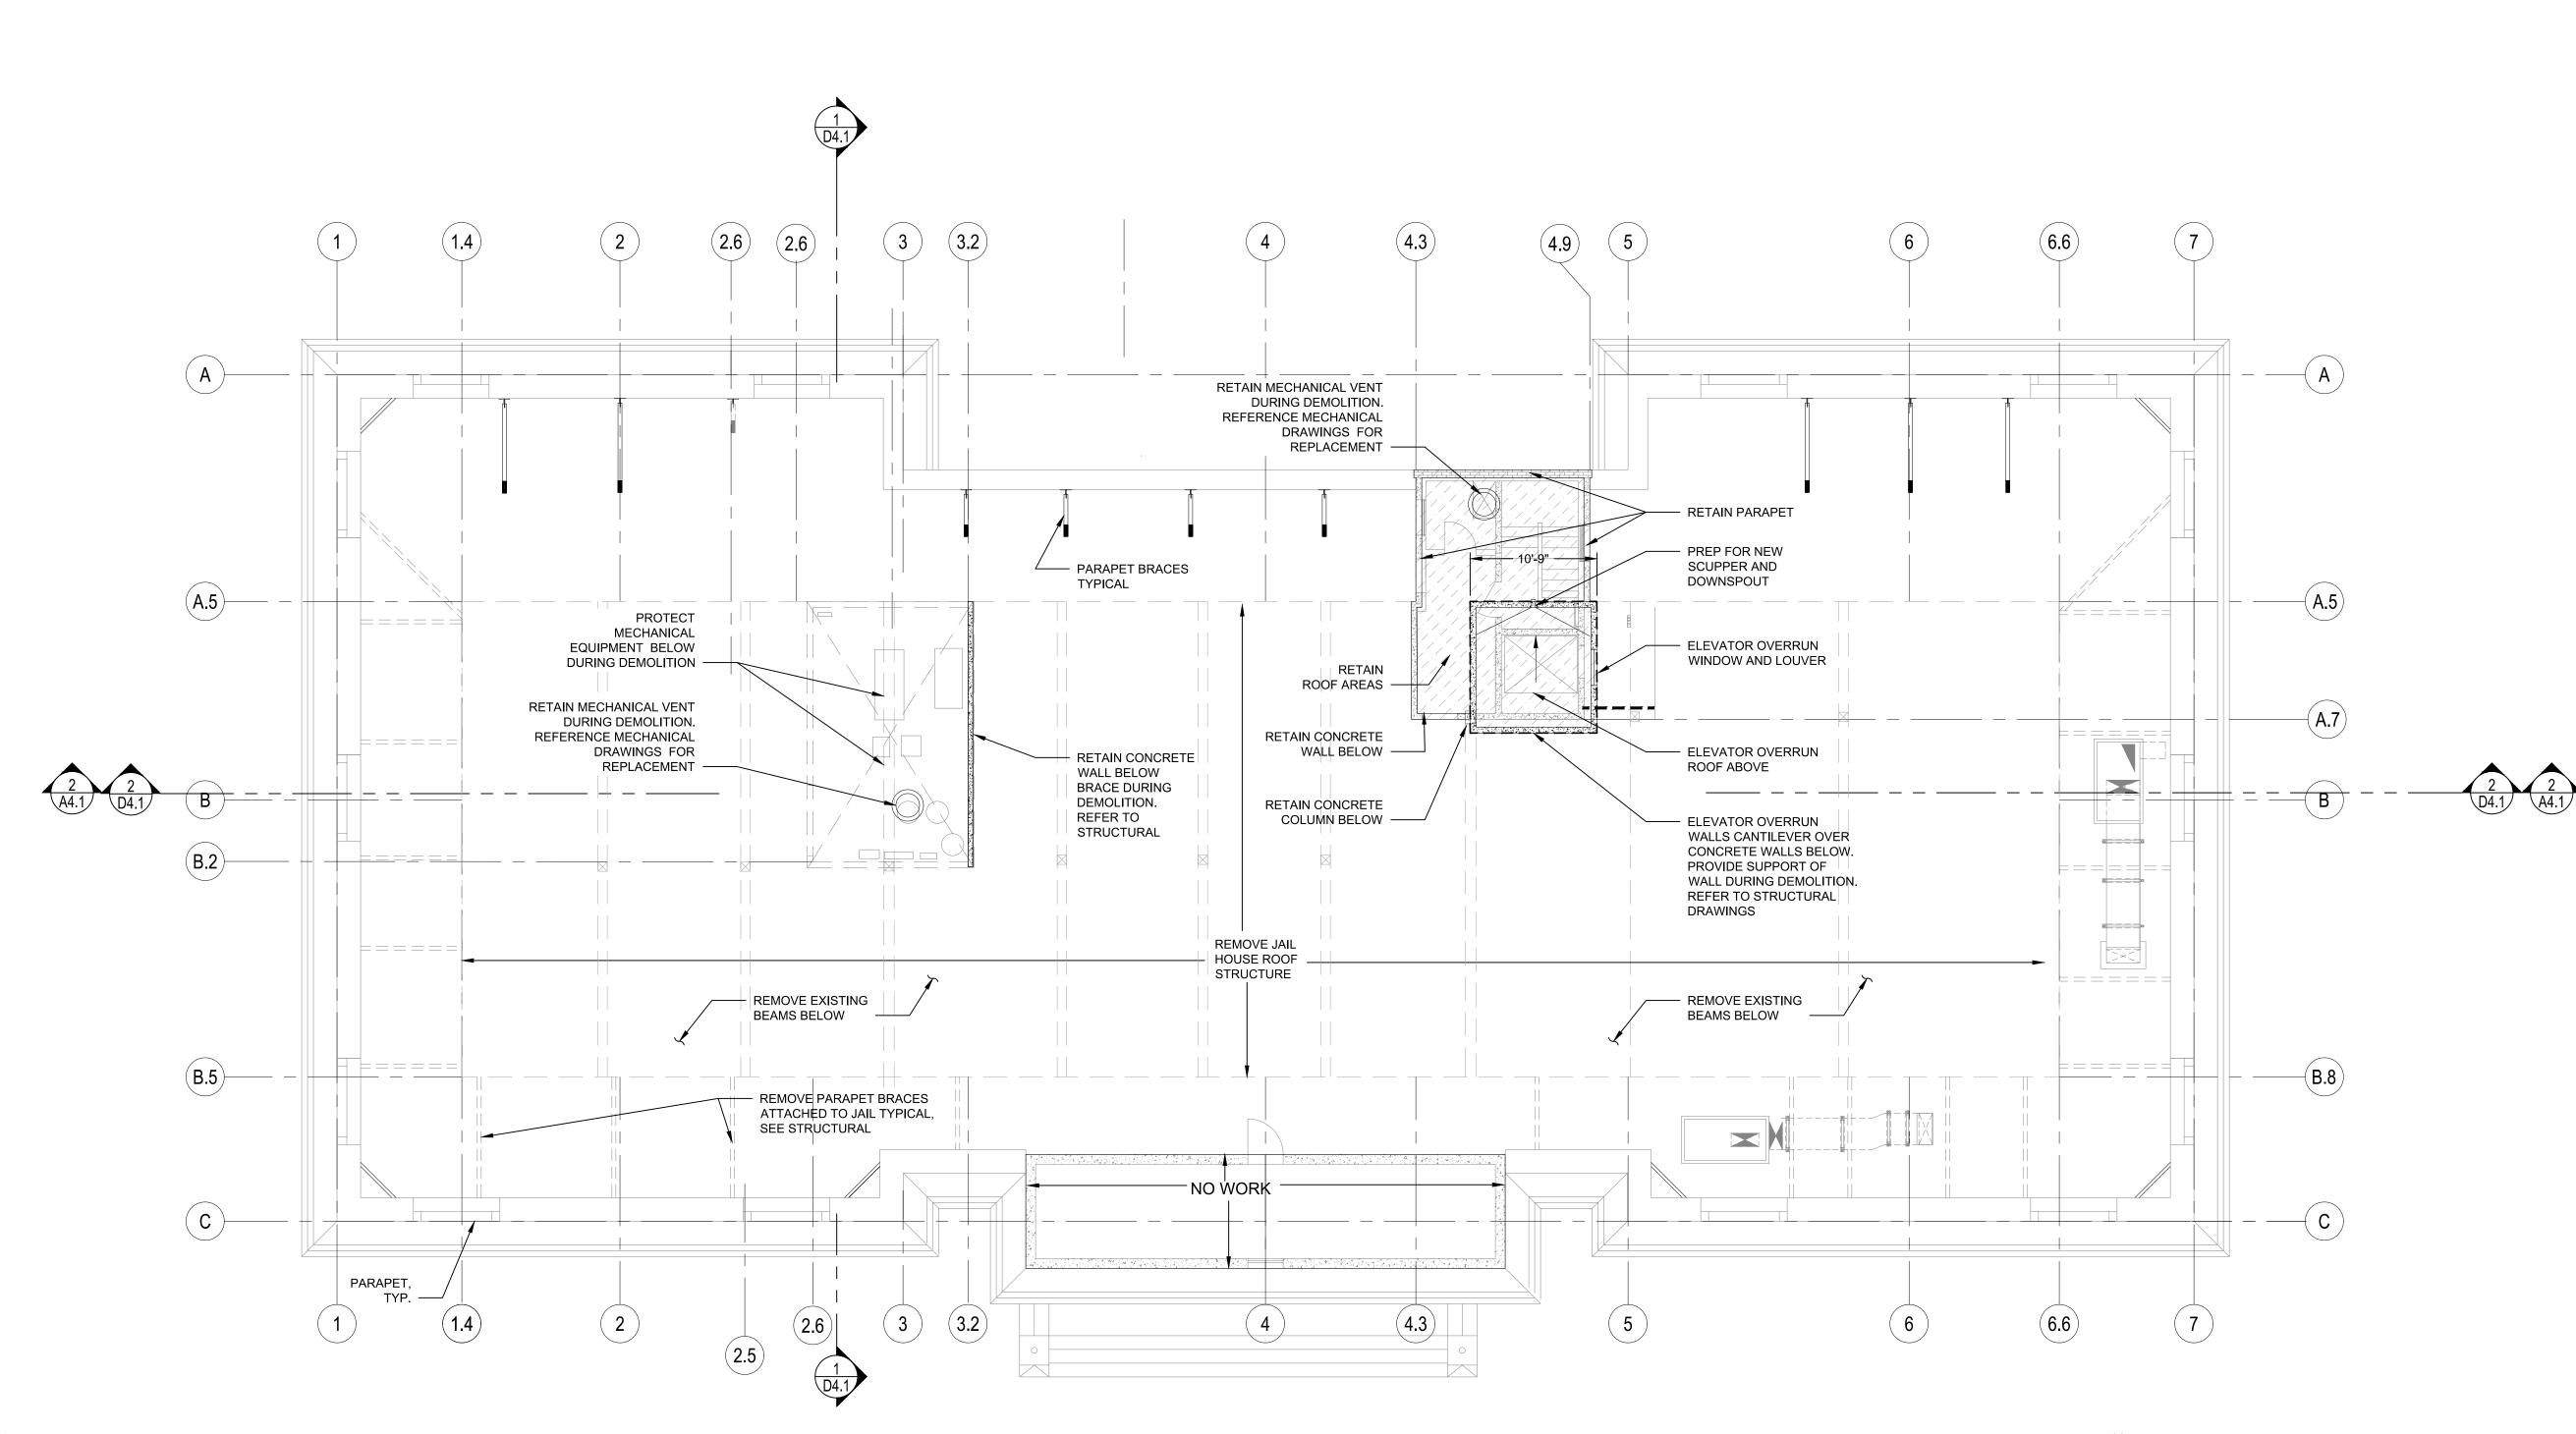


**GENERAL NOTES:** 


CONTRACTOR SHALL CONFIRM FOLLOWING: EXISTING SIZES OF BUILDING. FIELD MEASURE AND QUANTITIES OF ALL ITEMS

SCHEDULED FOR REPLACEMENT.


UPPER ROOF DEMOLITION PLAN

SCALE: 1/8" = 1'-0". DO NOT SCALE!

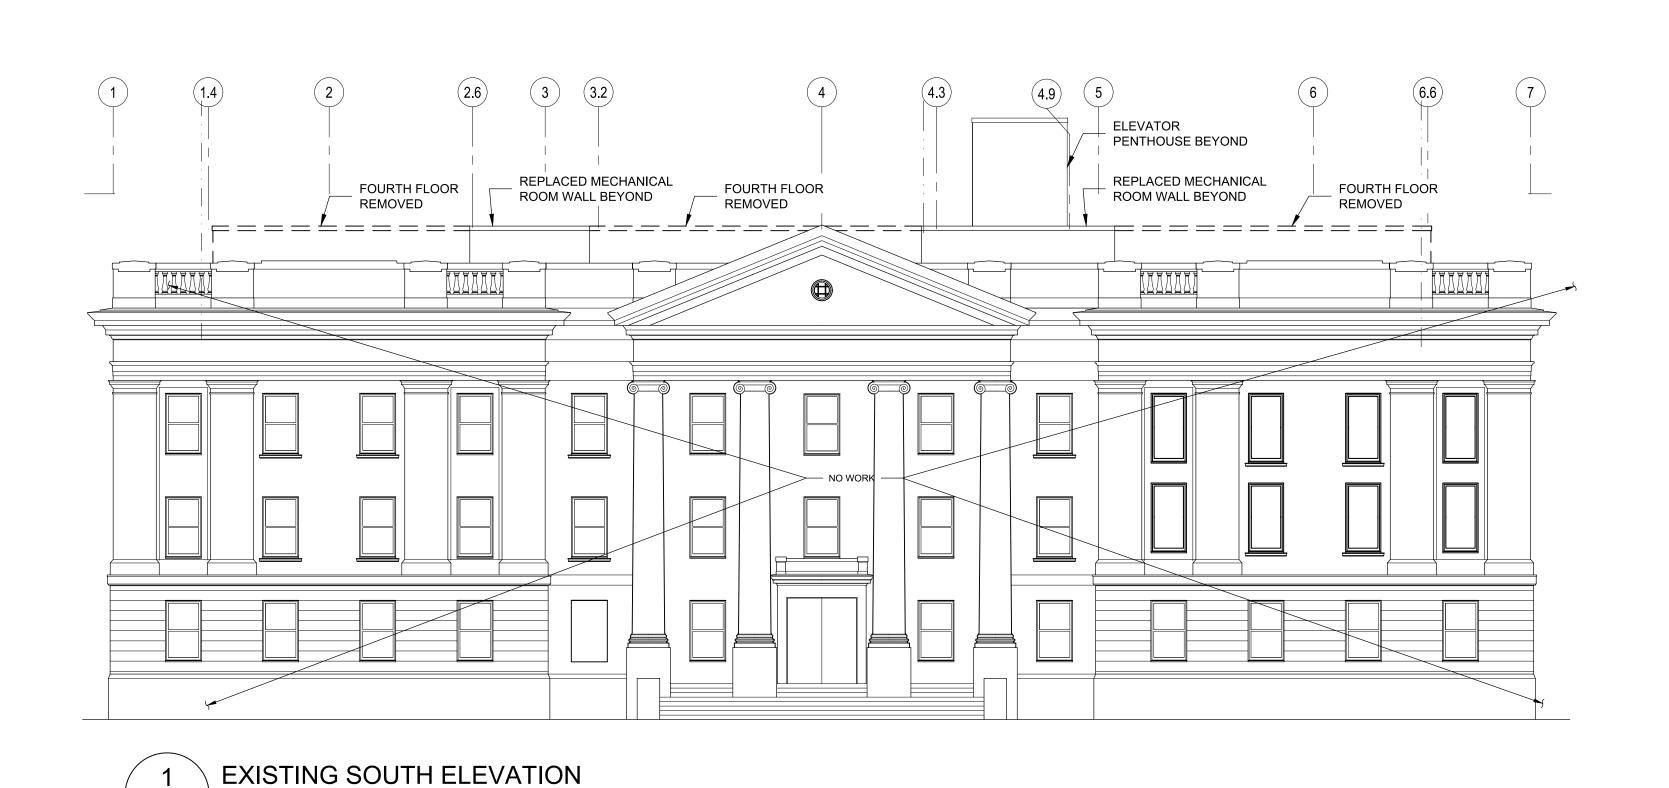

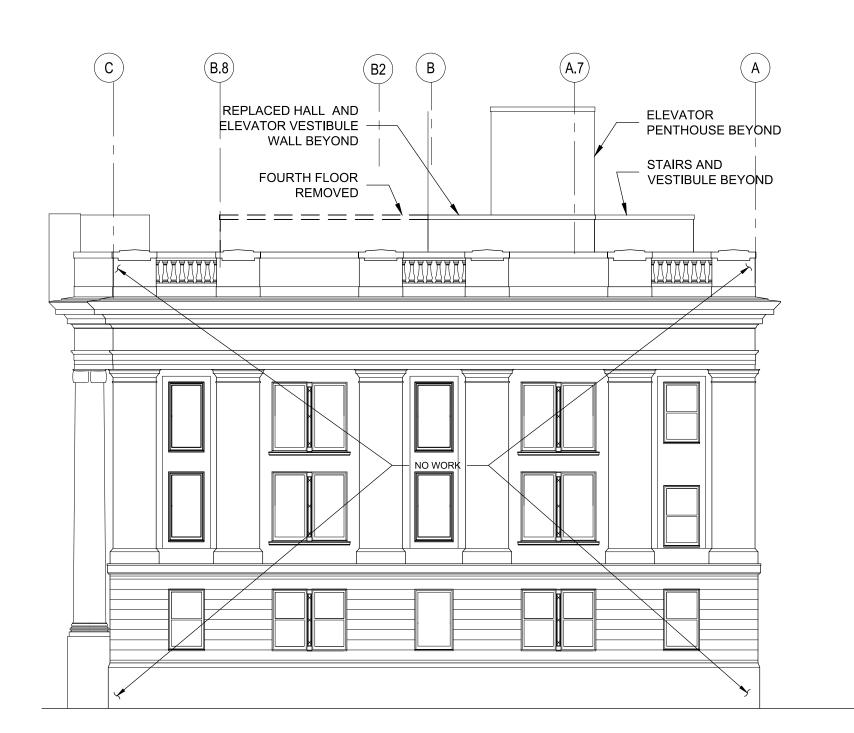


2 EXISTING EAST ELEVATION
D2.4 SCALE: 3/32" = 1'-0". DO NOT SCALE!

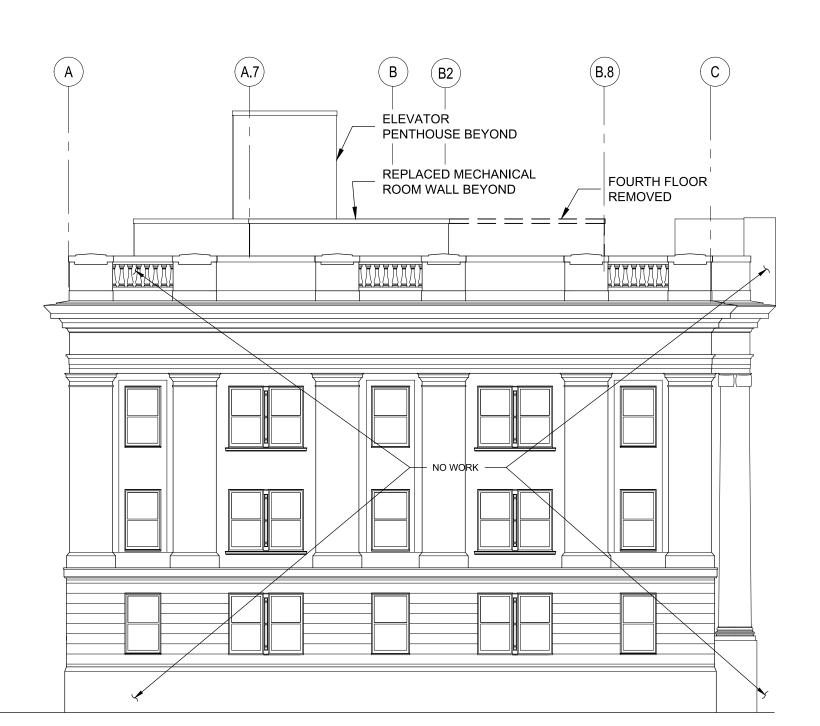



SCALE: 3/32" = 1'-0". DO NOT SCALE!

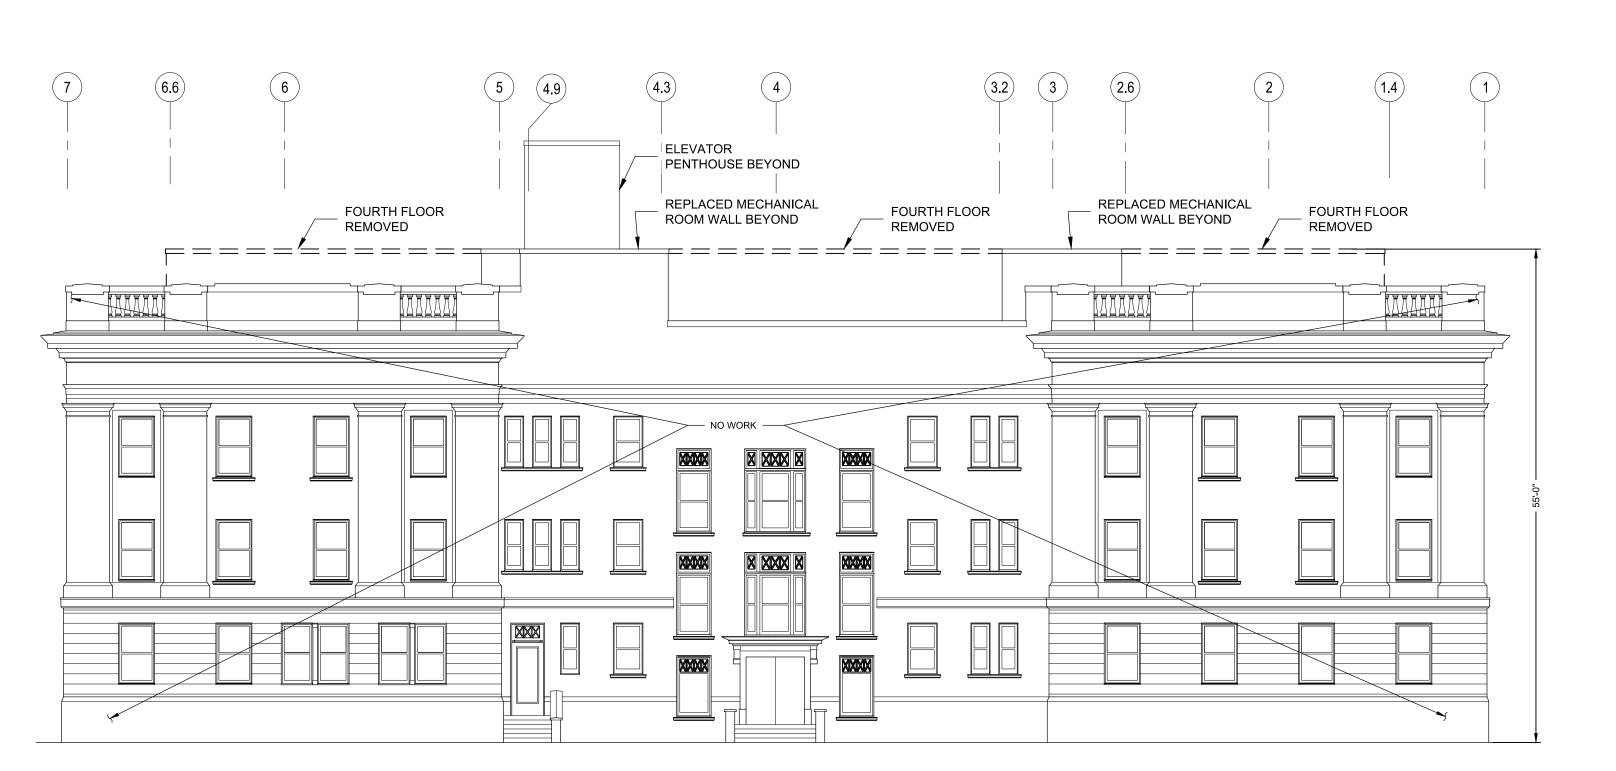




GENERAL NOTES:

CONTRACTOR SHALL CONFIRM FOLLOWING:

 EXISTING SIZES OF BUILDING.
 FIELD MEASURE AND QUANTITIES OF ALL ITEMS SCHEDULED FOR REPLACEMENT.

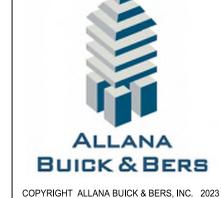

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206-443-6499

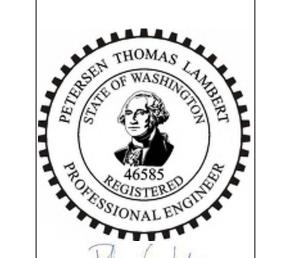


ABB Project

# 22-7763.01 Skagit County Facilities

Project # 3809 PROJECT NAME: Skagit County Superior Court Rooftop Jailhouse Removal OWNER NAME / ADDRESS: Skagit County, a Municipal Corporation 1800 Continental Place Mount Vernon, WA 98273 PROPERTY ADDRESS: 205 W. Kincaid Street Mount Vernon, WA 98273 PROPERTY MANAGER: Skagit County Facilities Management 1800 Continental Place Mount Vernon, WA 98273

Cont	act: Ken Hansen	
Mark	Description	Date
	CONSTRUCTION PLANS (REVISED)	03/20/23
	BID SET ISSUE	04/24/23
1	PERMIT CORRECTION BID SET	06/21/23
	BID SET ISSUE	09/25/23

CITY OF MOUNT VERNON PERMIT NUMBER BLDG23-0137

SHEET TITLE

EXISTING ELEVATIONS

SCALE: NOTED ON DRAWINGS

D2.4



#### **DEMOLITION GENERAL NOTES**

- A. DEMOLITION SHALL BE PERFORMED WITH SENSITIVITY TO COURTROOMS IN DAILY USE.
- B. GC SHALL PHOTO DOCUMENT CONDITIONS BELOW AREAS OF WORK BEFORE STARTING DEMOLITION.
- C. GC SHALL INSPECT CEILING AND WALL CONDITIONS AT FLOOR BELOW AFTER EACH DAY OF WORK. ANY DAMAGE TO MATERIALS BELOW SHALL BE REPAIRED IN KIND.
- D. REFER TO STRUCTURAL, MECHANICAL AND ELECTRICAL DOCUMENTS FOR RELATED DEMOLITION NOTES.
- E. REFER TO OWNER PROVIDED ASBESTOS AND LEAD TESTING REPORTS IN SPECIFICATION APPENDICES. GC SHALL INCLUDE COST OF ABATEMENT IN THEIR BID. GC IS RESPONSIBLE FOR PROVIDING ANY ADDITIONAL REQUIRED TESTING AND ABATEMENT REPORTS FOR SUSPECTED MATERIALS NOT INCLUDED IN PROVIDED REPORTS.

DEMOLITION KEY NOTES - INDICATED WITH FOLLOWING TYPICAL TAGS: #

NOT ALL LOCATIONS ARE TAGGED. TAGS INDICATED TYPICAL

LOCATIONS. REFER ALSO TO WALL LEGEND ON DEMO PLAN

1. REMOVE EXTERIOR 5" CONCRETE WALLS WITH 4" TILE AT INTERIOR


- SIDE.
- 2. REMOVE INTERIOR 5" CONCRETE WALLS.
- REMOVE INTERIOR 4" TILE WALLS.
  REMOVE CONCRETE COLUMNS.
- 5 DETAIN CONCRETE COLUMN
- 5. RETAIN CONCRETE COLUMNS. 6. RETAIN EXTERIOR WALLS. PREP FOR NEW FINISHES AND
- ASSEMBLIES PER WALL TYPES AND DETAILS, TYPICAL
  7. RETAIN 5" CONCRETE WALLS. PROVIDE TEMPORARY SUPPORT AS
- NEEDED
- 8. MECHANICAL WATER TANK AND BRACE SUPPORT TO REMAIN.
- 9. REMOVE DOOR AND TRANSOM AND PREP OPENING FOR REPLACEMENT DOOR.
- 10. REMOVE AND SEAL OFF UNUSED SHAFTS TYPICAL.
- 11. REMOVE COOLING TOWER AND PIPING. PREP FOR REPLACEMENT PER MECHANICAL.
- 12. REMOVE PLUMBING FIXTURES AND CAP WATER/WASTE LINES PER PLUMBING.
- 13. REMOVE STEEL JAIL BARS, WALLS, CEILINGS, BEDS AND OTHER MATERIALS IN AREAS OF DEMOLITION. PROVIDE LEAD PAINT ABATEMENT PROCEDURES WHERE REQUIRED.
- 14. REMOVE DOORS, WINDOWS AND OTHER MATERIALS IN AREAS OF DEMOLITION. PROVIDE LEAD/ASBESTOS ABATEMENT WHERE REQUIRED.
- 15. REMOVE AND PREP FOR REPLACEMENT EXISTING 3RD FLOOR ROOF ASSEMBLY TO CONCRETE STRUCTURE. ALL ROOFING ACCESSORIES SHALL BE REMOVED/REPLACED.
- 16. REMOVE AND PREP FOR REPLACEMENT OF STEEL PARAPET BRACES WHERE ATTACHED TO JAIL WALLS. REFER TO
- STRUCTURAL DOCUMENTS FOR REPLACEMENT DETAILS.

  17. RELOCATE CLASS 2 STANDPIPE-BY FIRE SPRINKLER SUB. RUN NEW PIPING UNDER NEW ROOF INSULATION, SEE SHEET A2.1.
- 18. PROVIDE TEMPORARY SUPPORT FOR ELECTRICAL PANELS AND CONDUITS DURING REMOVAL OF WALLS AND COLUMNS.
- 19. RETAIN ROOF STRUCTURES ABOVE IN THIS AREA. ALL OTHER ROOFS AND BEAMS TO BE REMOVED.
- 20. 4" ROOF DRAIN IN SUMP.
- 21. RETAIN WATER HEATER VENT DURING DEMOLITION.
- 22. AT STORAGE WINDOW OPENING, REMOVE EXTERIOR JAIL BARS, REMOVE WINDOW FRAME AND TRIMS. REMOVE LOUVER AND PREP FOR REPLACEMENT IN NEW FRAMING AND DEIFS PER ELEVATIONS AND SECTIONS.
- 23. REMOVE SHORT PARAPET BRACE AND PREP FOR REPLACEMENT PER STRUCTURAL.
- 24. PRIOR TO DEMOLITION, PROVIDE STEEL BRACES TO SUPPORT ELEVATOR OVERRUN CANTILEVER. SEE STRUCTURAL.
- 25. REMOVE WINDOW IN STAIR WELL. INSTALL NEW FRAMING, FIXED ALUMINUM STOREFRONT WINDOW IN DEIFS WALL ASSEMBLY. SEAL SPRINKLER DRAIN PIPE PER DETAILS.
- 26. WINDOW AT ELEVATOR OVERRUN TO REMAIN. SAND AND PAINT FRAME. INTEGRATE WITH NEW DEIFS TYPICAL.


#### **GENERAL NOTES:**

CONTRACTOR SHALL CONFIRM FOLLOWING:


- EXISTING SIZES OF BUILDING.
- FIELD MEASURE AND QUANTITIES OF ALL ITEMS SCHEDULED FOR REPLACEMENT.

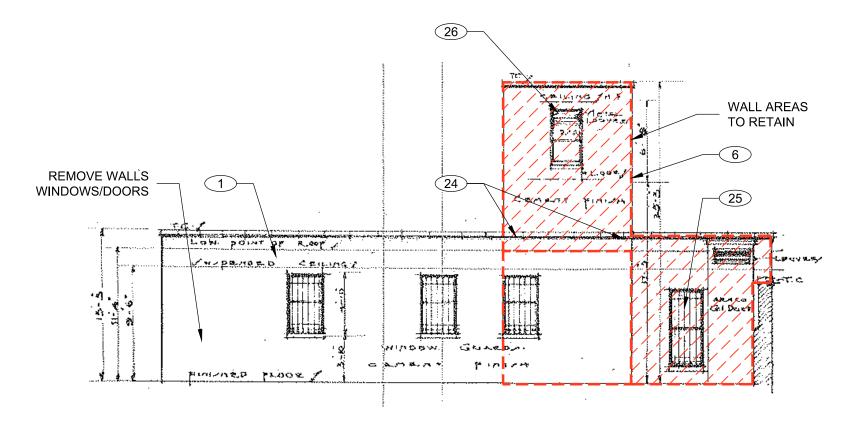




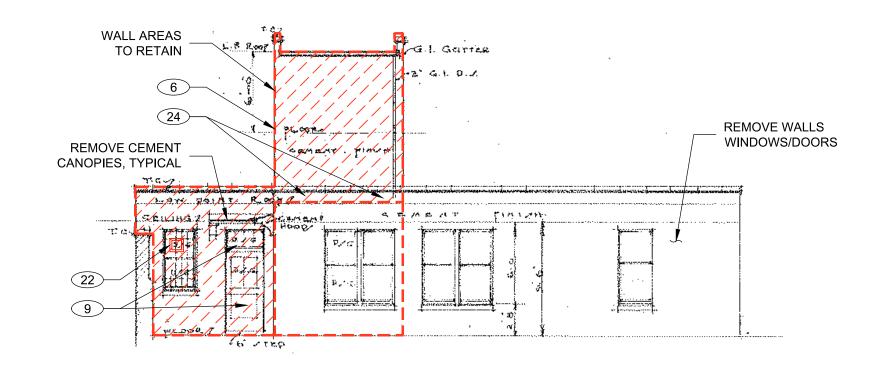



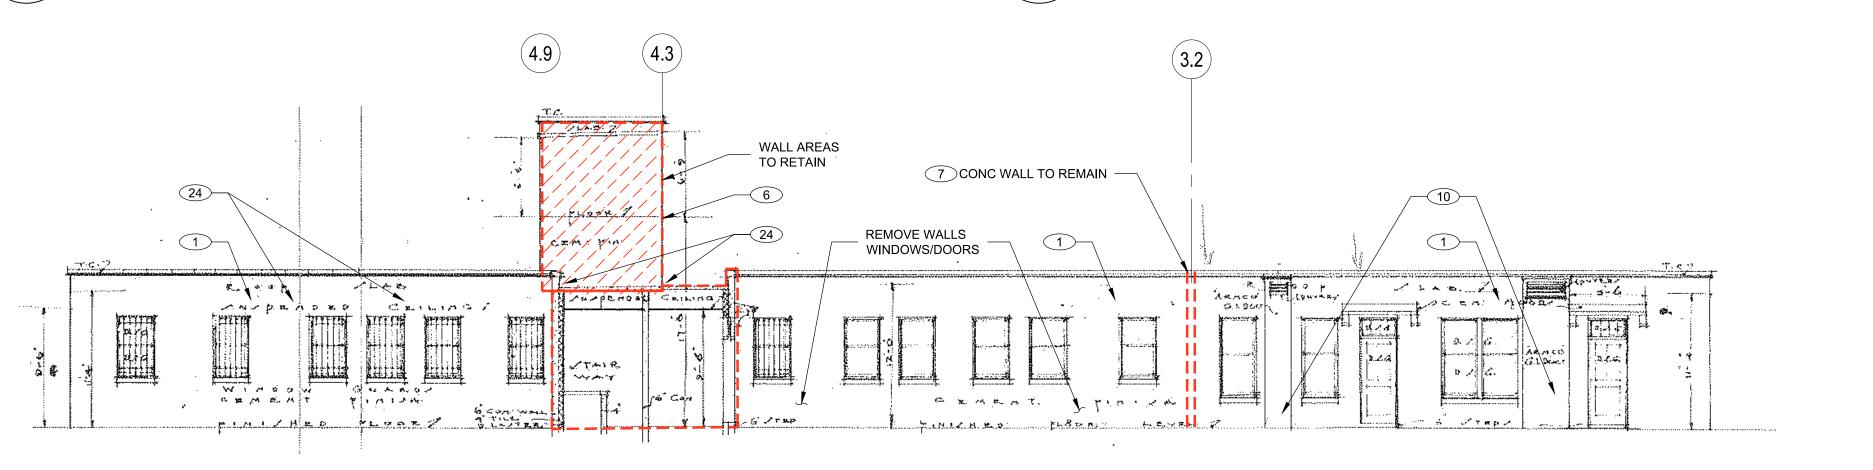



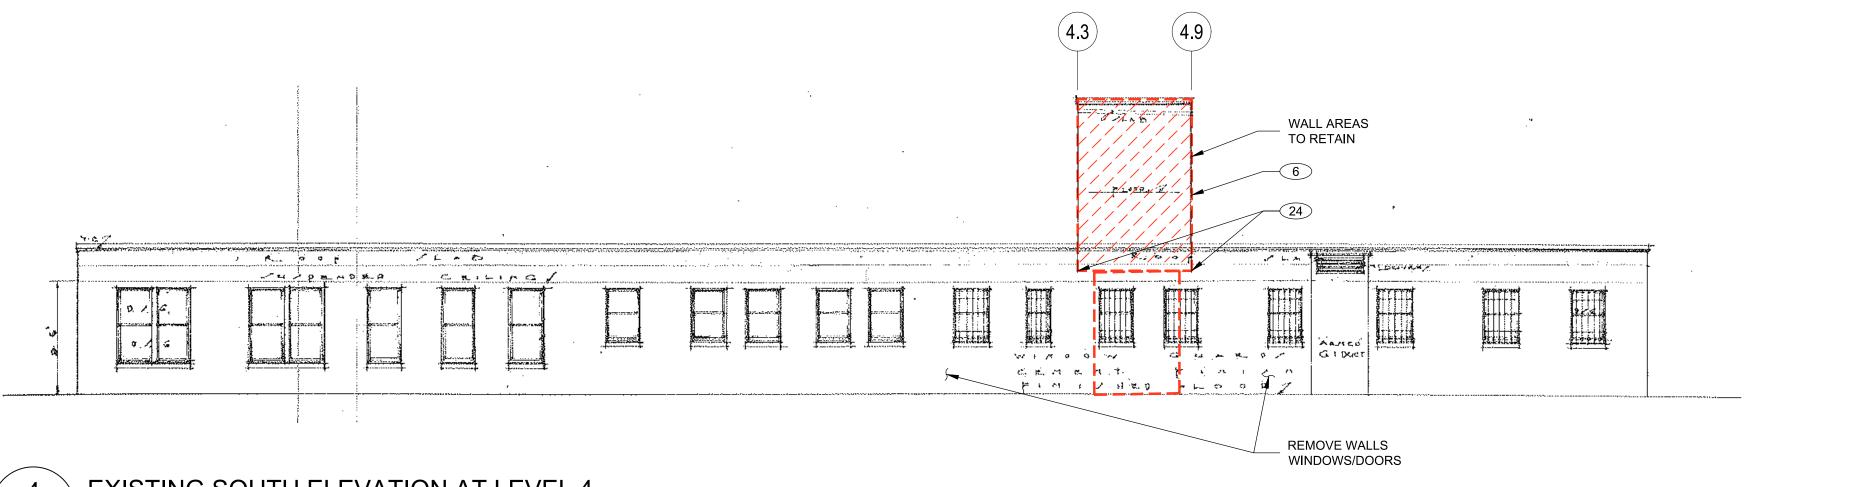

4 EXISTING SOUTH ELEVATION AT LEVEL 4

SCALE: 1/8" = 1'-0". DO NOT SCALE!

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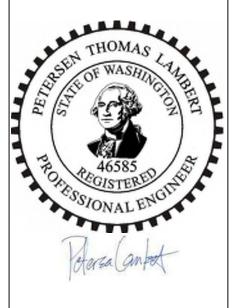


ABB Project # 22-7763.01 Skagit County Facilities Project # 3809

PROJECT NAME:
Skagit County Superior Court
Rooftop Jailhouse Removal

OWNER NAME / ADDRESS:
Skagit County,
a Municipal Corporation
1800 Continental Place
Mount Vernon, WA 98273

PROPERTY ADDRESS:
205 W. Kincaid Street
Mount Vernon, WA 98273

PROPERTY MANAGER:
Skagit County Facilities
Management
1800 Continental Place
Mount Vernon, WA 98273

Contact: Ken Hansen

Mark	Description	Date
	CONSTRUCTION PLANS (REVISED)	03/20/23
	BID SET ISSUE	04/24/23
1	PERMIT CORRECTION BID SET	06/21/23
	BID SET ISSUE	09/25/23


CITY OF MOUNT VERNON PERMIT NUMBER BLDG23-0137


SHEET TITLE

DEMOLITION 4TH FLOOR JAIL ELEVATIONS

SCALE: NOTED ON DRAWINGS

D3.1

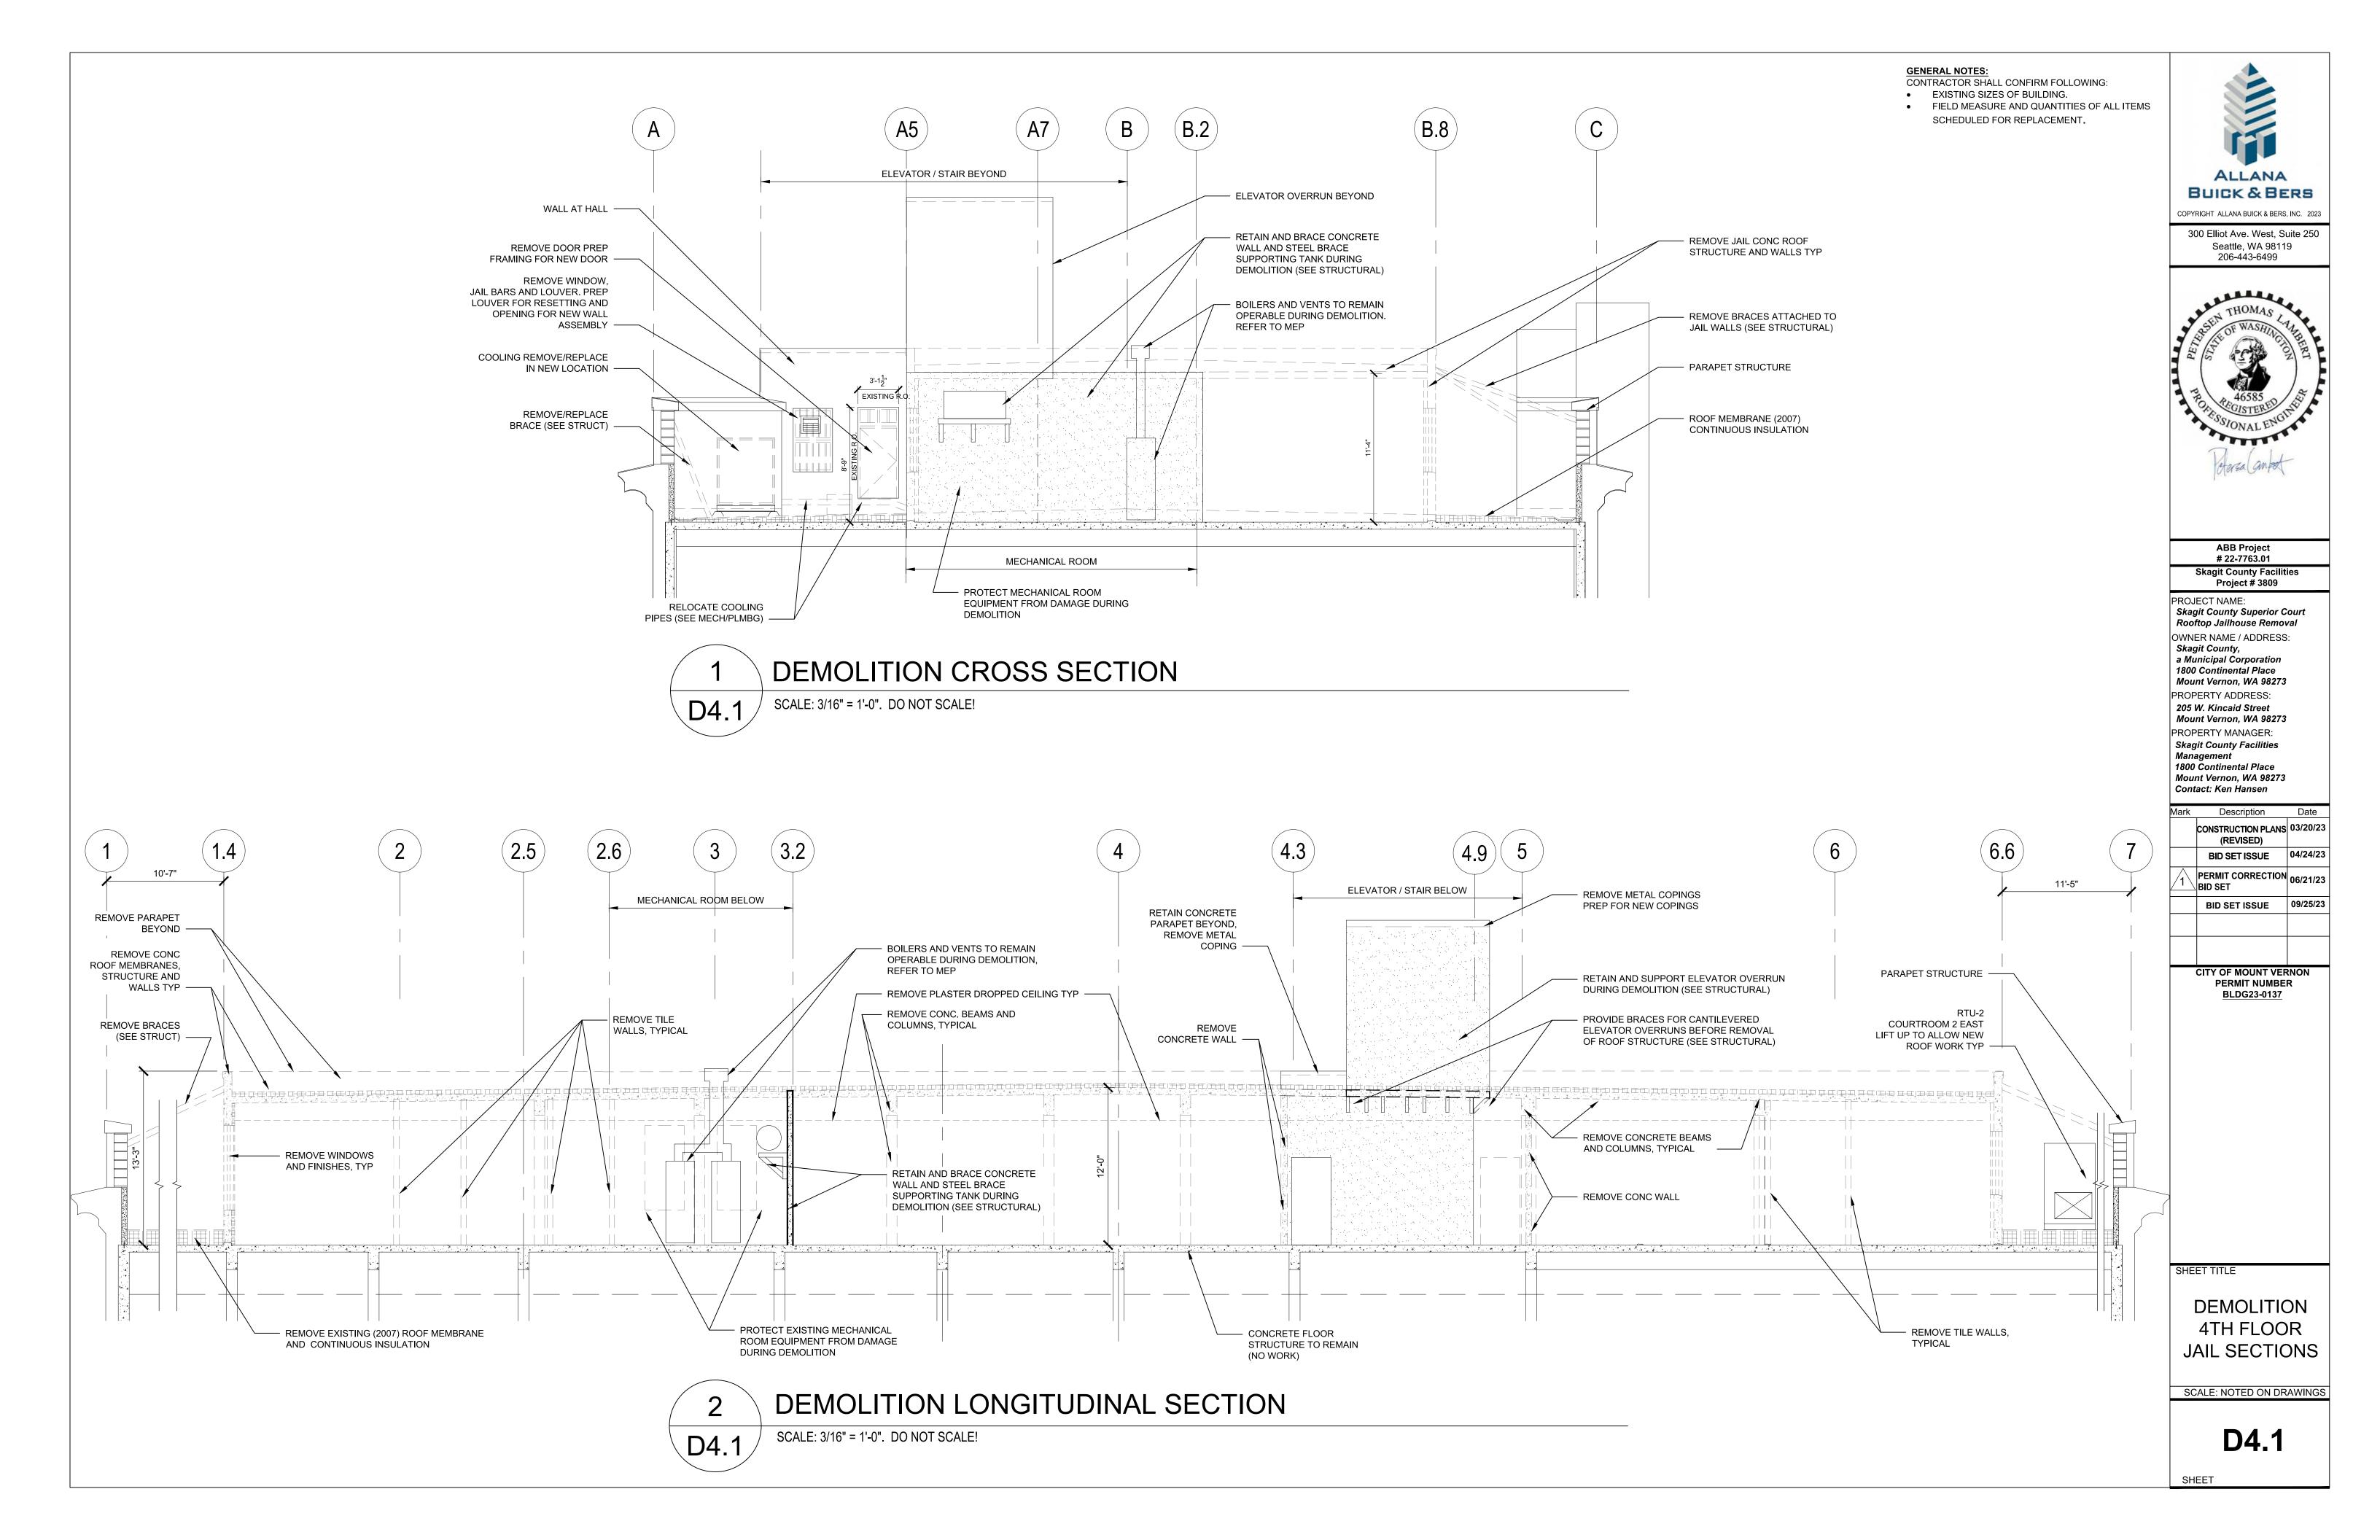

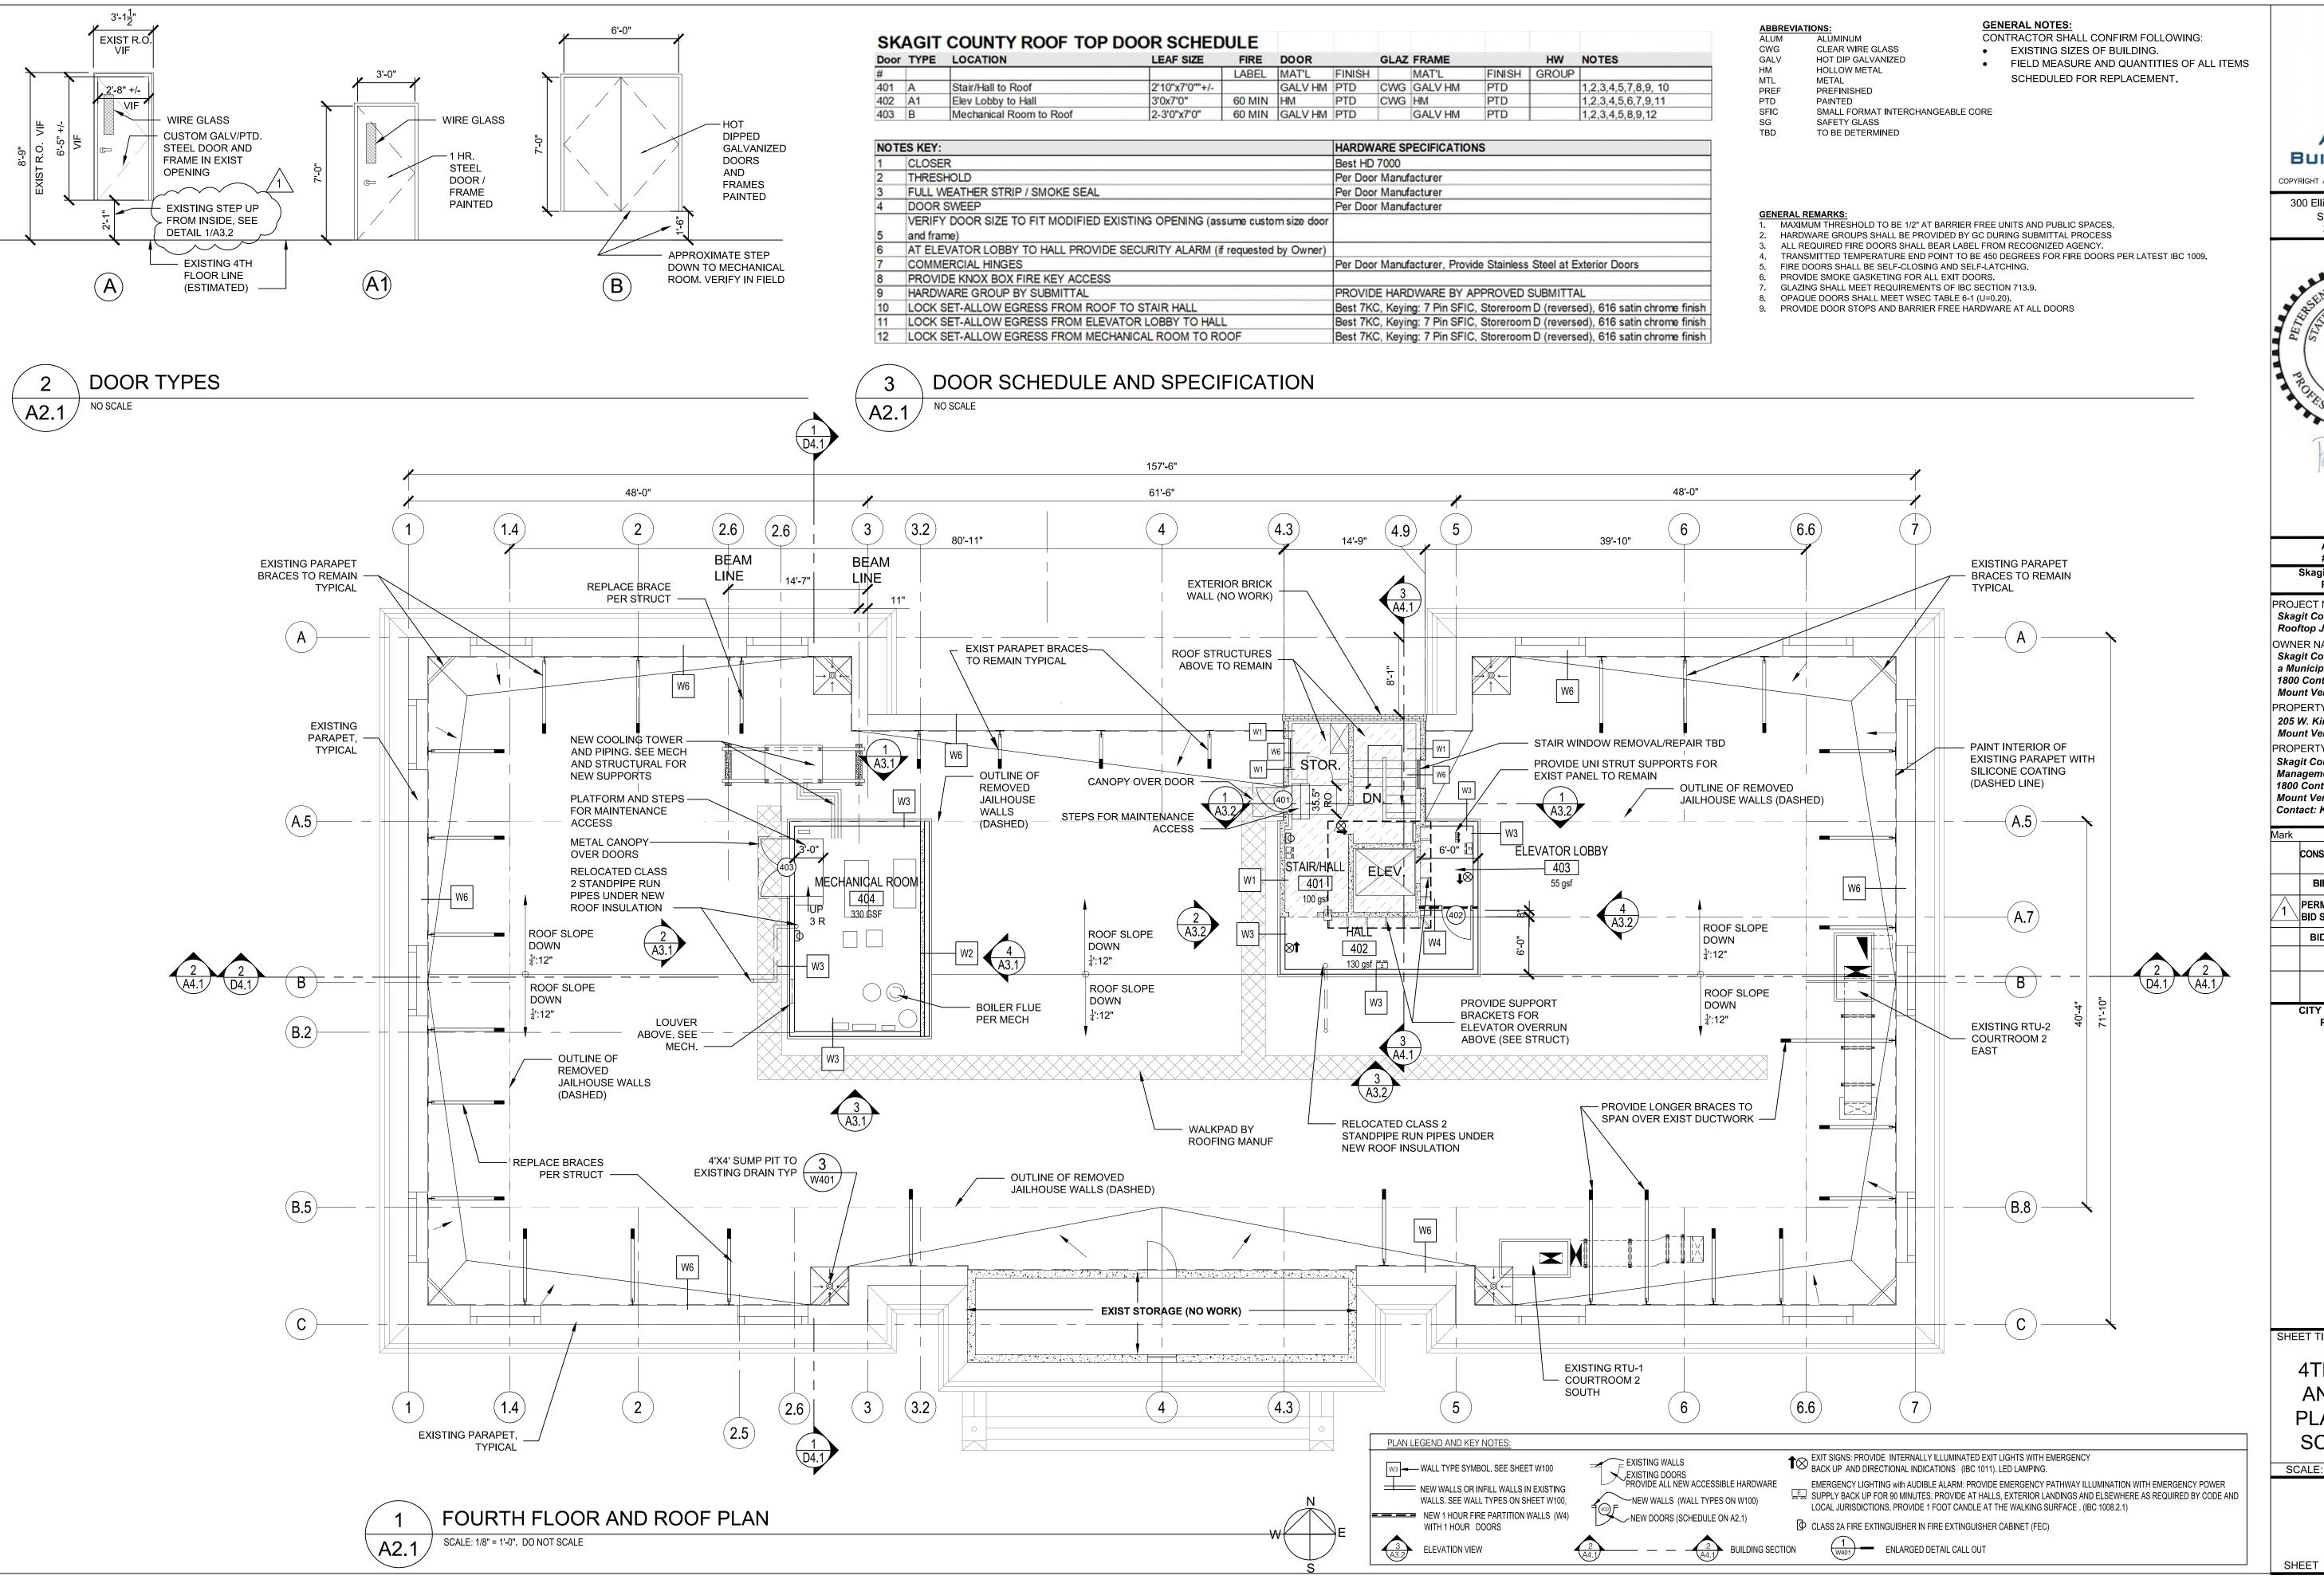



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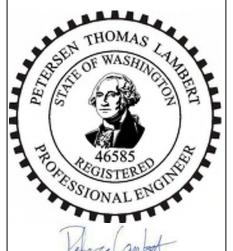


ABB Project # 22-7763.01 Skagit County Facilities **Project # 3809** 

PROJECT NAME: Skagit County Superior Court Rooftop Jailhouse Removal OWNER NAME / ADDRESS: Skagit County, a Municipal Corporation 1800 Continental Place Mount Vernon, WA 98273 PROPERTY ADDRESS: 205 W. Kincaid Street Mount Vernon, WA 98273 PROPERTY MANAGER: Skagit County Facilities Management 1800 Continental Place Mount Vernon, WA 98273 Contact: Ken Hansen

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	BID SET ISSUE	09/25/23

**CITY OF MOUNT VERNON** PERMIT NUMBER BLDG23-0137

SHEET TITLE

4TH FLOOR **AND ROOF** PLAN DOOR SCHEDULE

SCALE: NOTED ON DRAWINGS

**A2.1** 

- GENERAL NOTES:
  CONTRACTOR SHALL CONFIRM FOLLOWING: EXISTING SIZES OF BUILDING.
- FIELD MEASURE AND QUANTITIES OF ALL ITEMS SCHEDULED FOR REPLACEMENT.



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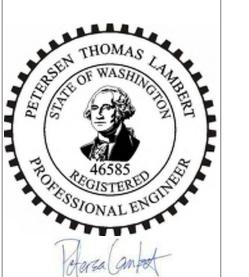


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1 PI	ONSTRUCTION PLANS (REVISED) BID SET ISSUE	03/20/2
/ <b>1</b> \	BID SET ISSUE	04/24/2
/ <b>1</b> \		
·	ERMIT CORRECTION ID SET	06/21/2:
	BID SET ISSUE	09/25/23


CITY OF MOUNT VERNON PERMIT NUMBER BLDG23-0137


SHEET TITLE


UPPER **ROOF PLAN** 

SCALE: NOTED ON DRAWINGS


**A2.2** 

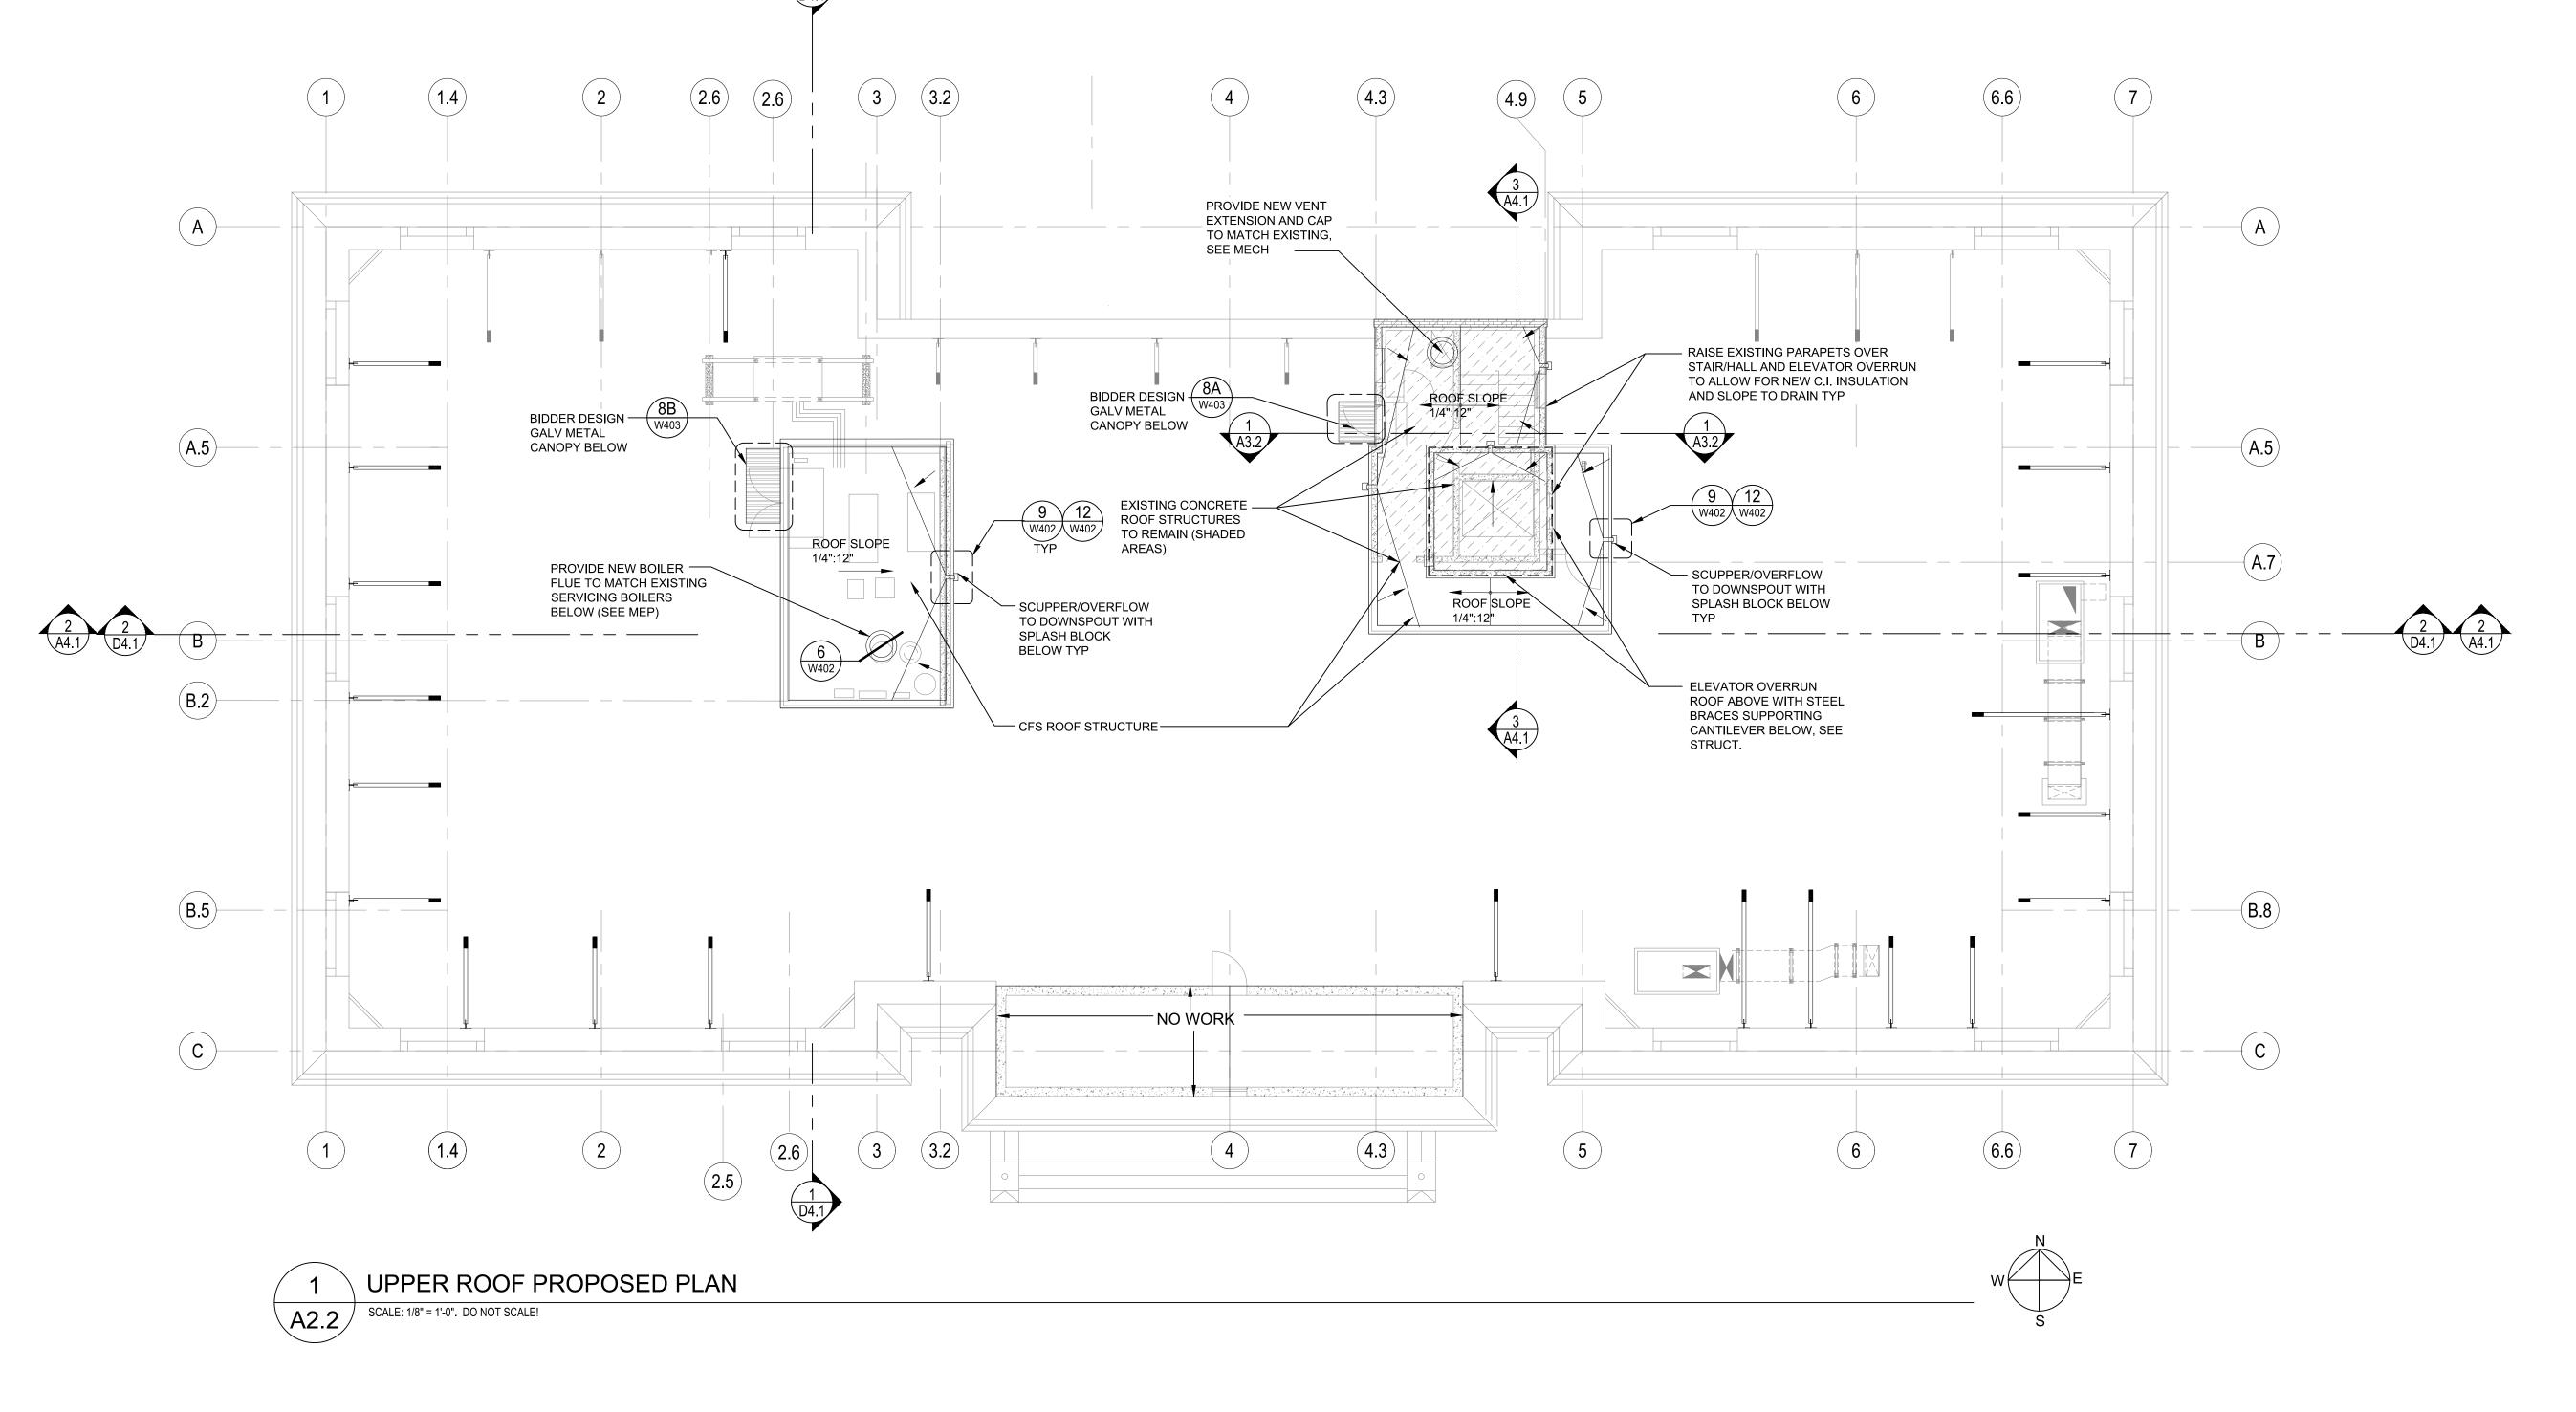

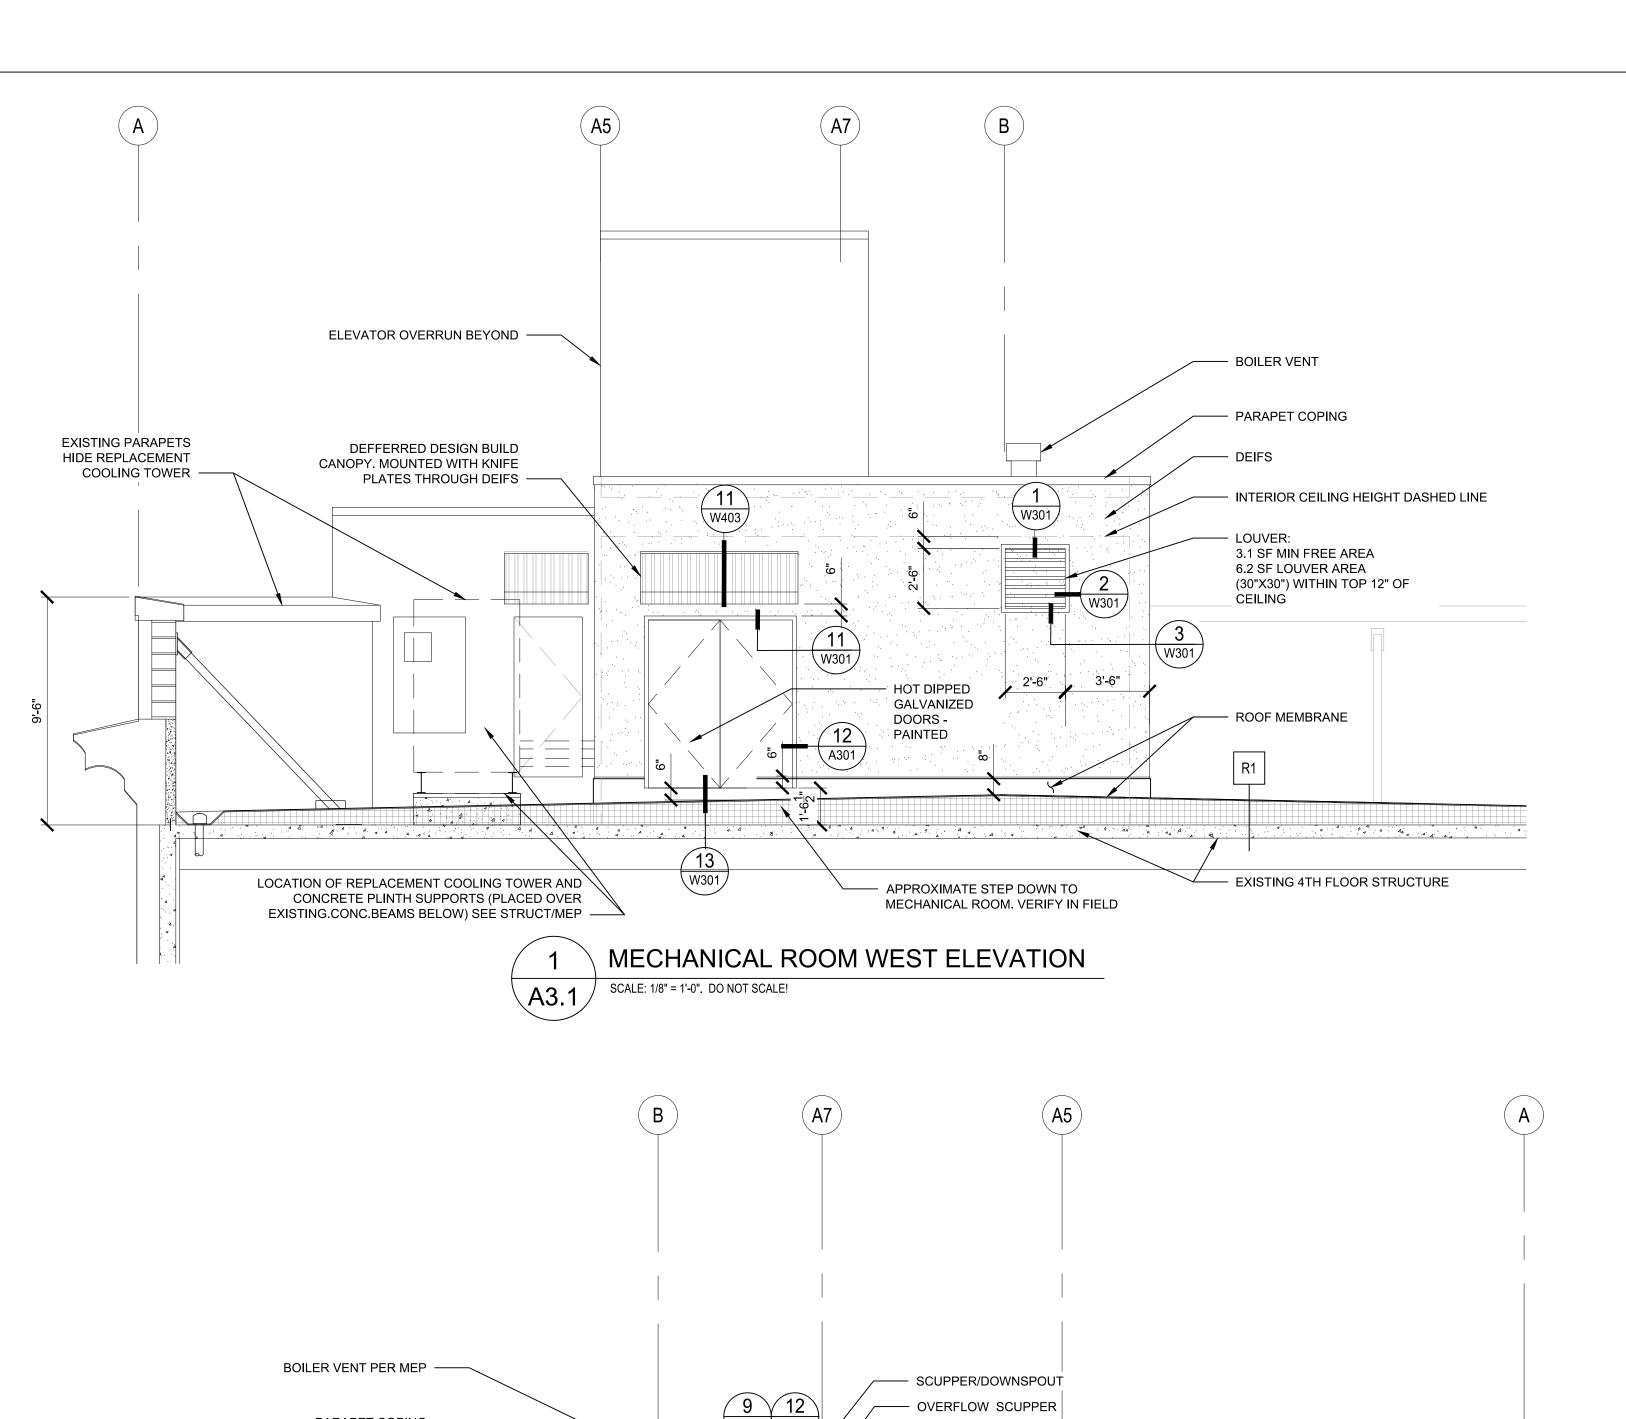


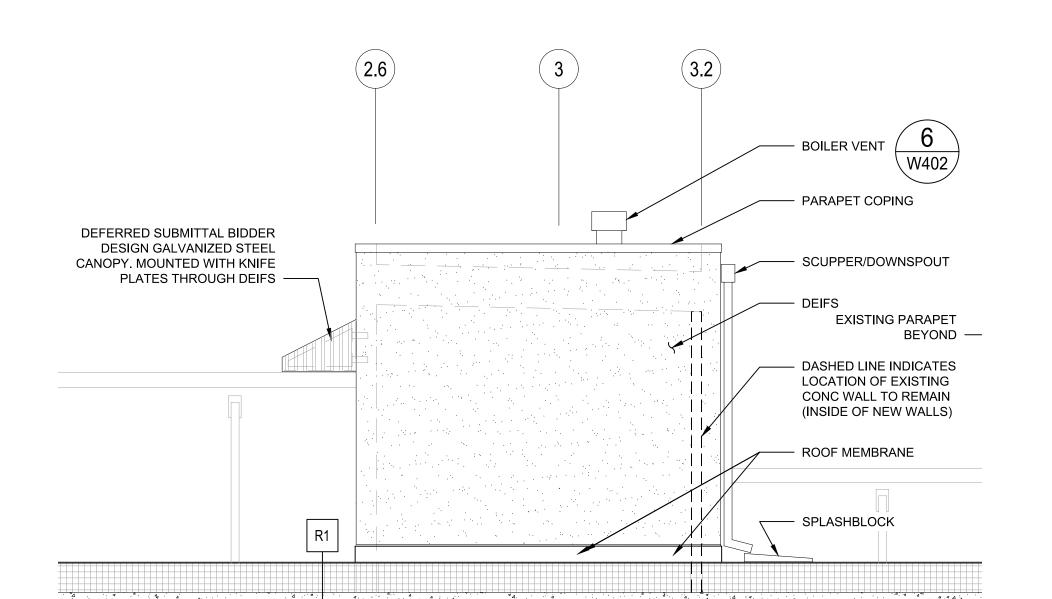

2 MECHANICAL ROOM - SOUTH ELEVATION
A3.1 SCALE: 1/8" = 1'-0". DO NOT SCALE!

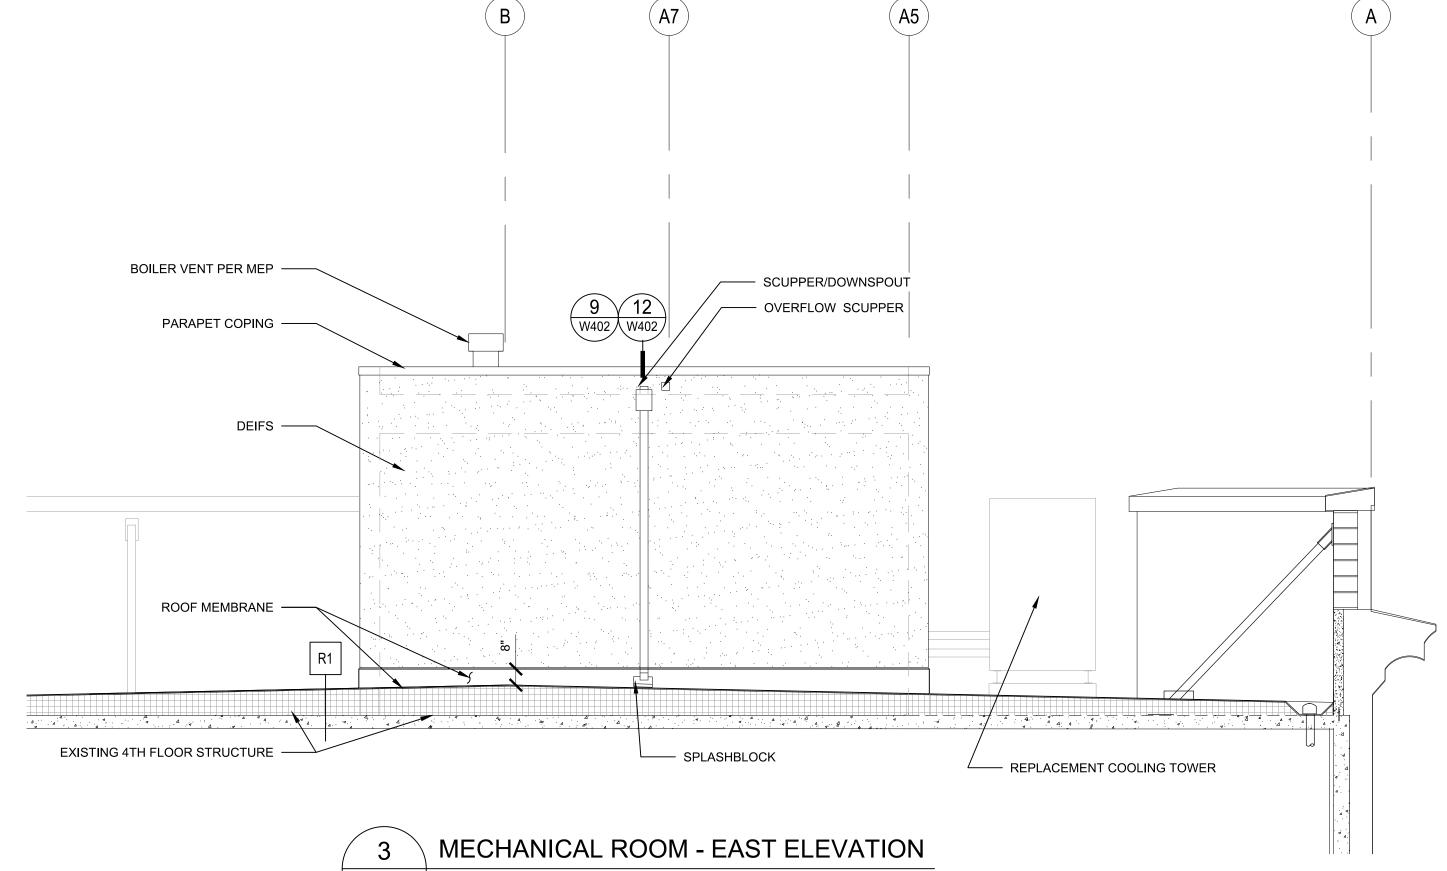

SCALE: 1/8" = 1'-0". DO NOT SCALE!

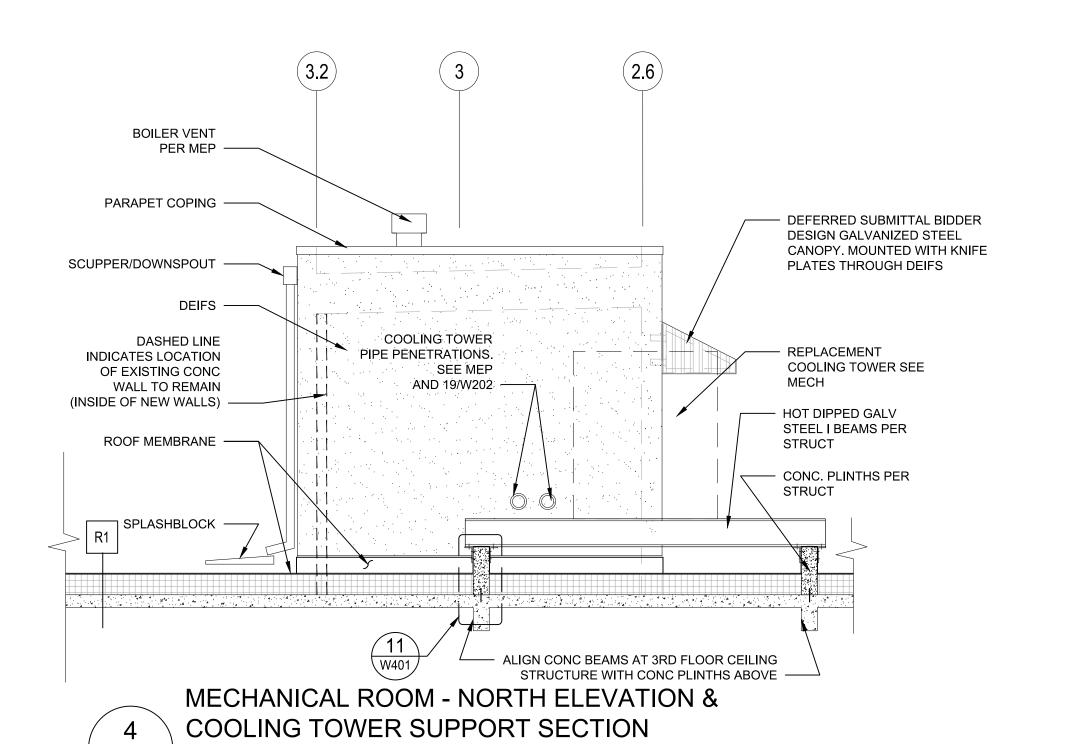

SCALE: 1/8" = 1'-0". DO NOT SCALE!



**GENERAL NOTES:** 

CONTRACTOR SHALL CONFIRM FOLLOWING:

SCHEDULED FOR REPLACEMENT.

FIELD MEASURE AND QUANTITIES OF ALL ITEMS

EXISTING SIZES OF BUILDING.

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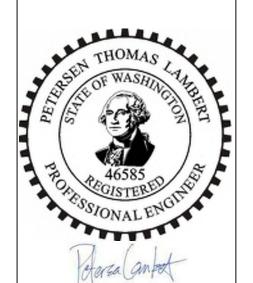


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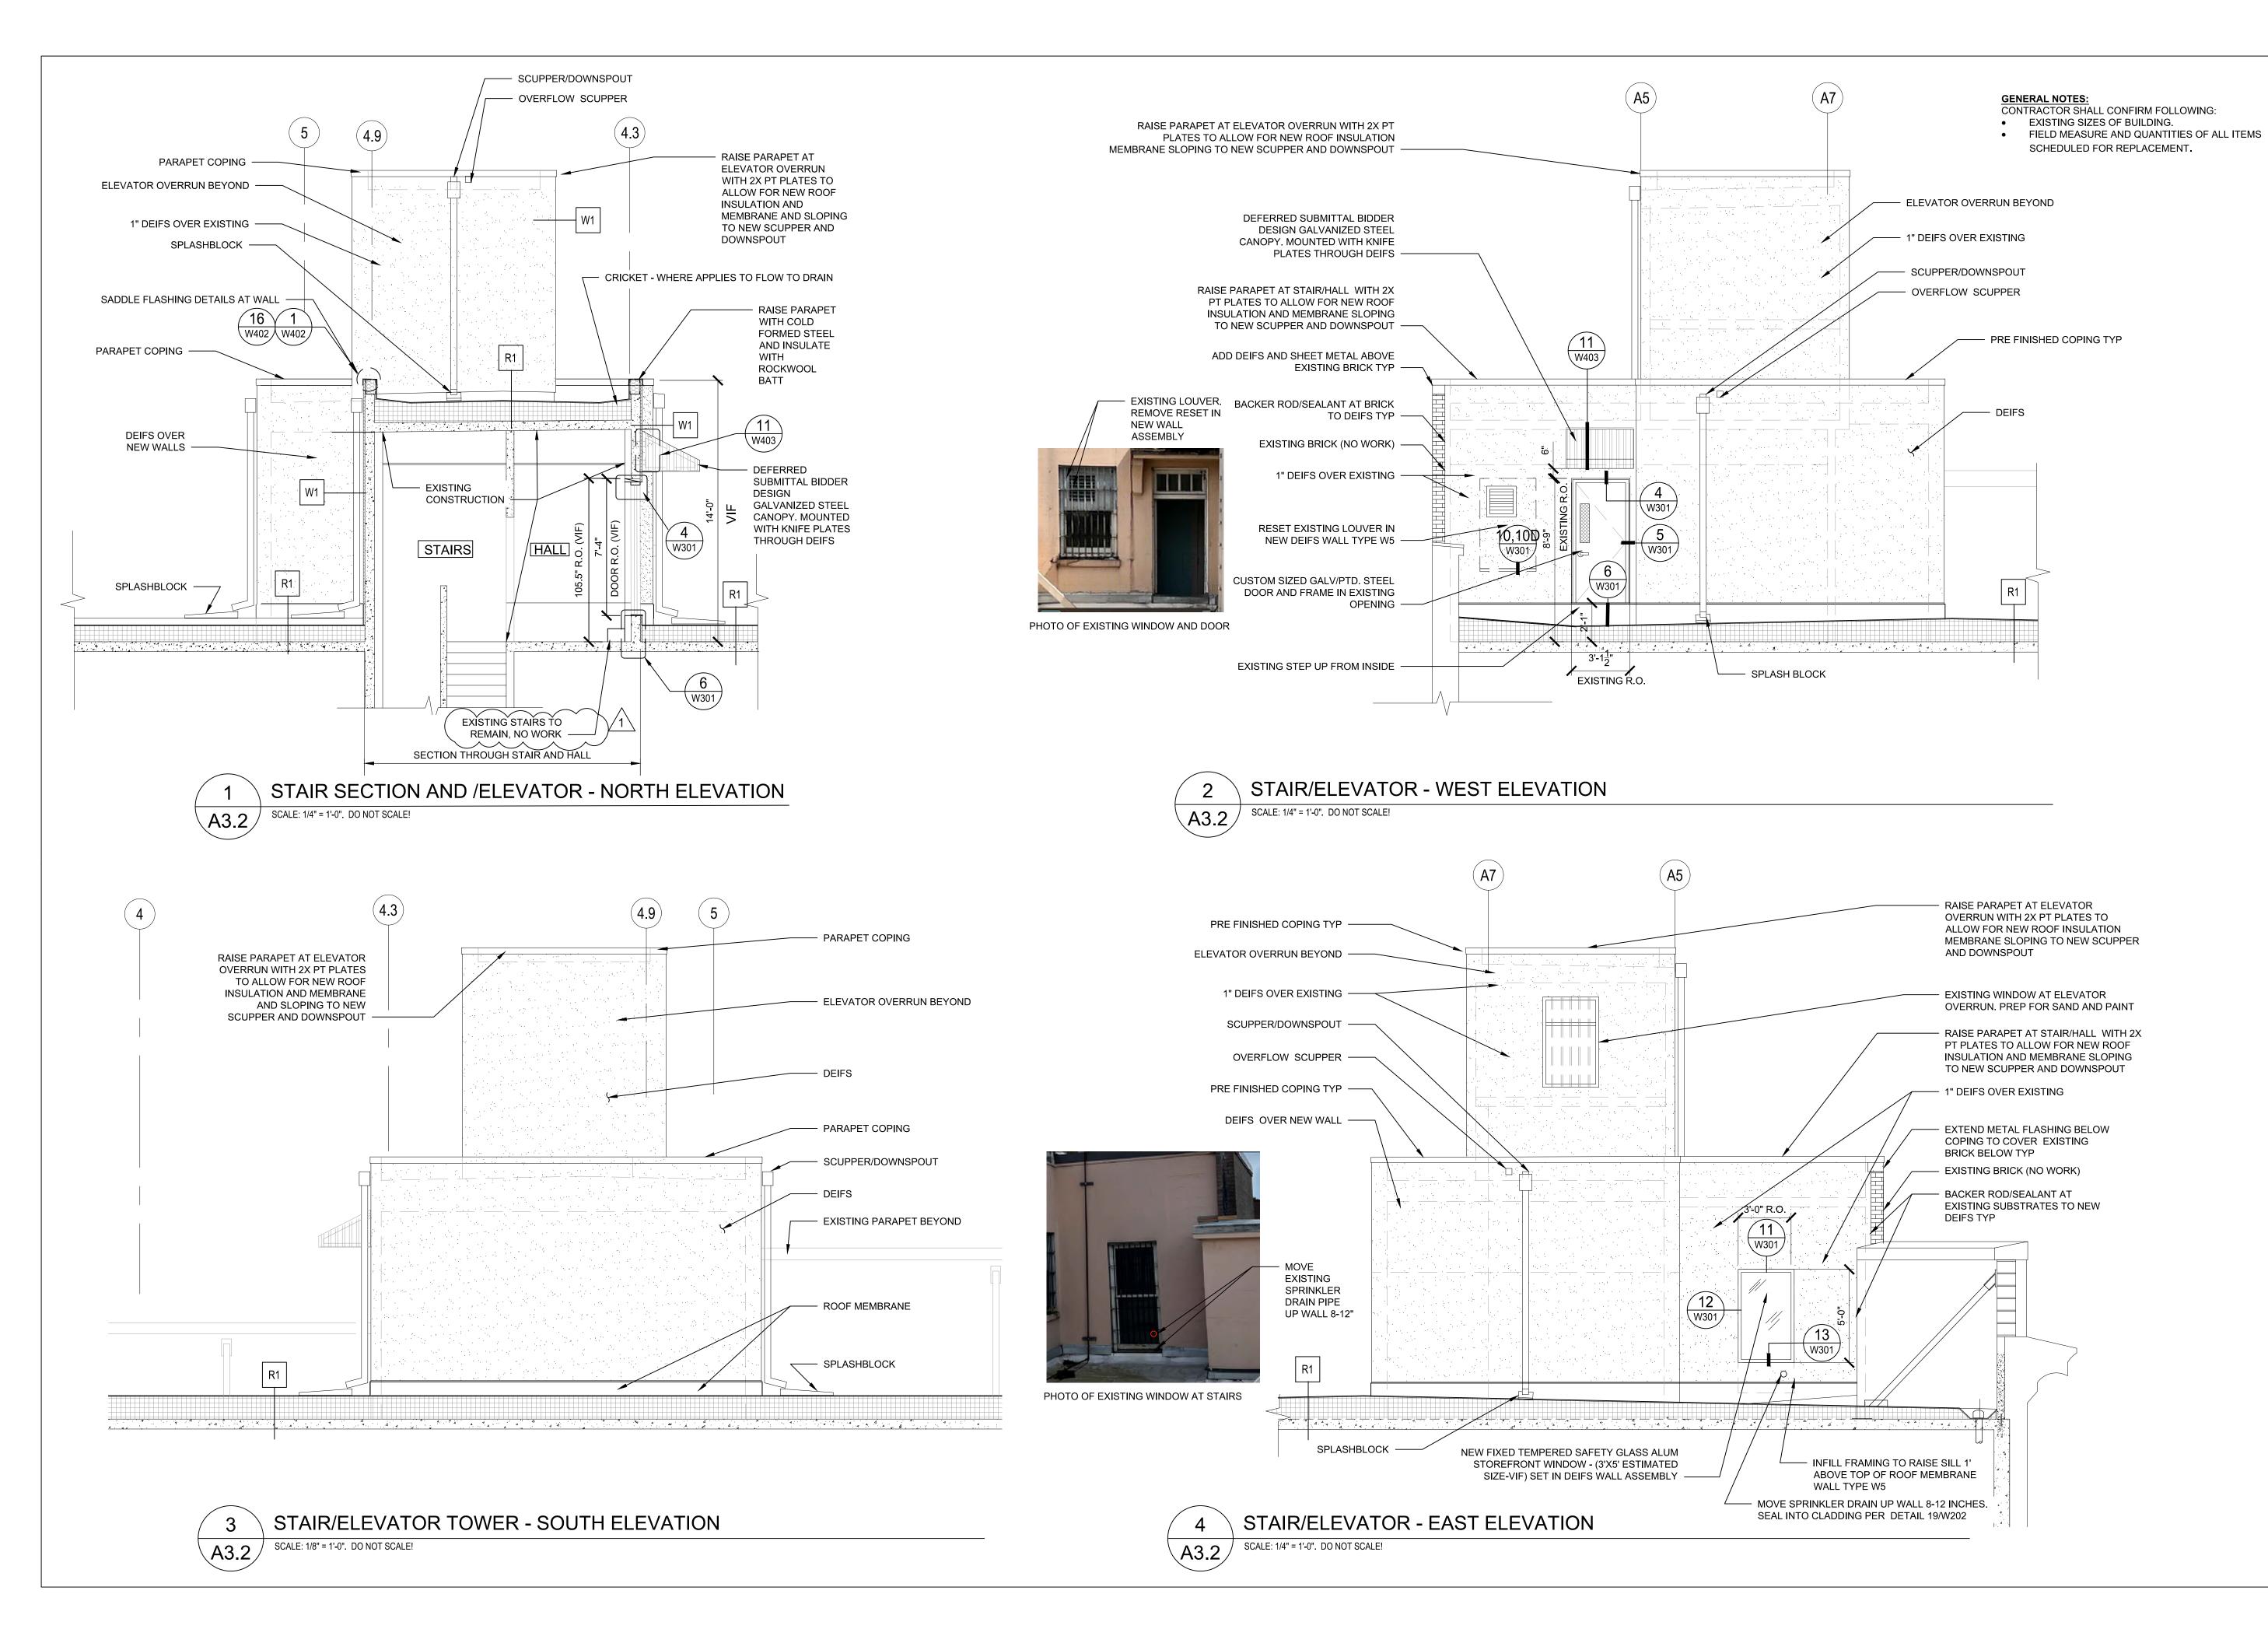
CITY OF MOUNT VERNON PERMIT NUMBER BLDG23-0137

SHEET TITLE

MECHANICAL ROOM ELEVATIONS

SCALE: NOTED ON DRAWINGS

A3.1



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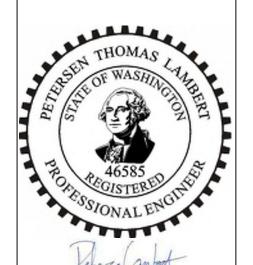


ABB Project # 22-7763.01 Skagit County Facilities

Project # 3809 PROJECT NAME: Skagit County Superior Court Rooftop Jailhouse Removal OWNER NAME / ADDRESS: Skagit County, a Municipal Corporation 1800 Continental Place Mount Vernon, WA 98273 PROPERTY ADDRESS: 205 W. Kincaid Street Mount Vernon, WA 98273 PROPERTY MANAGER: Skagit County Facilities Management 1800 Continental Place Mount Vernon, WA 98273 Contact: Ken Hansen

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	CITY OF MOUNT VER	RNON


PERMIT NUMBER BLDG23-0137


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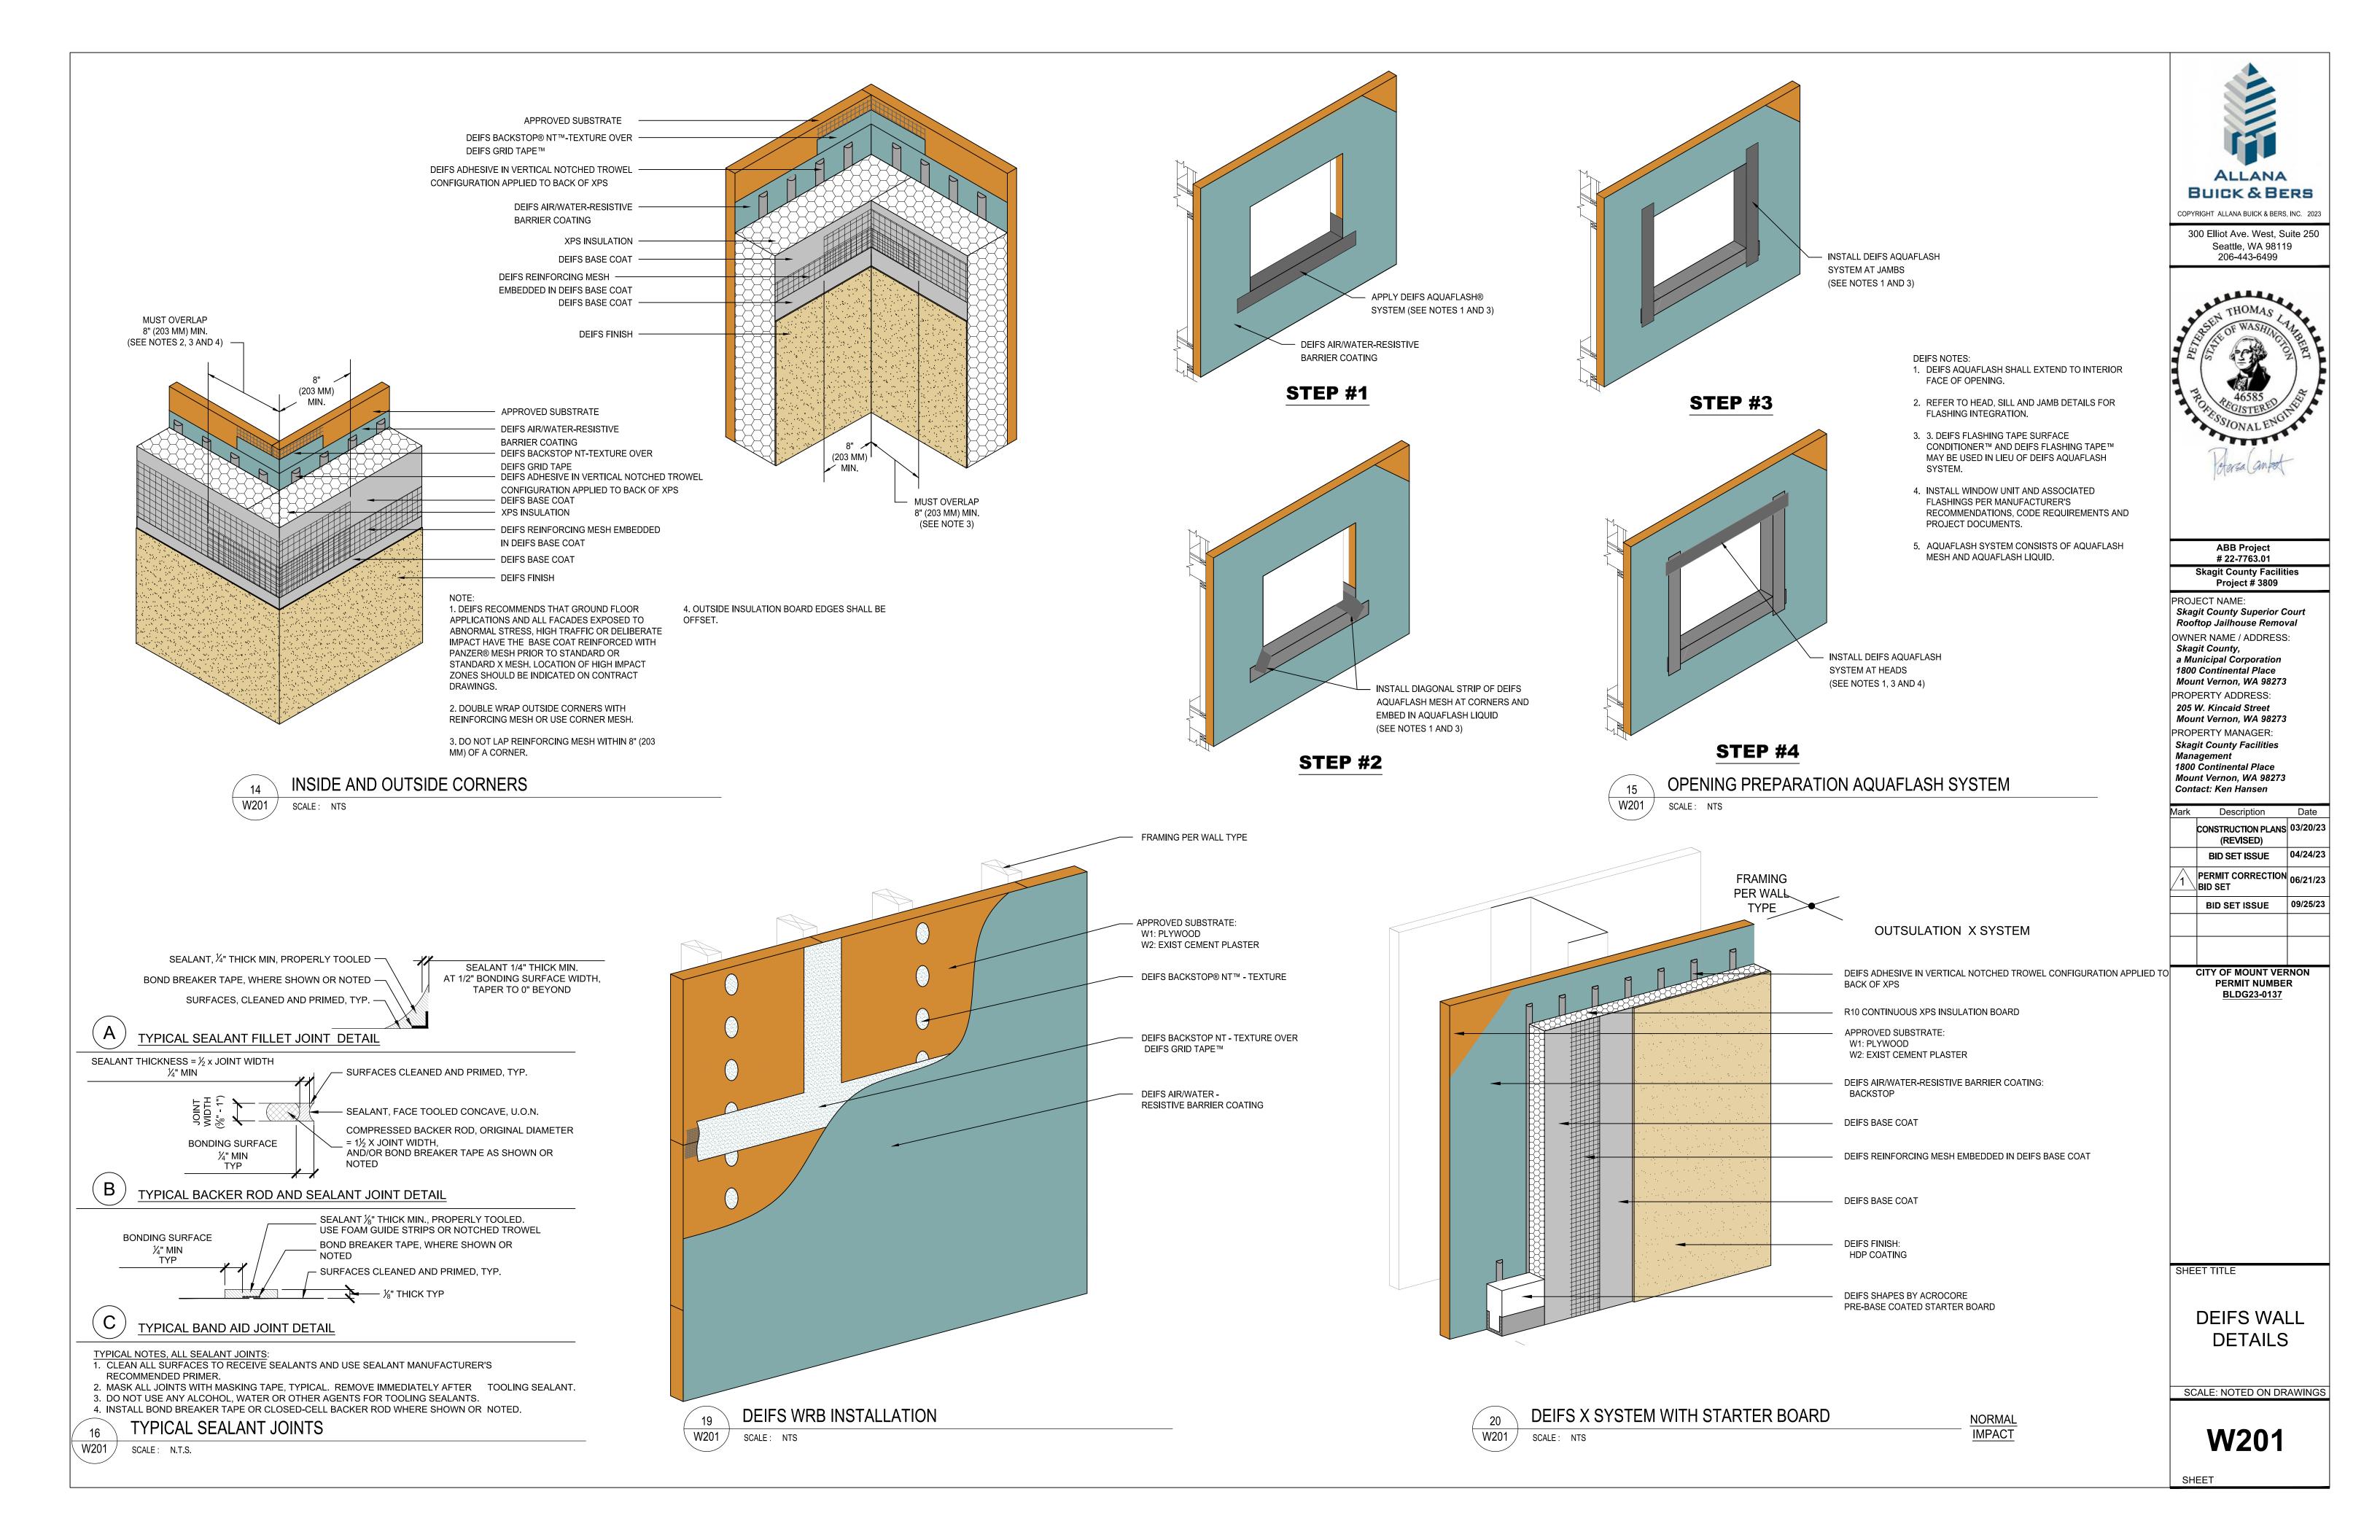
STAIR AND ELEVATOR TOWER ELEVATIONS


SCALE: NOTED ON DRAWINGS

A3.2



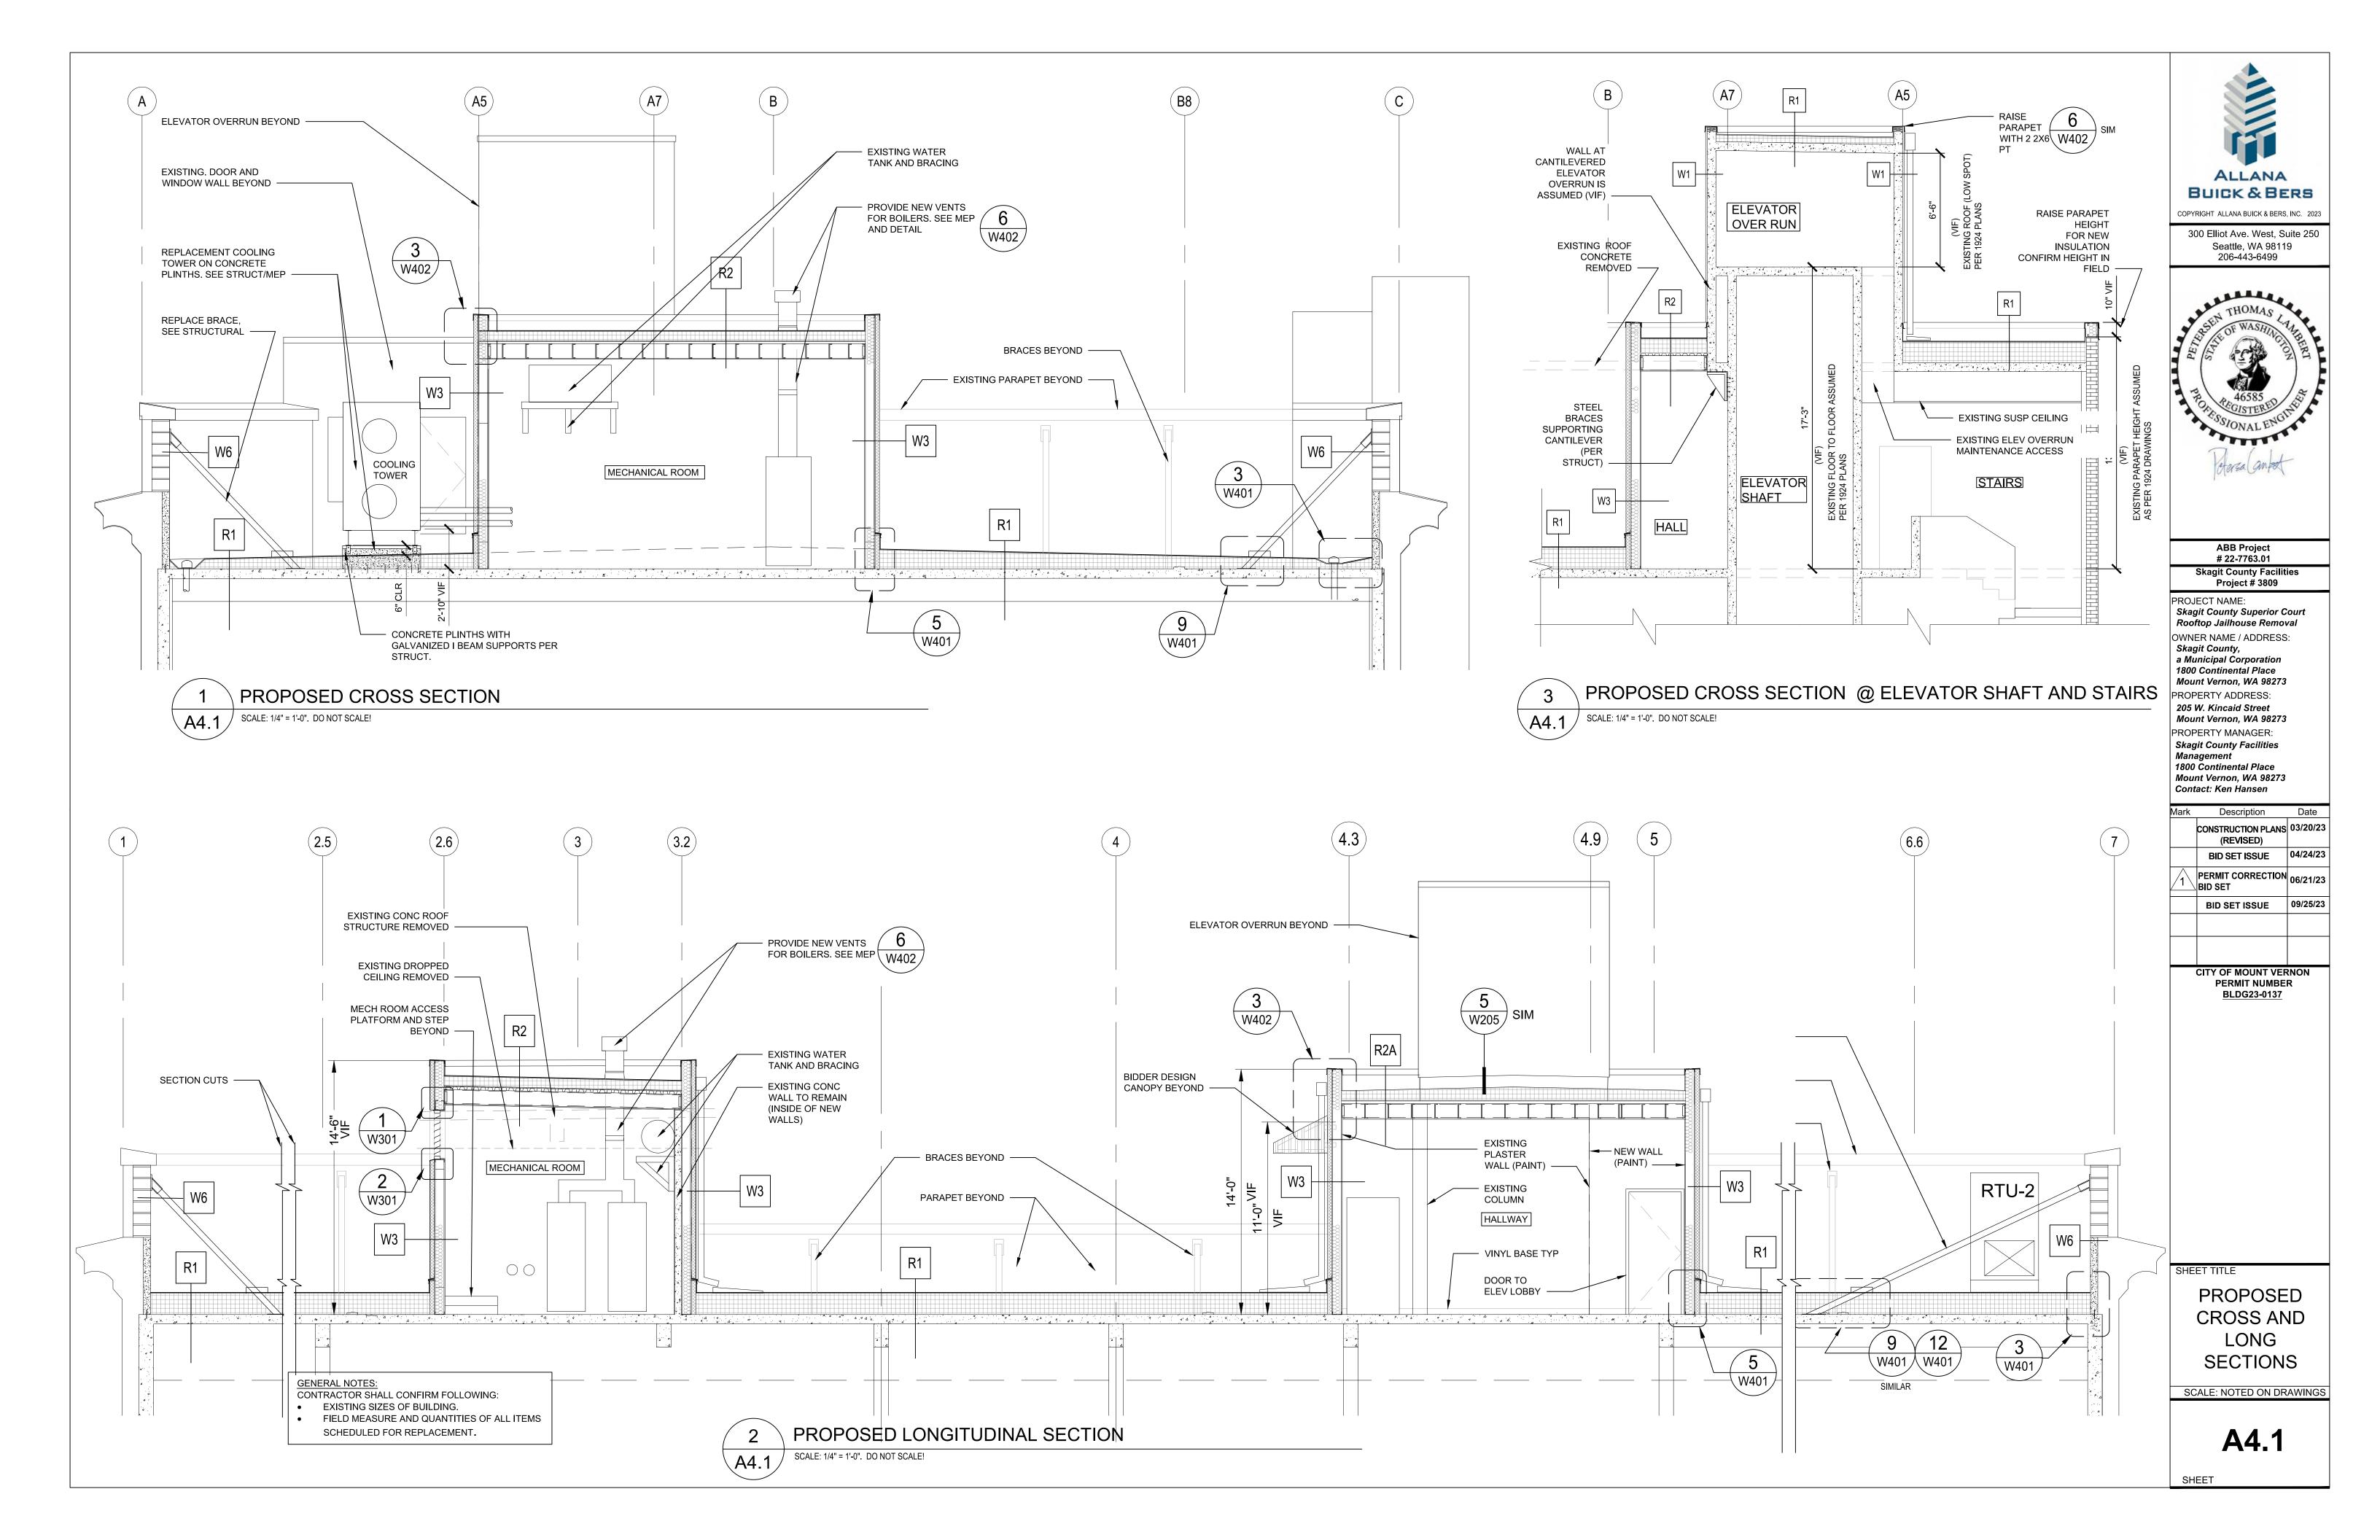

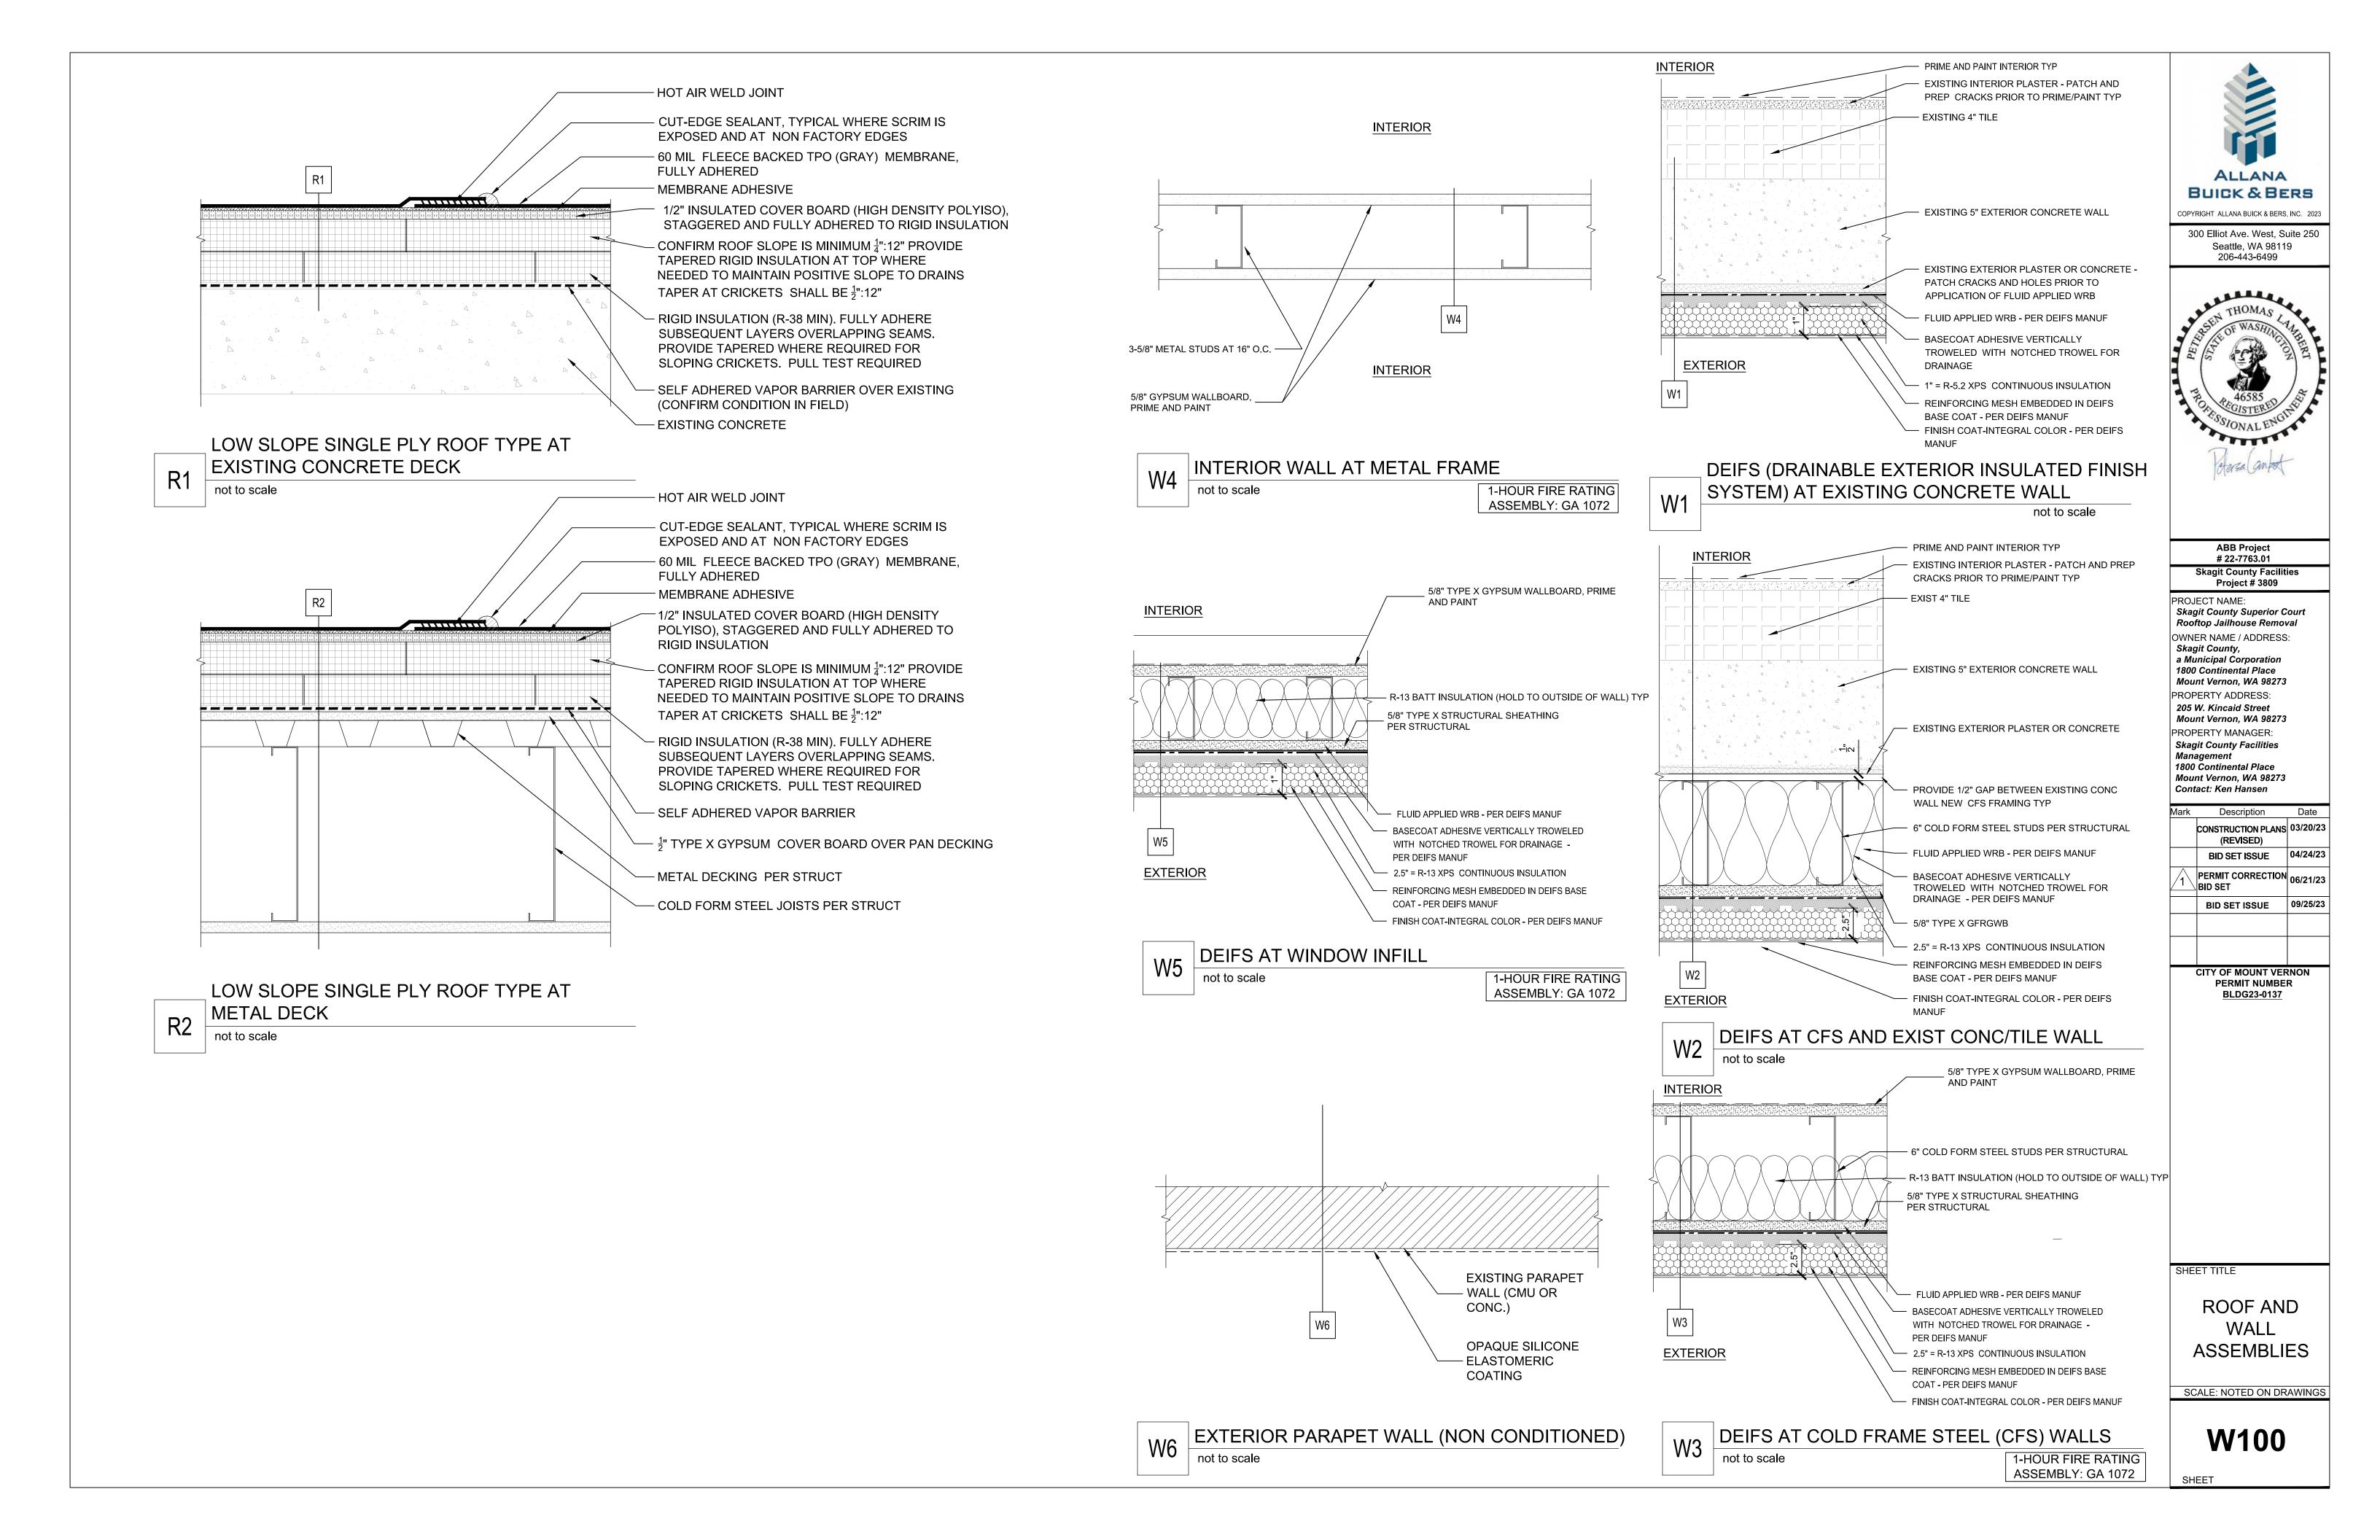

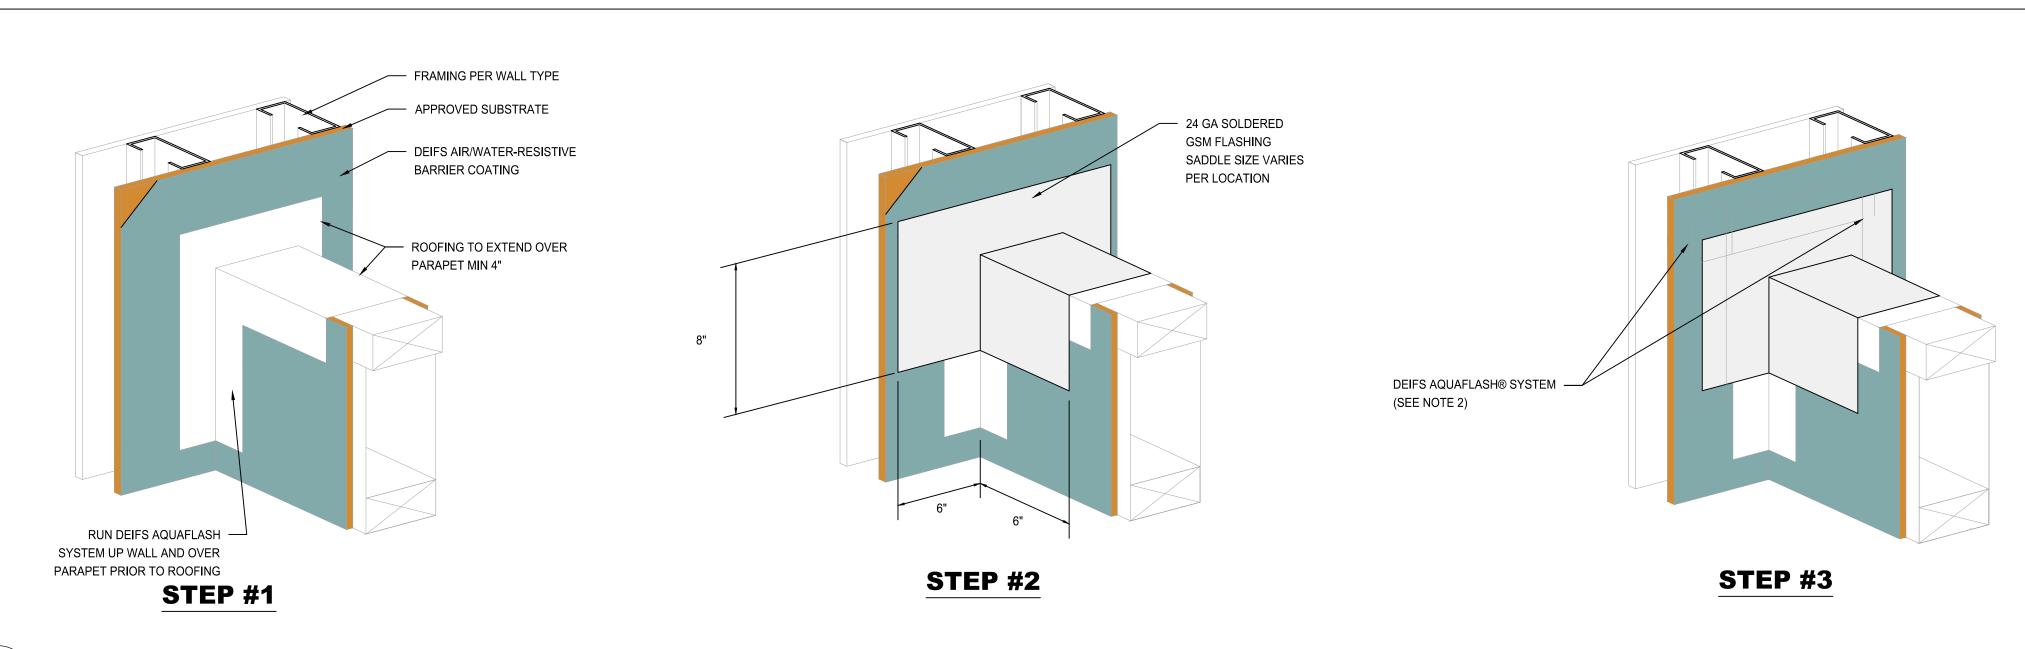

DIMENSION IS EXCEEDED.

W202

SCALE: NTS


6. LIGHTLY SAND SURFACE OF DRAINAGE

TRACK TO MAXIMIZE ADHESION.

BASE OF WALL TERMINATION


1. DEIFS RECOMMENDS THAT GROUND FLOOR APPLICATIONS AND ALL FACADES EXPOSED TO ABNORMAL STRESS, HIGH TRAFFIC, OR DELIBERATE IMPACT HAVE THE BASE COAT REINFORCED WITH PANZER® MESH PRIOR TO STANDARD OR STANDARD X MESH. LOCATION OF HIGH IMPACT ZONES SHOULD BE INDICATED ON CONTRACT DRAWINGS.

2. DEIFS FLASHING TAPE SURFACE CONDITIONER™ AND DEIFS FLASHING TAPE™ MAY BE USED IN LIEU OF DEIFS AQUAFLASH SYSTEM.

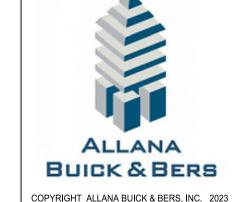

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206-443-6499

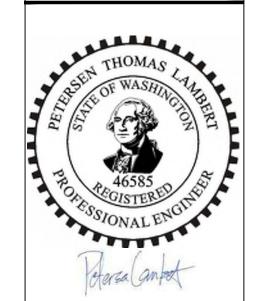

#### ABB Project # 22-7763.01 Skagit County Facilities **Project # 3809**

Skagit County Superior Court Rooftop Jailhouse Removal OWNER NAME / ADDRESS: Skagit County, a Municipal Corporation 1800 Continental Place Mount Vernon, WA 98273 PROPERTY ADDRESS: 205 W. Kincaid Street Mount Vernon, WA 98273 PROPERTY MANAGER: Skagit County Facilities Management 1800 Continental Place Mount Vernon, WA 98273 Contact: Ken Hansen

Mark	Description	Date
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1	PERMIT CORRECTION BID SET	06/21/2
	BID SET ISSUE	09/25/2

**CITY OF MOUNT VERNON** PERMIT NUMBER BLDG23-0137

SHEET TITLE


**DEIFS WALL DETAILS** 

SCALE: NOTED ON DRAWINGS

**W202** 


SHEET


PENETRATIONS TYPICAL W202 / SCALE: NTS

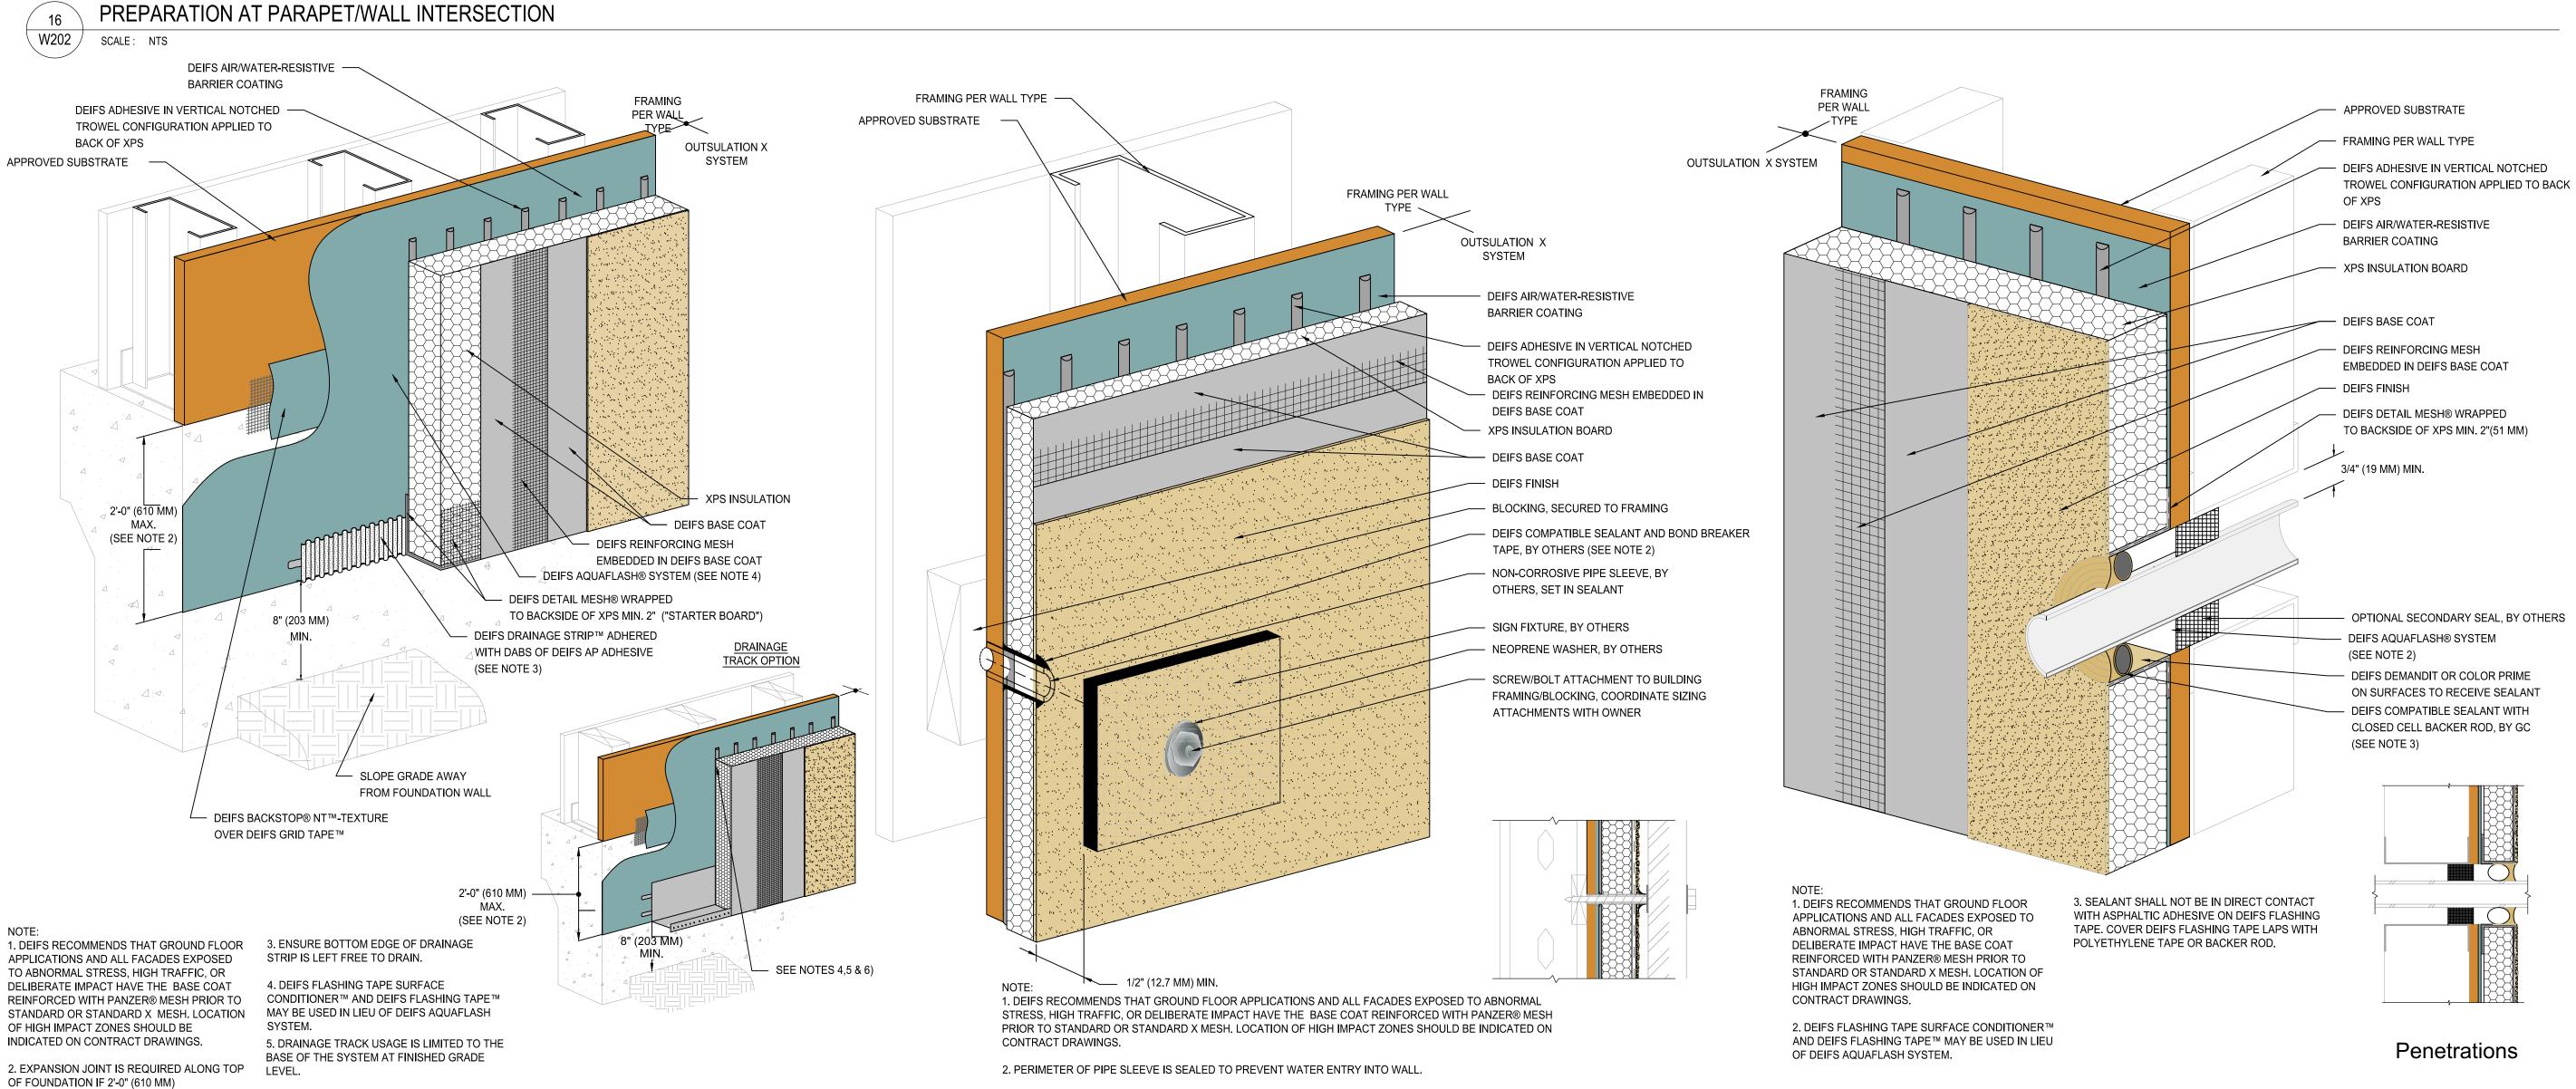

SIGN ATTACHMENT

SCALE: NTS

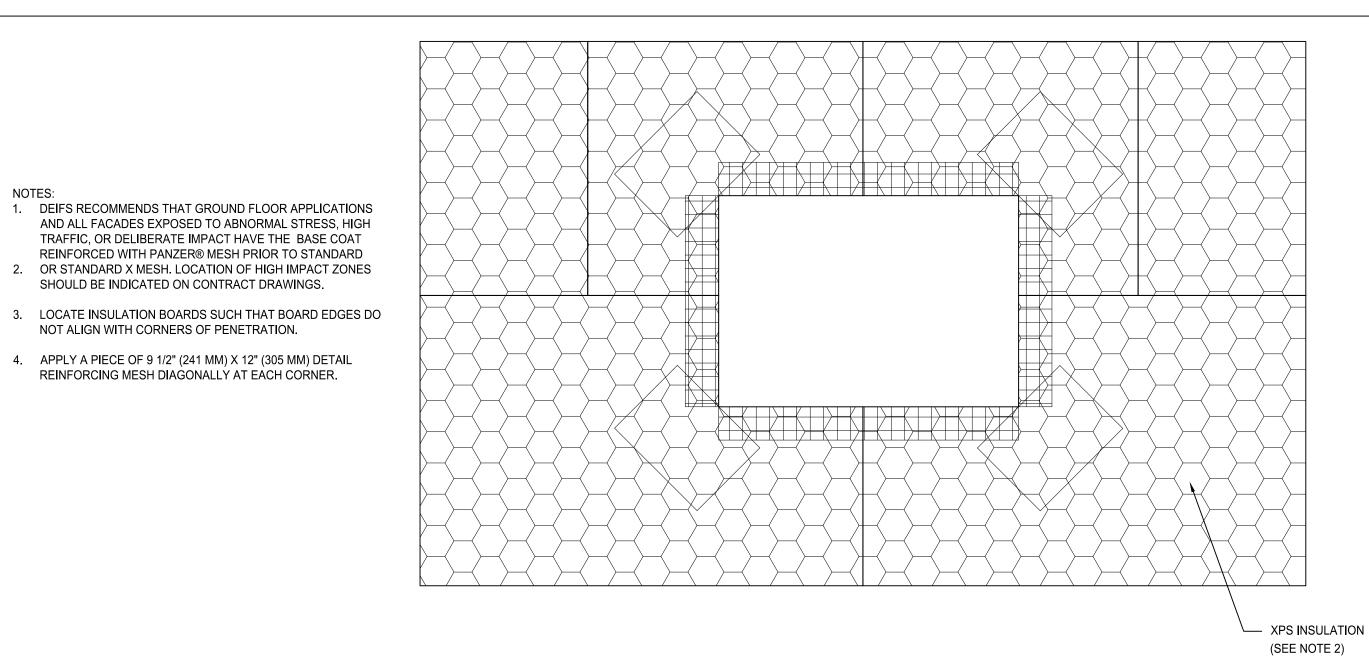

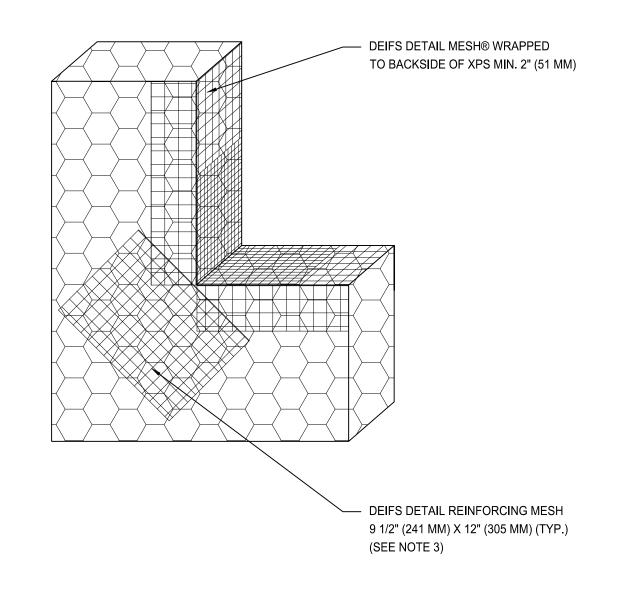



W202 / SCALE: NTS


SHOULD BE INDICATED ON CONTRACT DRAWINGS.

NOT ALIGN WITH CORNERS OF PENETRATION.

FRAMING PER WALL TYPE APPROVED SUBSTRATE DEIFS AIR/WATER-RESISTIVE BARRIER COATING (SEE NOTE 3) - DEIFS ADHESIVE IN VERTICAL NOTCHED TROWEL CONFIGURATION APPLIED TO BACK OF XPS DEIFS DRAINAGE STRIP™ ADHERED -WITH DABS OF DEIFS AP ADHESIVE - XPS INSULATION BOARD (SEE NOTE 2) DEIFS BACKSTOP® NT™-TEXTURE — OVER DEIFS GRID TAPE™ DEIFS REINFORCING MESH EMBEDDED IN DEIFS BASE COAT — DEIFS BASE COAT — DEIFS FINISH **DEIFS ADHESIVE** APPLIED TO BACK OF XPS DEIFS DETAIL MESH® WRAPPED -TO BACKSIDE OF XPS MIN. 2" (51 MM) DEIFS FINISH DRAINAGE CHANNEL


1. DEIFS RECOMMENDS THAT GROUND FLOOR APPLICATIONS AND ALL FACADES EXPOSED TO ABNORMAL STRESS, HIGH TRAFFIC, OR DELIBERATE IMPACT HAVE THE BASE COAT REINFORCED WITH PANZER® MESH PRIOR TO STANDARD OR STANDARD X MESH. LOCATION OF HIGH IMPACT ZONES SHOULD BE INDICATED ON CONTRACT DRAWINGS.

- 2. ENSURE BOTTOM EDGE OF DRAINAGE STRIP IS LEFT FREE TO DRAIN.
- 3. DEIFS AIR/WATER-RESISTIVE BARRIER IS REQUIRED OVER VERTICAL SUBSTRATES, APPLICATION OVER HORIZONTAL SOFFIT SUBSTRATE IS OPTIONAL UNLESS REQUIRED AS PART OF A CONTINUOUS AIR BARRIER SYSTEM.

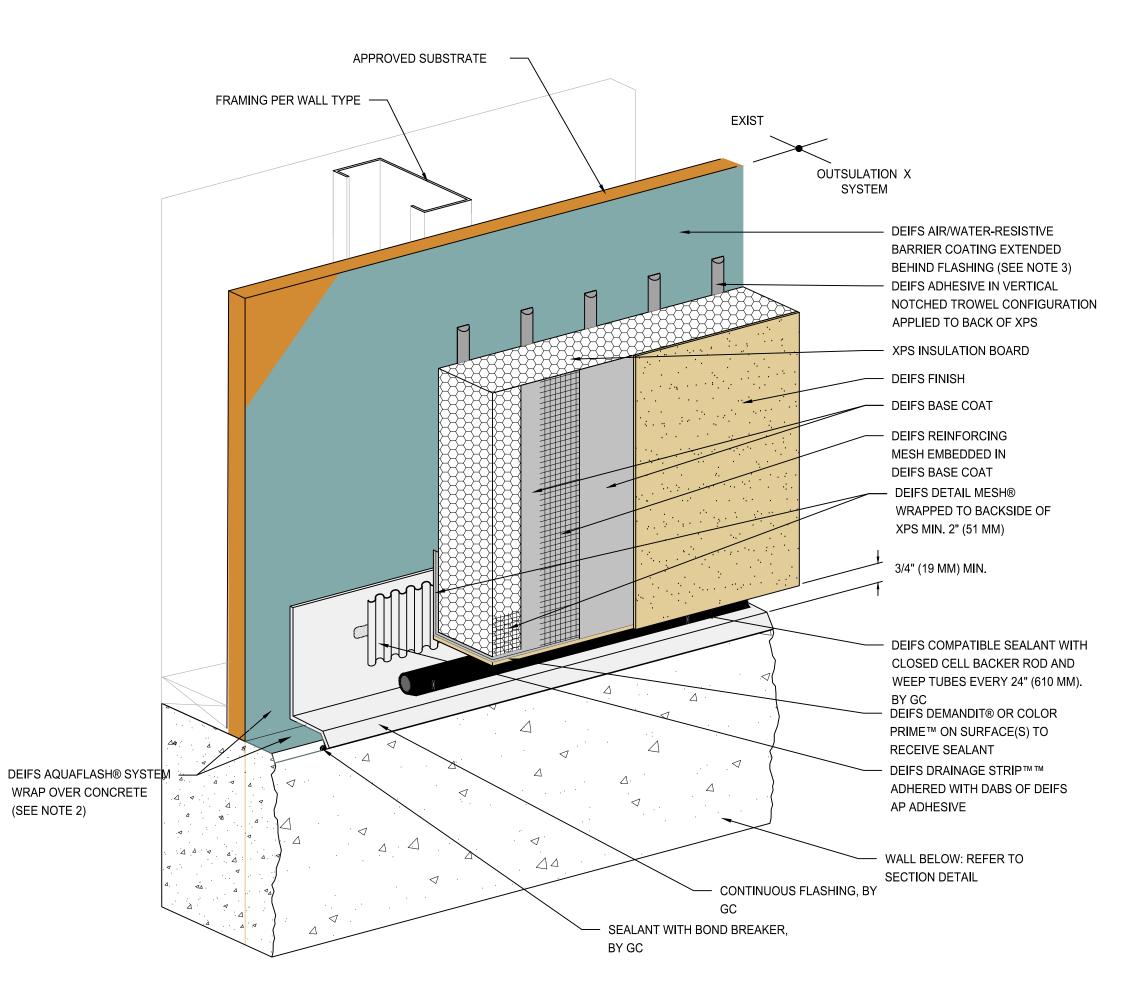

Transition At Soffit/ Fascia Intersection

TRANSITION AT FASCIA SOFFIT INTERSECTION W202 SCALE: NTS

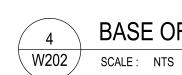

BASE OF WALL THROUGH WALL FLASHING CONCEPT

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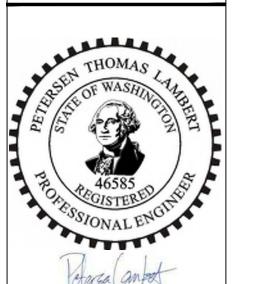


ABB Project # 22-7763.01 Skagit County Facilities Project # 3809

PROJECT NAME: Skagit County Superior Court Rooftop Jailhouse Removal OWNER NAME / ADDRESS: Skagit County, a Municipal Corporation 1800 Continental Place Mount Vernon, WA 98273 PROPERTY ADDRESS: 205 W. Kincaid Street Mount Vernon, WA 98273 PROPERTY MANAGER: Skagit County Facilities Management 1800 Continental Place Mount Vernon, WA 98273

	Cont	act: Ken Hansen	
NOTE: 1. DEIFS RECOMMENDS THAT GROUND	Mark	Description	Date
FLOOR APPLICATIONS AND ALL FACADES EXPOSED TO ABNORMAL STRESS, HIGH		CONSTRUCTION PLANS (REVISED)	03/20/23
TRAFFIC, OR DELIBERATE IMPACT HAVE TH BASE COAT REINFORCED WITH PANZER®	1E	BID SET ISSUE	04/24/23
MESH PRIOR TO STANDARD OR STANDARD X MESH. LOCATION OF HIGH IMPACT ZONE SHOULD BE INDICATED ON CONTRACT	c/1 \	PERMIT CORRECTION BID SET	06/21/23
DRAWINGS.		BID SET ISSUE	09/25/23
2. FOR INSTALLATION OF DEIFS			
AIR/WATER-RESISTIVE BARRIER COATING BENEATH CLADDINGS OTHER THAN DEIFS EIFS, REFER TO DEIFS PUBLICATION DS840			


CITY OF MOUNT VERNON PERMIT NUMBER BLDG23-0137

SHEET TITLE

**DEIFS WALL DETAILS** 


SCALE: NOTED ON DRAWINGS

**W203** 

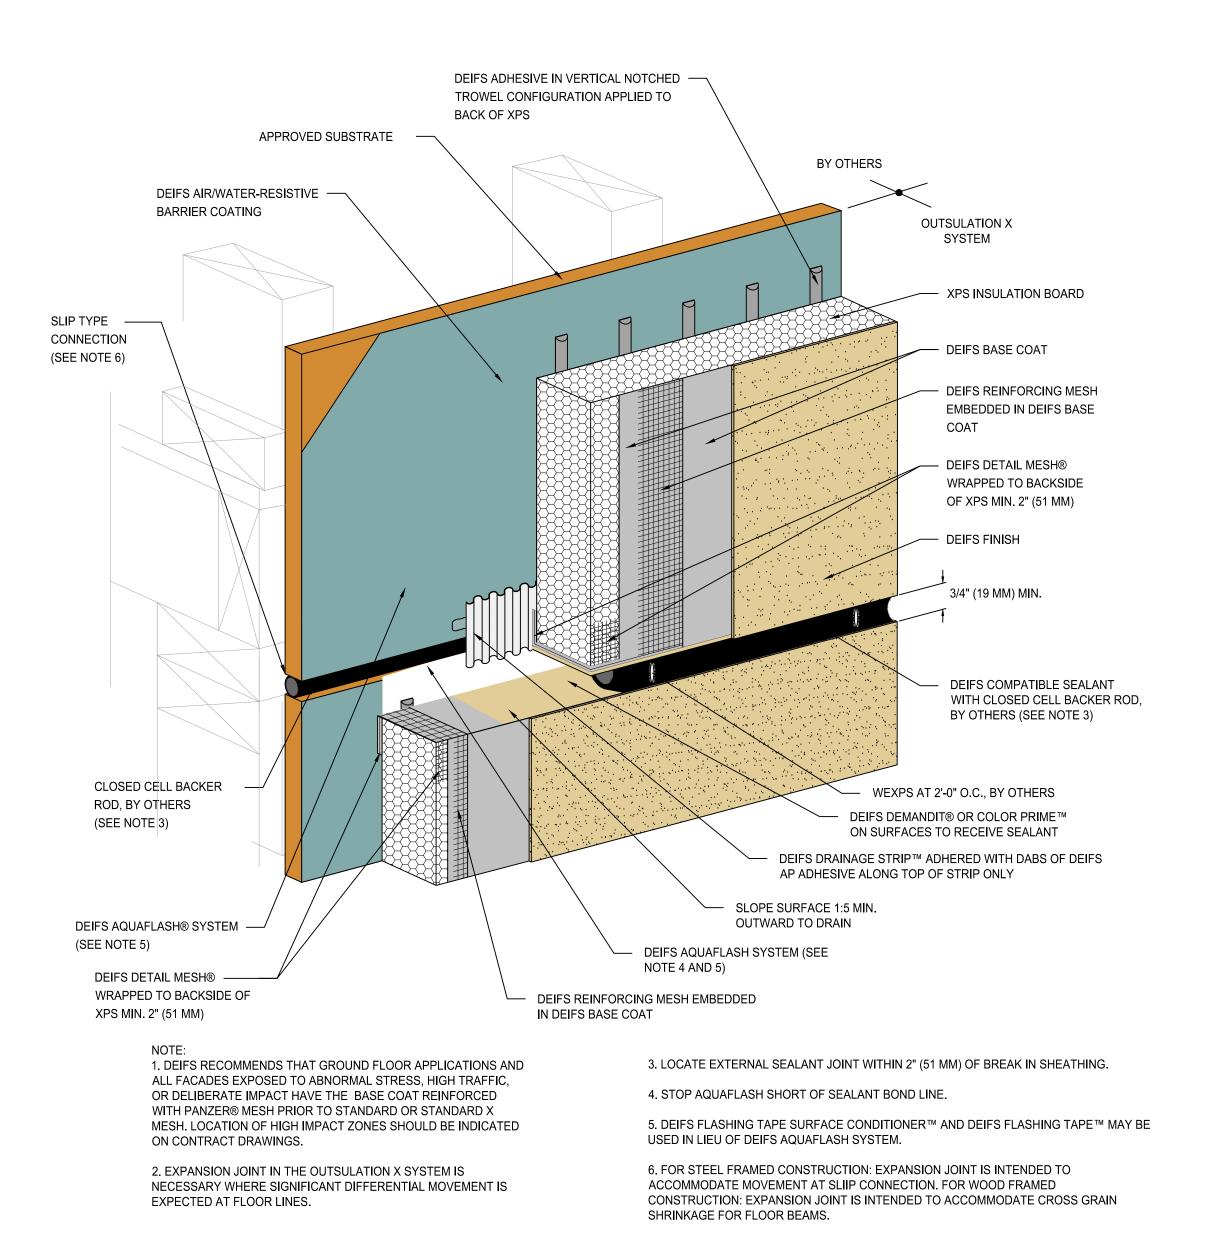

HORIZONTAL SLIP JOINT WITH WEXPS

W204 SCALE: NTS

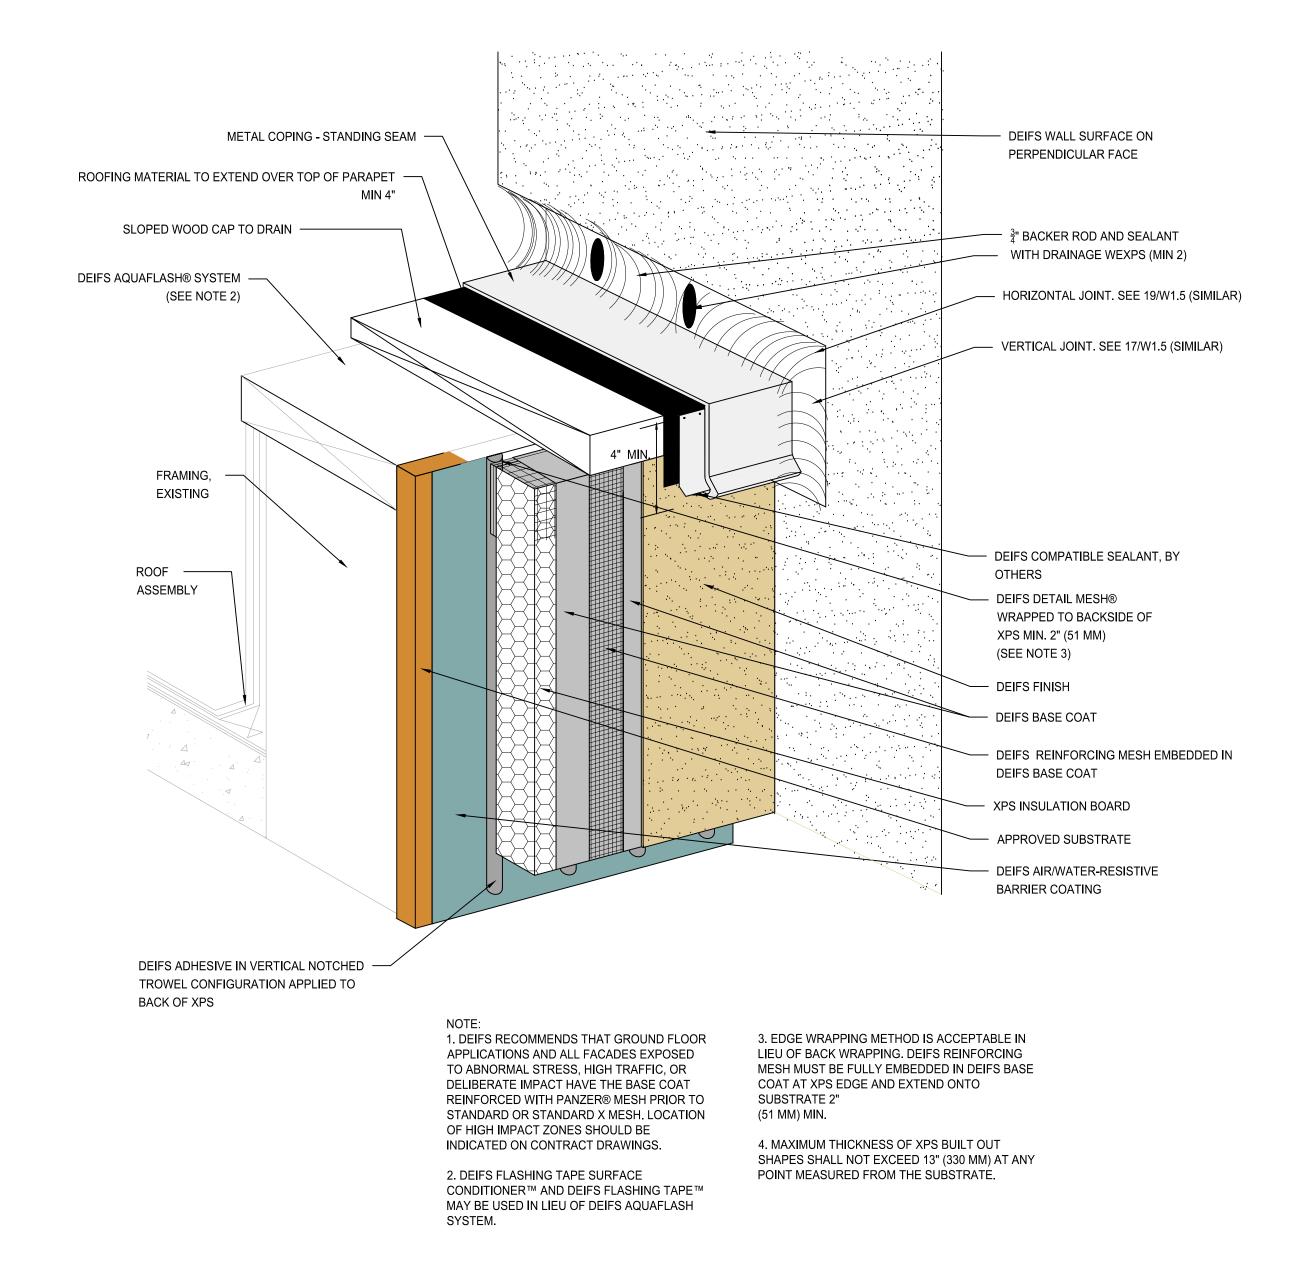

PARAPET COPING DETAIL INTERSECTION WITH PERPENDICULAR WALL

W204 SCALE: NTS

**W204** 

**DEIFS WALL** 

**DETAILS** 

SCALE: NOTED ON DRAWINGS

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Jest Land

ABB Project

# 22-7763.01

Skagit County Facilities

Project # 3809

Skagit County Superior Court

Rooftop Jailhouse Removal

OWNER NAME / ADDRESS:

a Municipal Corporation

1800 Continental Place Mount Vernon, WA 98273

PROPERTY ADDRESS:

205 W. Kincaid Street

PROPERTY MANAGER:

Skagit County Facilities

1800 Continental Place

Contact: Ken Hansen

\_\_∖BID SET

Mount Vernon, WA 98273

Description

(REVISED)

CONSTRUCTION PLANS 03/20/23

BID SET ISSUE 04/24/23

PERMIT CORRECTION 06/21/23

BID SET ISSUE 09/25/23

CITY OF MOUNT VERNON

PERMIT NUMBER

BLDG23-0137

Management

Mount Vernon, WA 98273

PROJECT NAME:

Skagit County,

SHEET

SHEET TITLE



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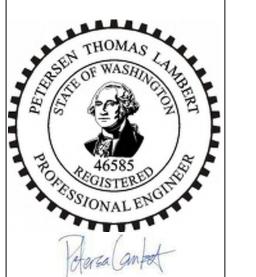


ABB Project # 22-7763.01 Skagit County Facilities Project # 3809

FRAMING

PER WAL⊾

TYPE

3/4" (19 MM) MIN.

2. EIFS EXPANSION JOINTS ARE REQUIRED IN

CONTINUOUS ELEVATIONS AT INTERVALS NOT

OUTSULATION X

DEIFS AIR/WATER-RESISTIVE

BARRIER COATING EXTENDED

DEIFS ADHESIVE IN VERTICAL

APPLIED TO BACK OF XPS

DEIFS REINFORCING MESH

DEIFS COMPATIBLE SEALANT

WITH CLOSED CELL BACKER

ROD, BY OTHERS

XPS INSULATION BOARD

DEIFS FINISH

BEHIND FLASHING (SEE NOTE 3)

NOTCHED TROWEL CONFIGURATION

PROJECT NAME: Skagit County Superior Court Rooftop Jailhouse Removal OWNER NAME / ADDRESS: Skagit County, a Municipal Corporation 1800 Continental Place Mount Vernon, WA 98273 PROPERTY ADDRESS: 205 W. Kincaid Street Mount Vernon, WA 98273 PROPERTY MANAGER: Skagit County Facilities Management 1800 Continental Place Mount Vernon, WA 98273 Contact: Ken Hansen

	EMBEDDED IN DEIFS BASE COAT	Mark	Description	Date
_	DEIFS DETAIL MESH® WRAPPED TO BACKSIDE OF		CONSTRUCTION PLANS (REVISED)	03/20/23
	XPS MIN. 2" (51 MM)		BID SET ISSUE	04/24/23
_	DEIFS BASE COAT	1	PERMIT CORRECTION BID SET	06/21/23
			BID SET ISSUE	09/25/23
_	DEIFS DEMANDIT® OR COLOR PRIME™ ON SURFACES TO RECEIVE			
	SEALANT			

CITY OF MOUNT VERNON PERMIT NUMBER BLDG23-0137

SHEET TITLE

**DEIFS WALL DETAILS** 

SCALE: NOTED ON DRAWINGS

**W205** 

SHEET

APPROVED SEALANT, BY — GC DEIFS ADHESIVE IN VERTICAL NOTCHED TROWEL CONFIGURATION APPLIED TO BACK OF XPS APPROVED SUBSTRATE DEIFS REINFORCING MESH EMBEDDED IN DEIFS BASE COAT DEIFS AIR/WATER-RESISTIVE BARRIER COATING DEIFS DRAINAGE STRIP™ SET IN DABS -DEIFS AQUAFLASH® SYSTEM (SEE NOTE 2) OF DEIFS AP ADHESIVE DEIFS BASE COAT -XPS INSULATION BOARD (19 MM) MIN. DEIFS DETAIL MESH® WRAPPED TO BACKSIDE OF XPS MIN. 2" (51 MM) ROOF FLASHING AND COUNTER FLASHING (203 MM) MIN. ROOF ASSEMBLY, — — DEIFS COMPATIBLE SEALANT DEIFS DEMANDIT® OR COLOR PRIME™ W/CLOSED CELL BACKER ROD ON SURFACE(S) TO RECEIVE SEALANT AND WEEP TUBES EVERY 24" (610 MM) BY GC

1. DEIFS RECOMMENDS THAT GROUND FLOOR 2. DEIFS FLASHING TAPE SURFACE APPLICATIONS AND ALL FACADES EXPOSED TO CONDITIONER™ AND DEIFS FLASHING TAPE™ ABNORMAL STRESS, HIGH TRAFFIC, OR DELIBERATE IMPACT HAVE THE BASE COAT SYSTEM. REINFORCED WITH PANZER® MESH PRIOR TO STANDARD OR STANDARD X MESH. LOCATION OF 3. EDGE WRAPPING METHOD IS ACCEPTABLE IN LIEU HIGH IMPACT ZONES SHOULD BE INDICATED ON OF BACK WRAPPING. DEIFS REINFORCING MESH CONTRACT DRAWINGS.

METAL CAP FLASHING, BY

DEIFS FINISH -

MAY BE USED IN LIEU OF DEIFS AQUAFLASH

MUST BE FULLY EMBEDDED IN DEIFS BASE COAT AT XPS EDGE AND EXTEND ONTO SUBSTRATE 2" (51 MM) MIN.

ROOF TO DEIFS WALL CONCEPT W205 / SCALE: NTS

IMPACT HAVE THE BASE COAT REINFORCED WITH PANZER® MESH PRIOR TO STANDARD OR STANDARD X MESH. LOCATION OF HIGH IMPACT ZONES SHOULD BE INDICATED ON CONTRACT DRAWINGS.

1. DEIFS RECOMMENDS THAT GROUND FLOOR

APPLICATIONS AND ALL FACADES EXPOSED TO


**VERTICAL EXPANSION JOINTS AT EIFS** 


ABNORMAL STRESS, HIGH TRAFFIC, OR DELIBERATE EXCEEDING 75 FT (23 M)


FRAMING PER WALL TYPE


APPROVED SUBSTRATE


W205 / SCALE: NTS

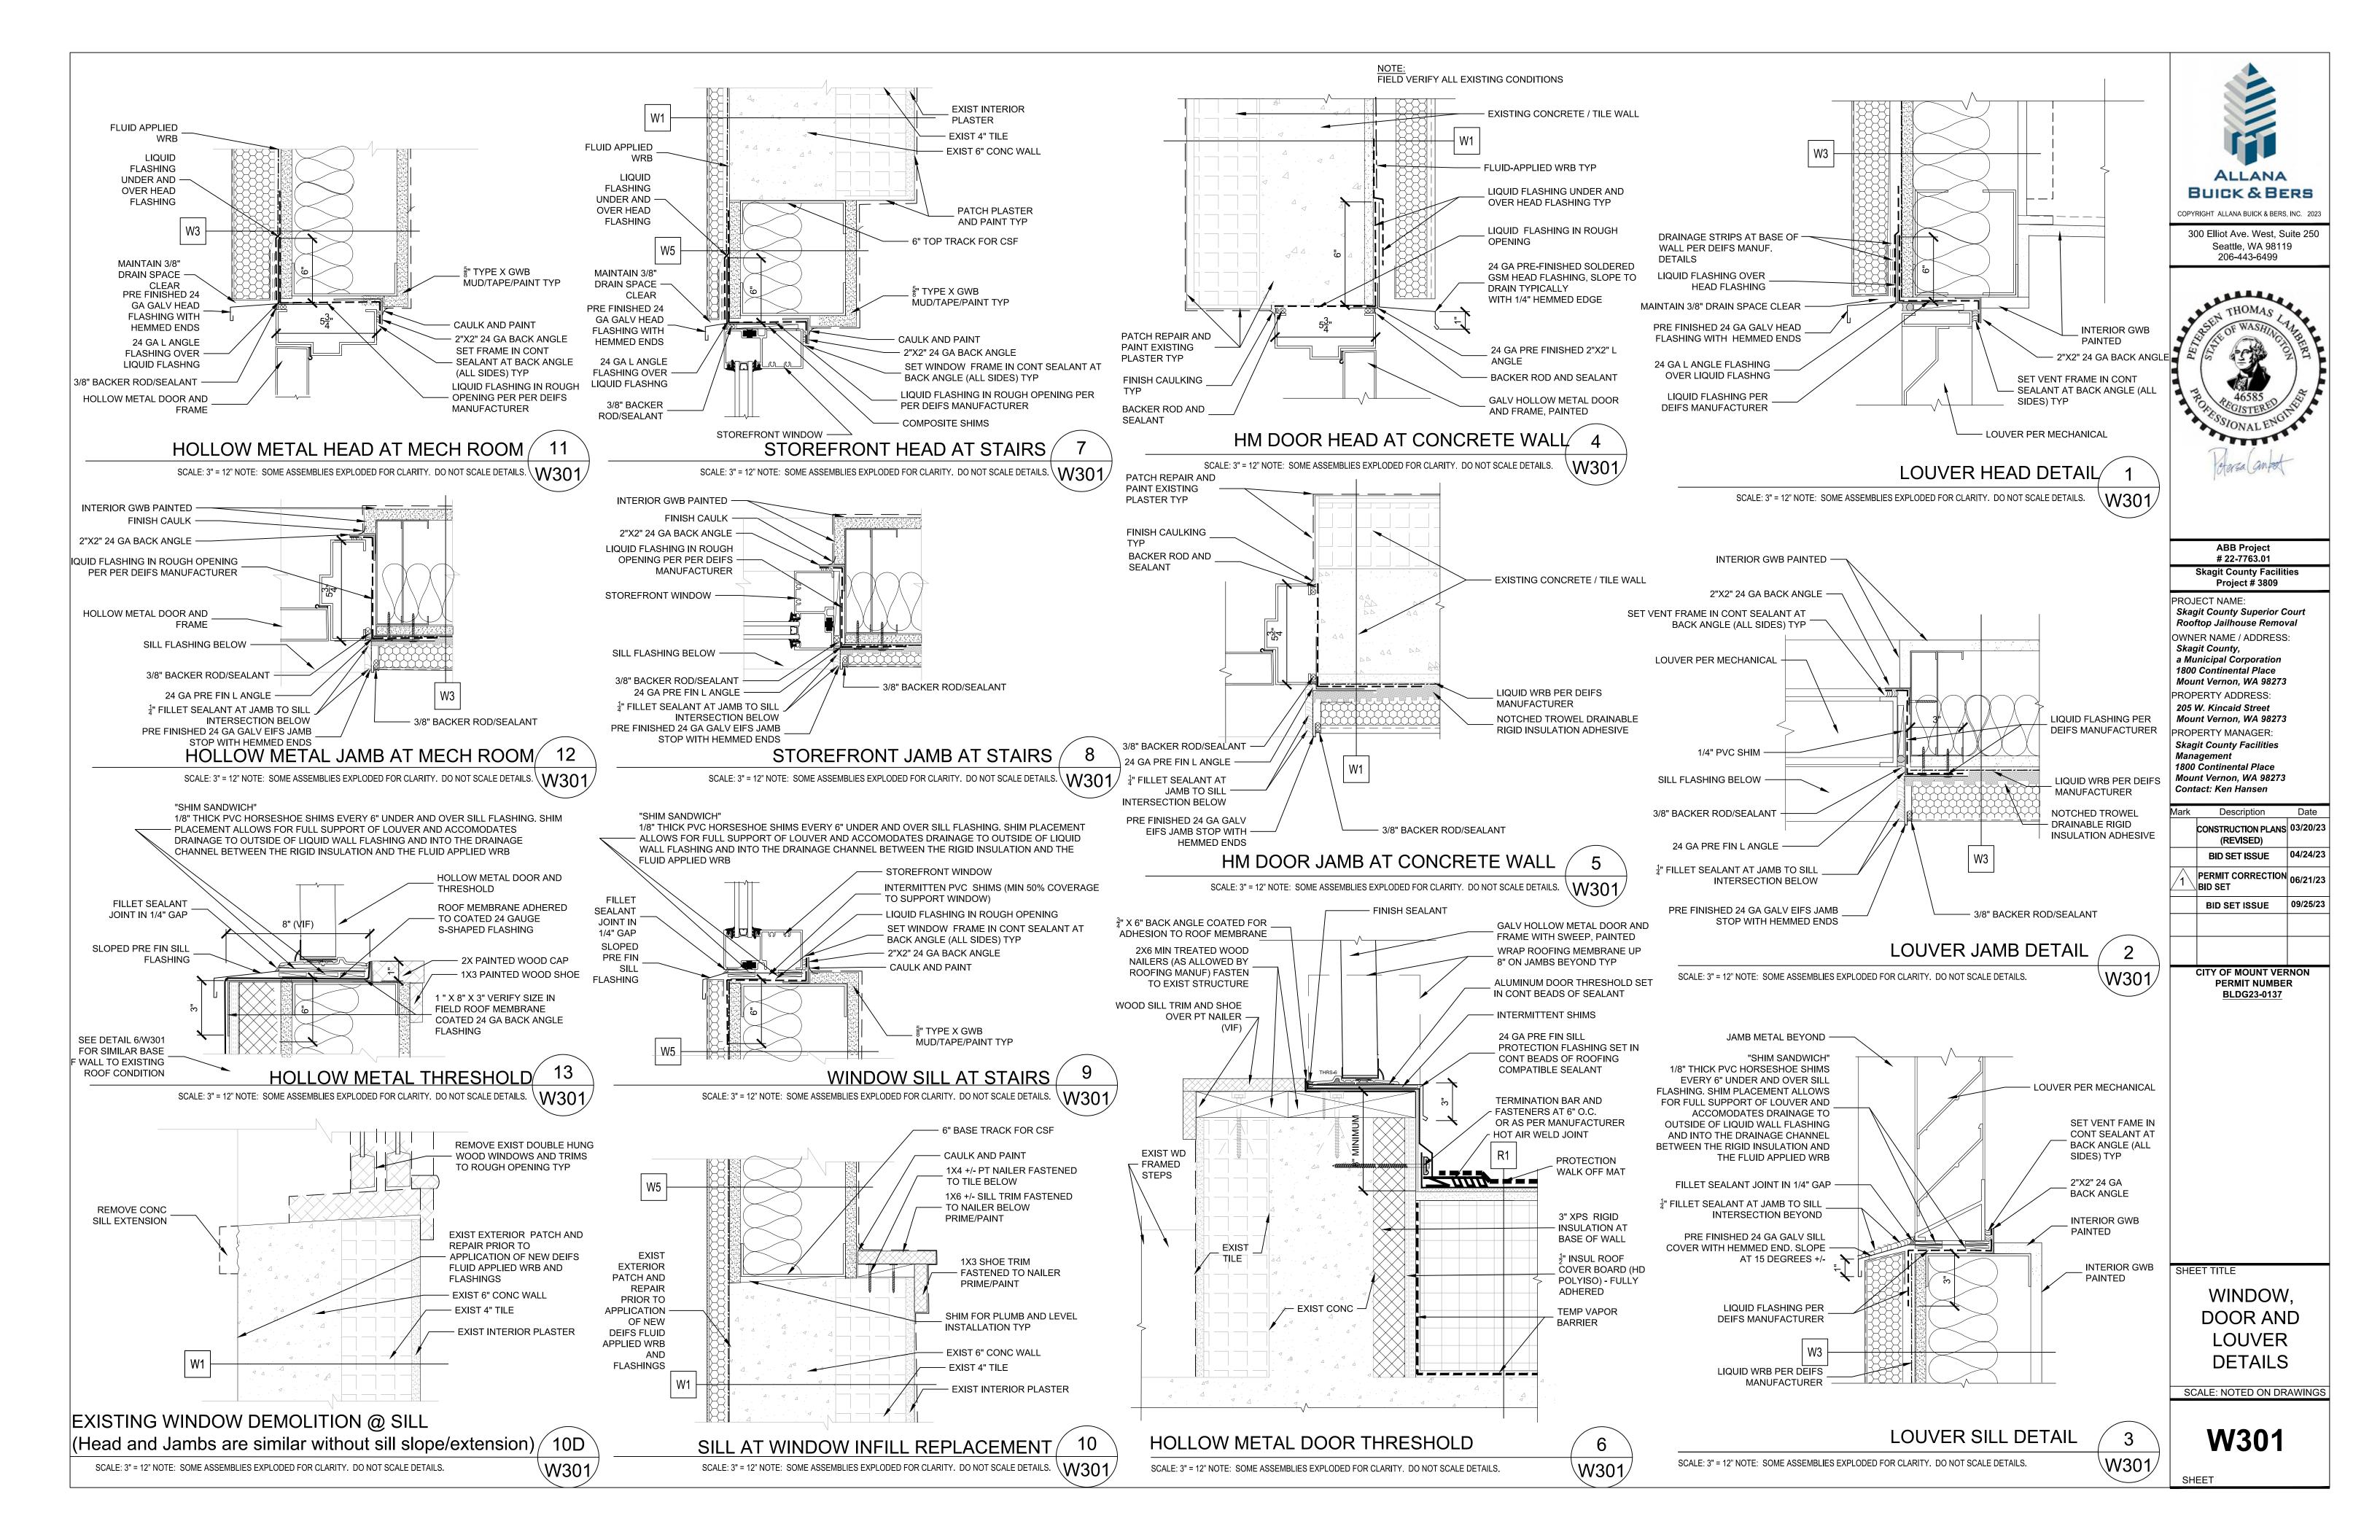

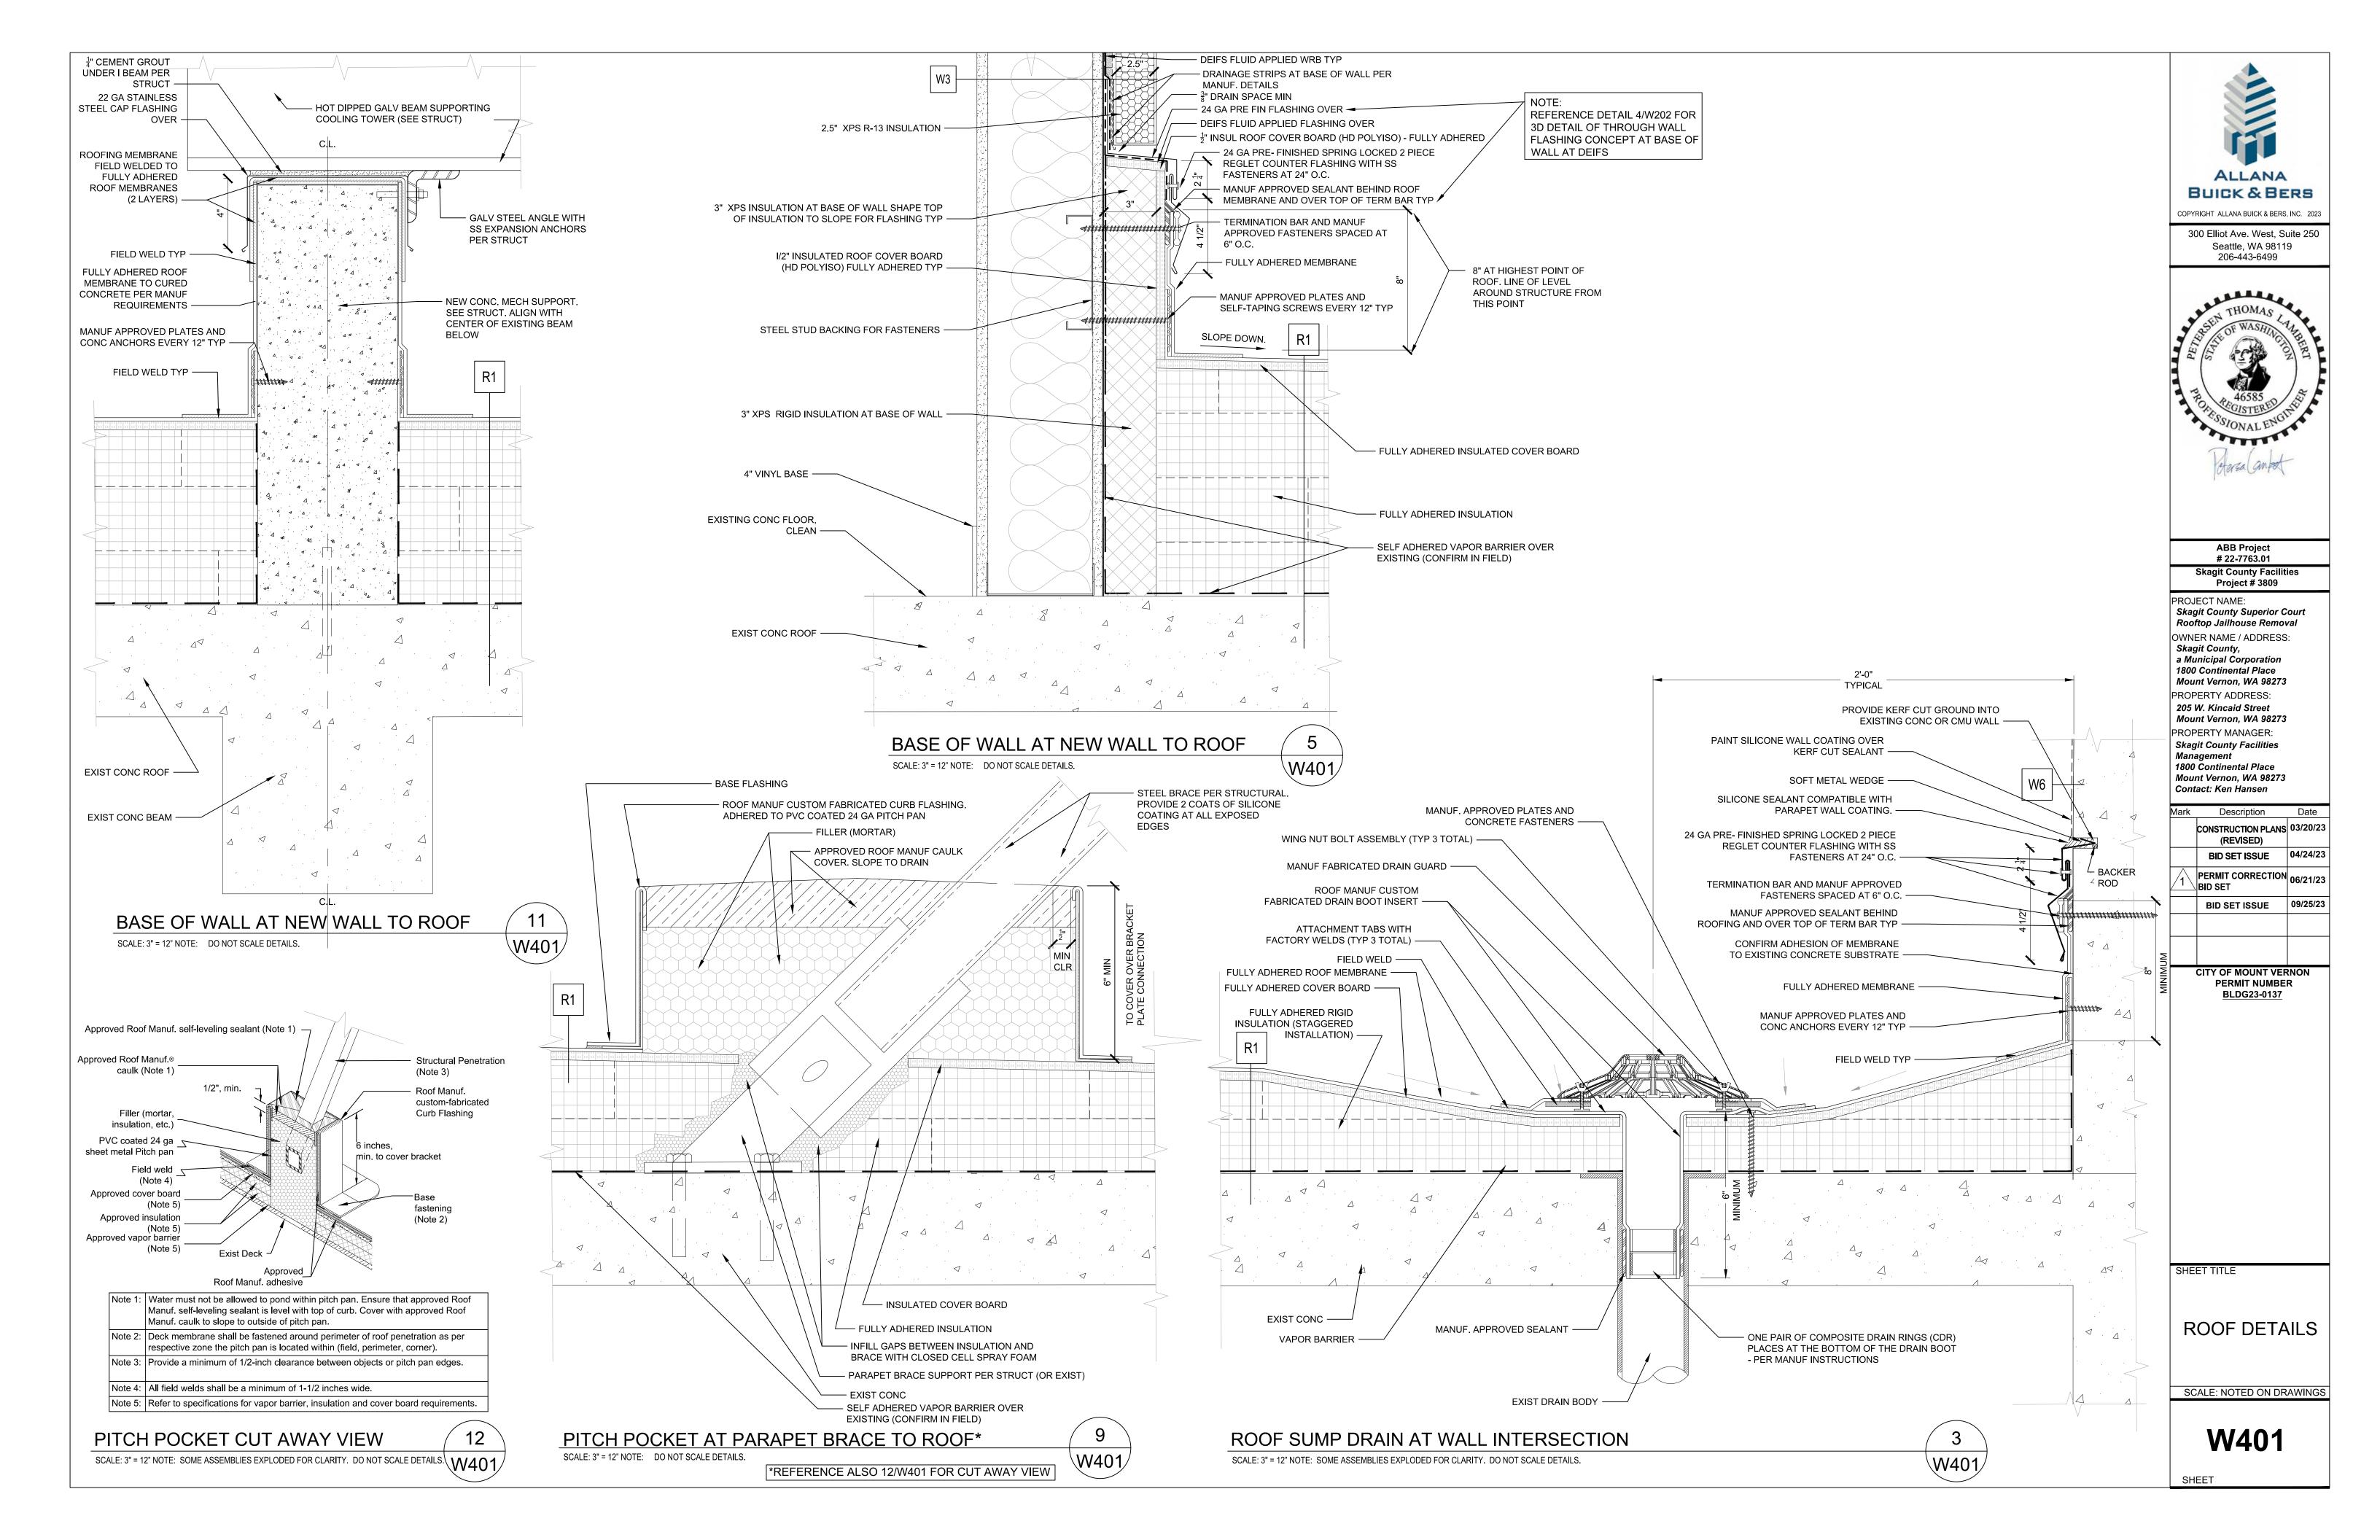


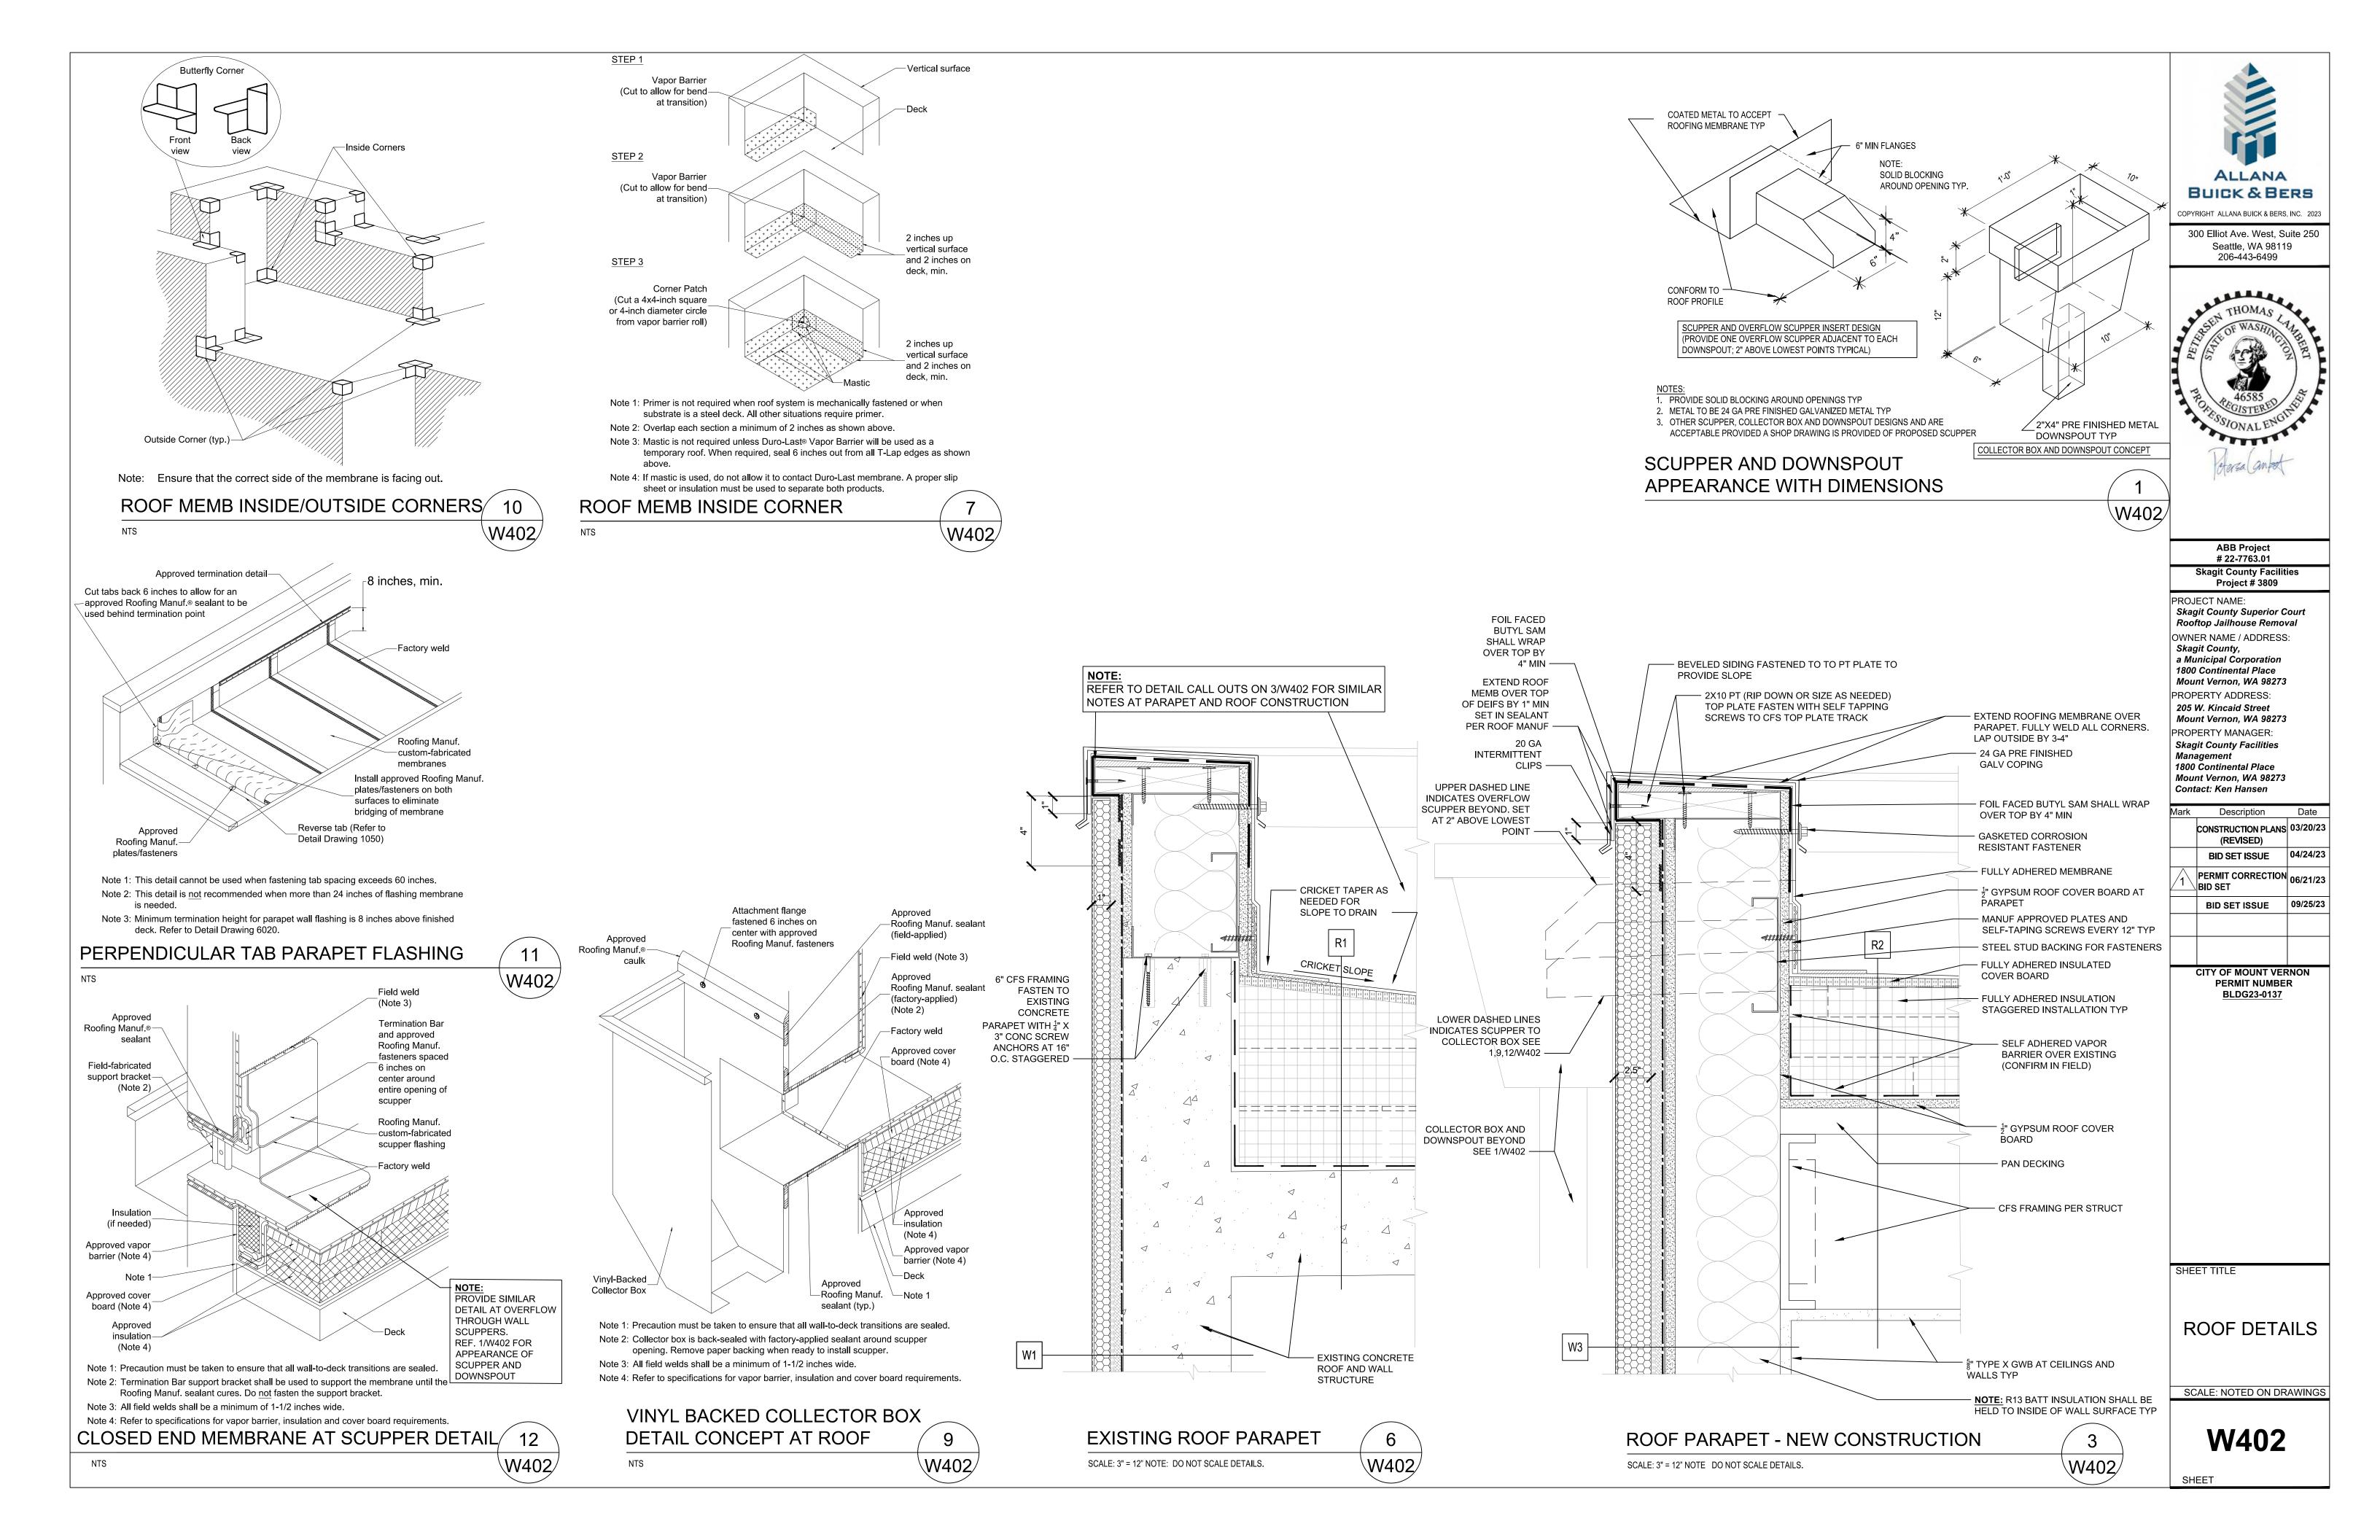

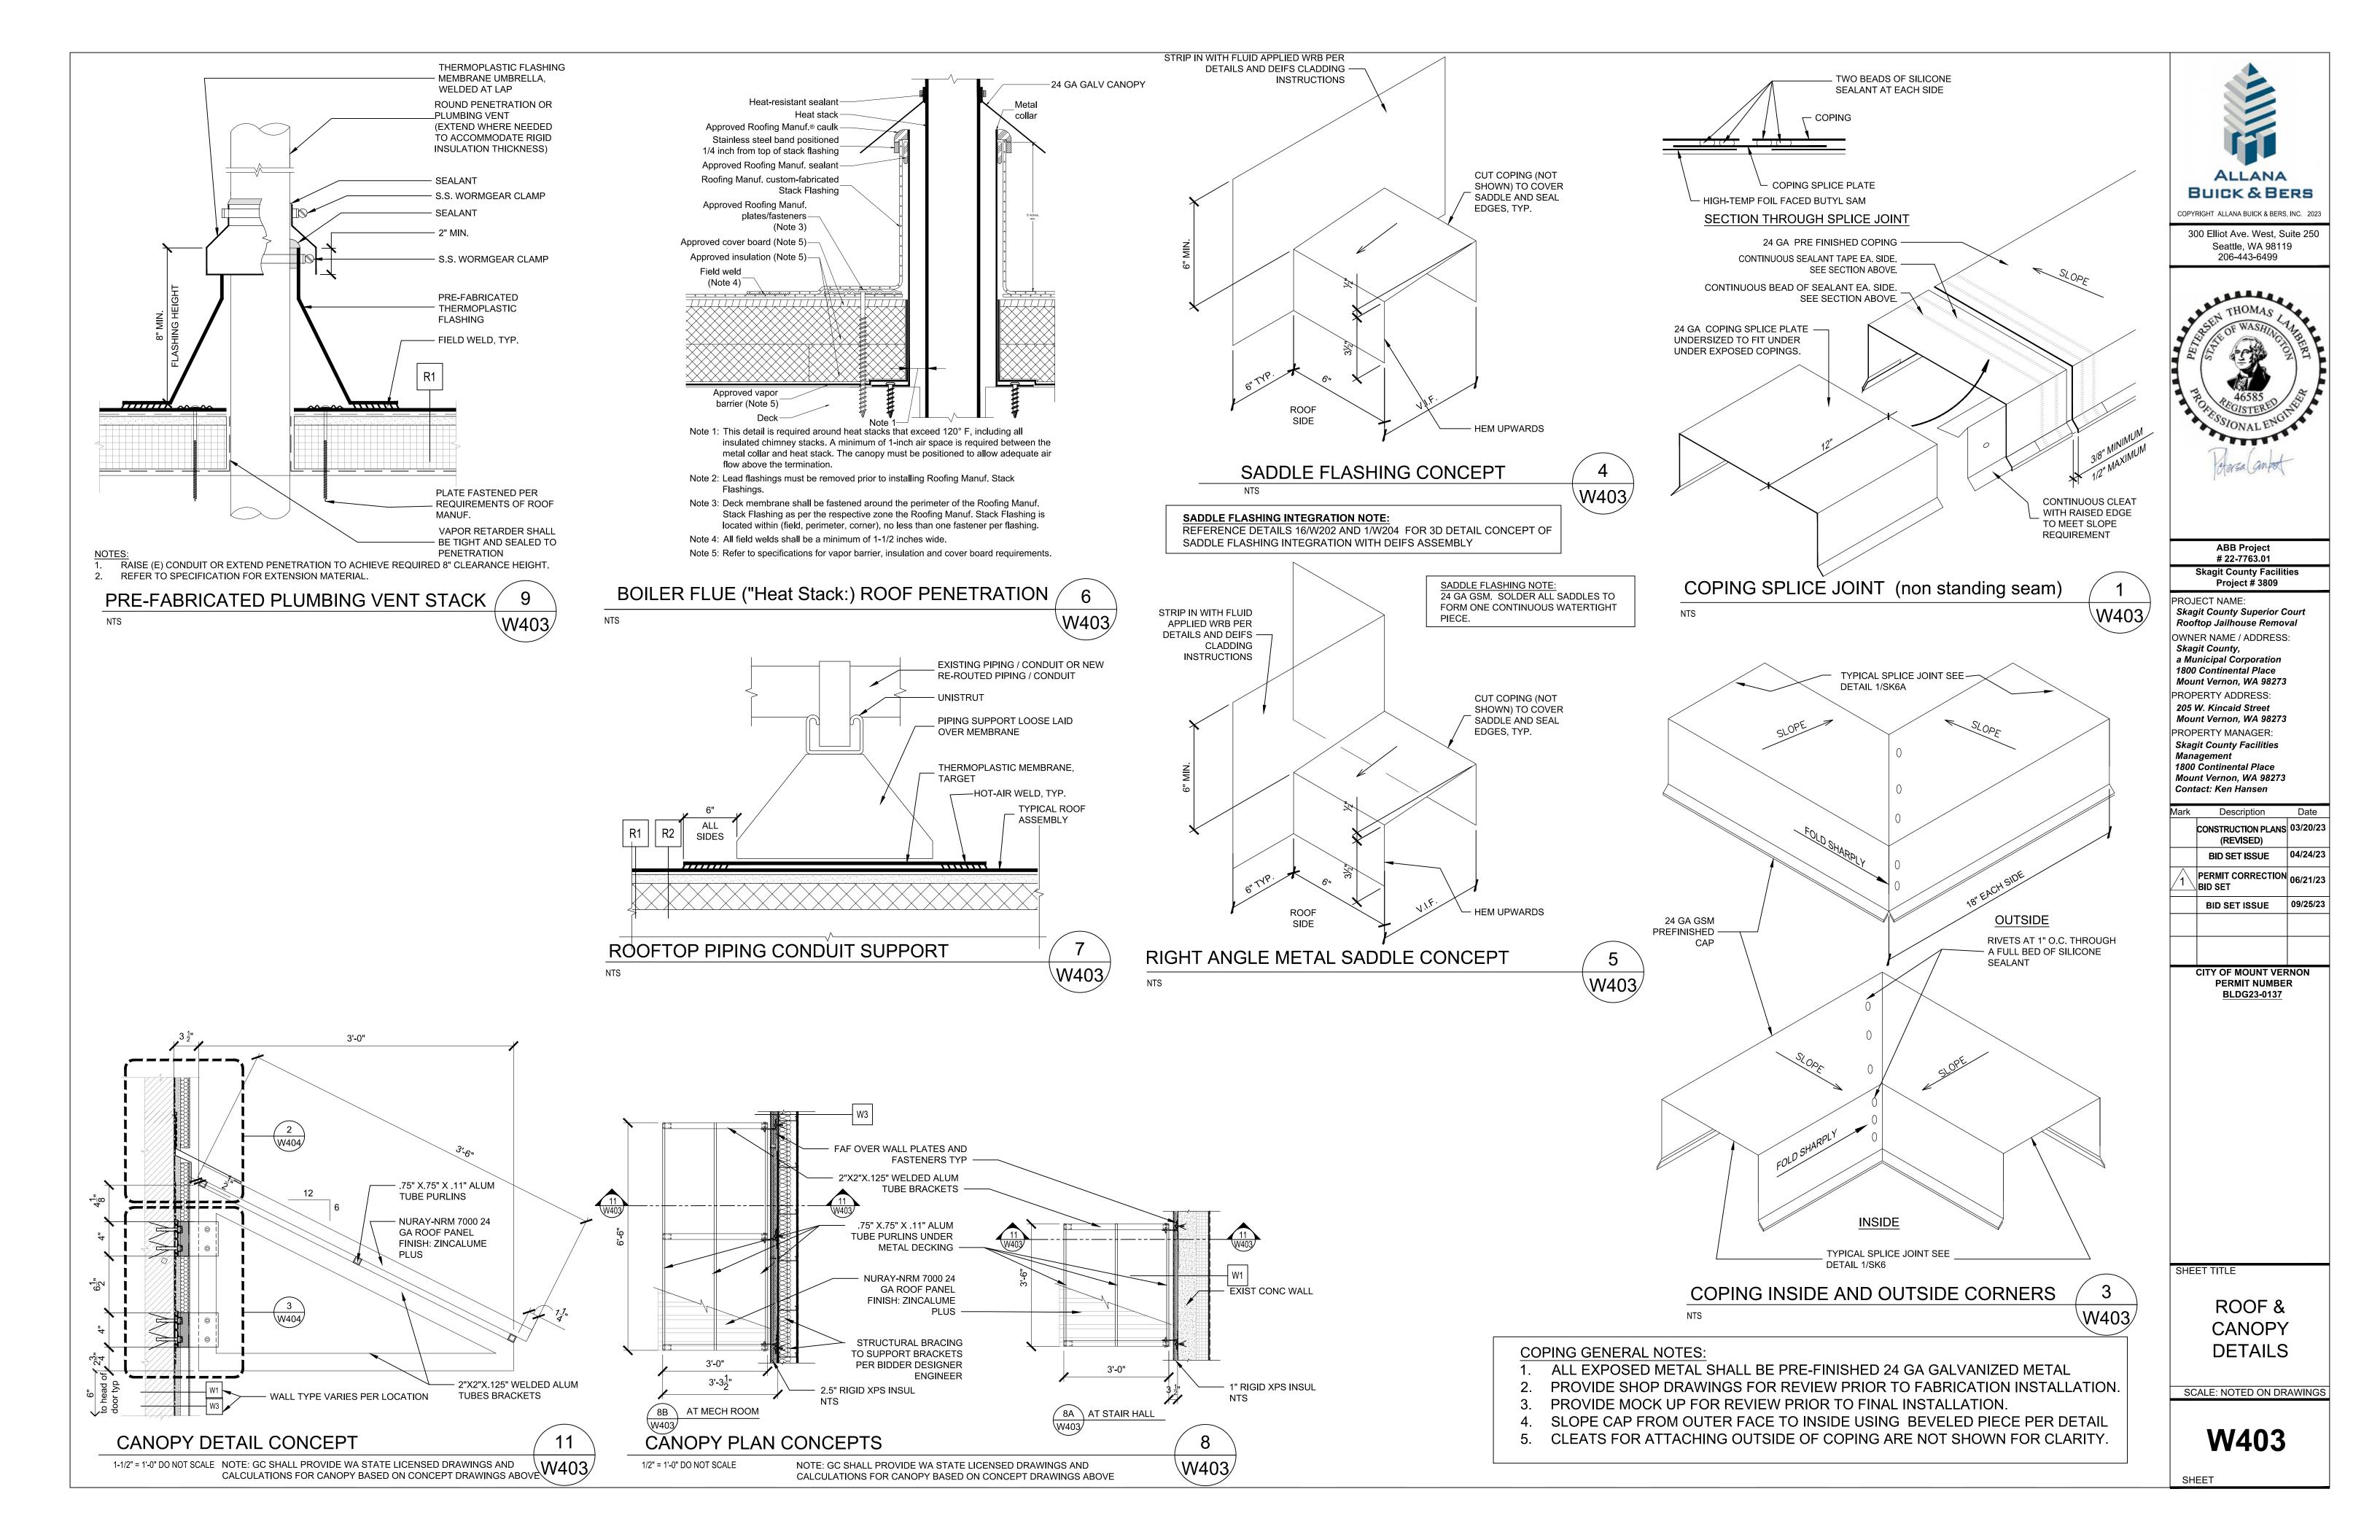

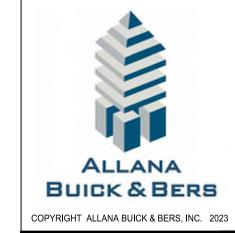

300 Elliot Ave. West, Suite 250 Seattle, WA 98119 206-443-6499

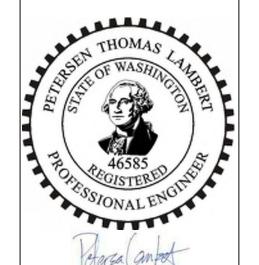

# ABB Project # 22-7763.01 Skagit County Facilities Project # 3809 PROJECT NAME:

Skagit County Superior Court
Rooftop Jailhouse Removal

OWNER NAME / ADDRESS:
Skagit County,
a Municipal Corporation
1800 Continental Place
Mount Vernon, WA 98273

PROPERTY ADDRESS:
205 W. Kincaid Street
Mount Vernon, WA 98273

PROPERTY MANAGER:
Skagit County Facilities
Management
1800 Continental Place
Mount Vernon, WA 98273

Contact: Ken Hansen

	Mark	Description	Date
		CONSTRUCTION PLANS (REVISED)	03/20/23
		BID SET ISSUE	04/24/23
	1	PERMIT CORRECTION BID SET	06/21/23
<b>4</b> /		BID SET ISSUE	09/25/23
•			

CITY OF MOUNT VERNON PERMIT NUMBER BLDG23-0137

SHEET TITLE


SHEET

W404

ROOF & CANOPY DETAILS


SCALE: NOTED ON DRAWINGS

W404

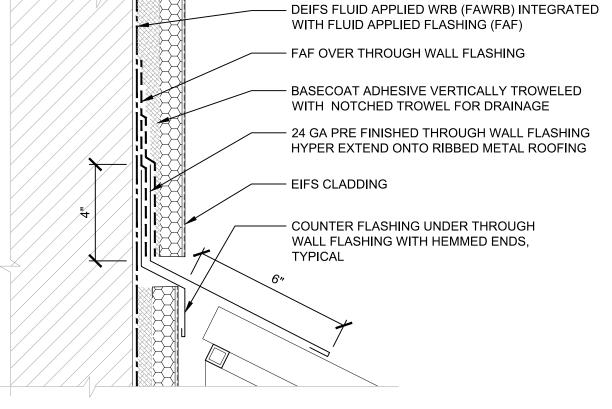

## WALL TO CANOPY HEAD DETAIL

3" = 1'-0" DO NOT SCALE

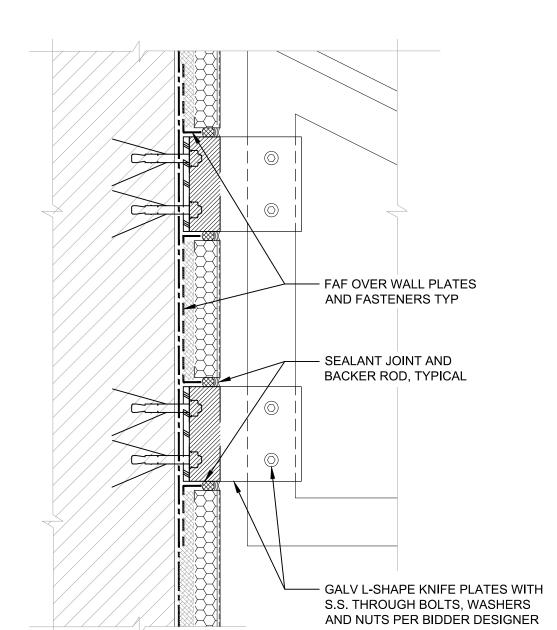

## KNIFEPLATE AT CANOPY

3" = 1'-0" DO NOT SCALE

#### STRUCTURAL SHEETS:

- SO GENERAL NOTES & DESIGN CRITERIA
- S1 PROPOSED ROOF LAYOUT S2 PARAPET BRACE DETAILS
- SZ PARAPET BRACE DETAILS
- S4 STRUCTURAL DETAILS
- S5 DEMO PLAN AND LOAD MAP

#### **GENERAL STRUCTURAL NOTES:**

- 1. THESE NOTES ARE GENERAL IN NATURE AND ARE INTENDED TO SET MINIMUM STANDARDS FOR CONSTRUCTION. THE CONTRACTOR SHALL BE COMPLETELY FAMILIAR WITH THE CONTRACT DOCUMENTS AND HAVE A COPY OF THEM ON SITE AT ALL TIMES.
- 2. FOR ANY PORTION OF THE CONSTRUCTION WHICH THE CONTRACTOR IS UNABLE TO ASCERTAIN THE REQUIRED CONSTRUCTION OR WHERE CONFLICTS EXIST, IT IS THE CONTRACTOR'S RESPONSIBILITY TO REQUEST ADDITIONAL INFORMATION (RFIs) AND/OR CLARIFICATIONS BEFORE CONSTRUCTION.
- 3. ALL WORK SHALL BE IN STRICT CONFORMANCE WITH THE 2021 INTERNATIONAL BUILDING CODE (IBC) WITH WASHINGTON AMENDMENTS & 2021 INTERNATIONAL EXISTING BUILDING CODE (IEBC). ALL BUILDING ELEMENTS AND COMPONENTS NOT SPECIFICALLY DETAILED IN THESE STRUCTURAL CONSTRUCTION DOCUMENTS SHALL BE FABRICATED AND CONSTRUCTED IN ACCORDANCE WITH THE MINIMUM STANDARDS CONTAINED IN THE IBC & IEBC.
- 4. THE CONTRACTOR SHALL VERIFY ALL DIMENSIONS AND ELEVATIONS BEFORE CONSTRUCTION. THE ARCHITECT AND ENGINEER SHALL BE NOTIFIED OF ANY DISCREPANCIES OR INCONSISTENCIES.
- 5. THE CONTRACTOR, SUBCONTRACTORS AND SUPPLIERS SHALL ENSURE COORDINATION OF CONTRACTOR SUPPLIED/DESIGNED ELEMENTS AND DEFERRED SUBMITTALS WITH ALL DESIGN DISCIPLINES WITHIN THE CONSTRUCTION SET. COORDINATION SHALL IDENTIFY AND RECONCILE CONFLICTS BETWEEN THE CONTRACTOR SUPPLIED/DESIGNED ELEMENTS AND THE CONSTRUCTION DRAWINGS PRIOR TO FABRICATION AND DELIVERY TO THE PROJECT SITE. THE PROJECT ENGINEER SHALL BE NOTIFIED IF CONFLICTS EXIST.
- 6. THE CONTRACT STRUCTURAL DRAWINGS REPRESENT THE FINISHED STRUCTURE. METHODS, PROCEDURES, AND SEQUENCE OF CONSTRUCTION ARE THE RESPONSIBILITY OF THE CONTRACTOR. THE CONTRACTOR SHALL TAKE ALL NECESSARY PRECAUTIONS TO MAINTAIN AND ENSURE THE INTEGRITY OF THE STRUCTURE AT ALL STAGES OF CONSTRUCTION.
- 7. CONSTRUCTION LOADS SHALL NOT EXCEED THE DESIGN LIVE LOAD FOR THE STRUCTURE. PROVIDE SHORING AND/OR BRACING WHERE LOADS EXCEED DESIGN CAPACITY AND WHERE STRUCTURES HAVE NOT ATTAINED DESIGN STRENGTH.
- 8. CLADDING, WATERPROOFING, AND ARCHITECTURAL FEATURES ARE OUTSIDE THE STRUCTURAL SCOPE OF WORK. ANY DEPICTION OF SUCH FEATURES ON THE STRUCTURAL DRAWINGS ARE NOT INTENDED TO BE USED FOR CONSTRUCTION. REPRESENTATION OF SUCH FEATURES ON THESE DRAWINGS MAY OR MAY NOT BE ACCURATE. REFER TO ARCHITECTURAL DRAWINGS AND/OR SPECIFICATIONS.

#### <u>DESIGN LOADS:</u> PER 2021 IBC WITH WASHINGTON AMENDMENTS & 2021 IEBC

1603.1.2 — ROOF LOADS: DEAD LOADLIVE LOAD	10 PSF SEE SNOW LOADS
SNOW EXPOSURE FACTOR, Ce	25 PSF 1.0 1.2, CATEGORY IV 1.0 40 PSF
1603.1.4 — WIND DESIGN CRITERIA:  ULTIMATE DESIGN WIND SPEED, Vult  RISK CATEGORY  WIND EXPOSURE	109 MPH IV EXPOSURE C
$ \begin{array}{llllllllllllllllllllllllllllllllllll$	IV 1.50 1.106 g 0.394 g D (DEFAULT) 0.885 g 0.501 g CATEGORY D BRACED PARAPET LIGHT FRAMED WALLS SHEATHED W/STEEL SHEETS 2.5 6.5

#### STRUCTURAL STEEL:

1. STRUCTURAL STEEL SHALL CONFORM TO THE FOLLOWING GRADES, UNLESS NOTED OTHERWISE ON THE PLANS:

SHAPE	ASTM DESIGNATION	YIELD STRESS (Fy)
PLATES & BARS	ASTM A36	36 ksi
W-SECTIONS	ASTM A992	50 ksi
CHANNELS & ANGLES	ASTM A36	36 ksi
HSS (RECTANGULAR)	ASTM A500, GRADE C	50 KSI
HSS (ROUND)	ASTM A500, GRADE C	46 KSI

- 2. WELD ACCORDING TO CURRENT AWS STANDARDS WITH E70XX ELECTRODES
- 3. WELD SIZES SHOWN ON THE DESIGN DRAWINGS ARE CONSIDERED EFFECTIVE WELD SIZES AND SHALL BE INCREASED IN ACCORDANCE WITH AWS AS REQUIRED BY GAPS OR SKEWS BETWEEN COMPONENTS.
- 4. ALL STEEL EXPOSED TO WEATHER SHALL BE HOT-DIP GALVANIZED, UNLESS NOTED OTHERWISE.
- 5. ALL STRUCTURAL CONNECTION BOLTS SHALL BE ASTM F3125 GRADE A325, UNLESS NOTED OTHERWISE. HOOKED, HEADED, THREADED, AND NUTTED ANCHOR RODS SHALL BE ASTM F1554 (Fy = 36 ksi), UNLESS NOTED OTHERWISE.
- 6. CONTACT BETWEEN DISSIMILAR METALS SHALL BE ISOLATED USING PHENOLIC OR OTHERWISE APPROVED ISOLATION HARDWARE

#### COLD FORM STEEL FRAMING:

- 1. ALL PRODUCTS SHALL BE MANUFACTURED BY THE CURRENT MEMBERS OF THE STEEL STUD MANUFACTURERS ASSOCIATION
- 2. ALL GALVANIZED STUDS AND JOISTS SHALL BE FORMED FROM STEEL THAT CORRESPONDS TO THE MINIMUM REQUIREMENTS OF THE CURRENT A.I.S.I. STANDARDS
- 3. ALL STRUCTURAL MEMBERS SHALL BE DESIGNED IN ACCORDANCE WITH THE AMERICAN IRON AND STEEL INSTITUTE (AISI) "SPECIFICATION FOR THE DESIGN OF COLD-FORMED STEEL STRUCTURAL MEMBERS, CURRENT EDITION.
- 4. PROVIDE ALL ACCESSORIES INCLUDING, BUT NOT LIMITED TO, TRACKS, CLIPS, WEB STIFFENERS, ANCHORS, FASTENING DEVICES, RESILIENT CLIPS, AND OTHER ACCESSORIES REQUIRED FOR A COMPLETE AND PROPER INSTALLATION, AND AS RECOMMENDED BY THE MANUFACTURER FOR THE STEEL MEMBERS USED.
- 5. FASTENING OF COMPONENTS SHALL BE WITH SELF-DRILLING SCREWS OR WELDING. SCREWS OR WELDS SHALL BE OF SUFFICIENT SIZE TO ENSURE THE STRENGTH OF THE CONNECTION. ALL WELDS OF GALVANIZED STEEL SHALL BE TOUCHED UP WITH A ZINC-RICH PAINT. ALL WELDS OF CARBON SHEET STEEL SHALL BE TOUCHED UP WITH PAINT. WIRE TYING OF COMPONENTS SHALL NOT BE PERMITTED.

#### PREMANUFACTURED CONNECTION HARDWARE:

- 1. CONNECTION HARDWARE IS BY THE SIMPSON COMPANY OF SAN LEANDRO, CA. ALL STEEL CONNECTORS SHALL BE GALVANIZED OR BY SOME METHOD MADE CORROSION RESISTANT, UNLESS OTHERWISE INDICATED.
- 2. PROVIDE BOLTED OR NAILED CONNECTIONS FOR THE MAXIMUM CAPACITY UNLESS NOTED OTHERWISE.
- 3. CONNECTORS IN CONTACT WITH PRESSURE TREATED WOOD SHALL BE EITHER POST HOT—DIP GALVANIZED OR STAINLESS STEEL. FASTENERS SHALL BE OF THE SAME MATERIAL OR PROTECTIVE COATING AS THE CONNECTORS, DO NOT MIX DIFFERING METALS IN THE SAME CONNECTION.
- 4. ALL HARDWARE SHALL BE INSTALLED PER MANUFACTURER'S INSTRUCTIONS AND RECOMMENDATIONS, UNLESS NOTED OTHERWISE.

#### CONCRETE:

- 1. ALL CONCRETE SHALL BE HARD ROCK CONCRETE MEETING REQUIREMENTS OF ACI-301, "SPECIFICATIONS FOR STRUCTURAL CONCRETE FOR BUILDINGS". MIX PROPORTIONS SHALL BE PER ACI-301, METHOD 2 OR THE ALTERNATE PROCEDURE. SUBMIT MIX DESIGN FOR REVIEW BY STRUCTURAL ENGINEER FOR APPROVAL PRIOR TO CONSTRUCTION.
- 2. STRUCTURAL CONCRETE SHALL ATTAIN THE FOLLOWING MINIMUM COMPRESSIVE STRENGTH AT 28 DAYS:

TYPE	f'c	SLUMP	w/c	AIR
WALLS	4 500 nsi	1_4"	0.45	6%

- 3. ALL CONCRETE EXPOSED TO WEATHER SHALL CONTAIN 6% ( $\pm$ ) 1% AIR ENTRAINMENT BY VOLUME. AIR ENTRAINMENT SHALL BE IN CONFORMANCE WITH ASTM C260.
- 4. COLD WEATHER PLACEMENT SHALL CONFORM TO ACI-306. HOT WEATHER PLACEMENT SHALL CONFORM TO ACI-305. MECHANICALLY VIBRATE ALL FORMED CONCRETE. DO NOT OVER-VIBRATE. PLACE CONCRETE MONOLITHICALLY BETWEEN CONSTRUCTION OR CONTROL JOINTS. PROTECT ALL CONCRETE FROM PREMATURE DRYING.
- 5. CHAMFER ALL EXTERIOR CORNERS 1/2" UNLESS SHOWN OTHERWISE.
- 6. SLUMP LIMITS MAY BE INCREASED BY ADDITION OF ADMIXTURES PROVIDED THAT THE WATER/CEMENT RATIO OF THE ORIGINAL MIX DESIGN IS NOT EXCEEDED. WATER REDUCING ADMIXTURE SHALL BE IN CONFORMANCE WITH ASTM494, USED IN CONFORMANCE WITH MANUFACTURER'S INSTRUCTIONS. SUBMIT ADMIXTURES TO ENGINEER FOR REVIEW PRIOR TO CONSTRUCTION.
- 7. CEMENT SHALL BE TYPE I OR II IN CONFORMANCE WITH ASTM C150. AGGREGATES SHALL BE IN CONFORMANCE WITH ASTM C33 AND USE CRUSHED (NOT ROUND) GRAVEL OR STONE. COARSE AGGREGATES SHALL NOT EXCEED 3/4". WATER SHALL BE CLEAN AND POTABLE.
- 8. REINFORCING STEEL SHALL CONFORM TO ASTM A615, GRADE 60. GRADE 40 MAY BE USED FOR #3 AND SMALLER TIES AND STIRRUPS. DETAIL AND PLACE ACCORDING TO ACI MANUAL SP-66. BENDING OF REINFORCING STEEL IN THE FIELD IS NOT PERMITTED WITHOUT APPROVAL BY EOR. REBENDING OR STRAIGHTENING OF REINFORCING OR BENDING OF REINFORCING STEEL CAST INTO CONCRETE IS NOT ALLOWED.
- 9. UNLESS OTHERWISE NOTED, MINIMUM COVER SHALL BE 1 1/2" FOR #5 AND SMALLER BARS, 2" FOR #6 AND LARGER BARS AND 3" WHEN POURED AGAINST EARTH. SUPPORT REINFORCEMENT WITH APPROVED CHAIRS, SPACERS, OR TIES.
- 10. PROVIDE MINIMUM 48 BAR DIAMETERS AT SPLICES. NO MORE THAN 50% OF REINFORCING SHALL BE SPLICED AT ANY LOCATION. UNLESS OTHERWISE NOTED, BEND ALL HORIZONTAL REINFORCING A MINIMUM OF 2'-0" AT CORNERS AND WALL/FOOTING INTERSECTIONS WITH MIN. EMBEDMENT BEYOND INTERFACE PER DEVELOPMENT LENGTH SPECIFIED IN ACI 318
- 11. FORMWORK SHALL BE IN ACCORDANCE WITH ACI-347 "GUIDE TO FORMWORK FOR CONCRETE". FORMS SHALL BE DESIGNED BY THE CONTRACTOR. BRACING SHALL BE PROVIDED AS REQUIRED OR UNTIL THE CONCRETE HAS REACHED ITS SPECIFIED 28-DAY STRENGTH. ALL SHORING SHALL BE THE RESPONSIBILITY OF THE CONTRACTOR. FORMWORK, SUPPORTS, AND SHORING SHALL PROVIDE FINISHED CONCRETE SURFACES AT ALL FACES: LEVEL, PLUMB, AND TRUE TO DIMENSIONS AND ELEVATIONS SHOWN IN THE DRAWINGS.

#### POST-INSTALLED CONCRETE ANCHORS:

#### 1. ADHESIVE:

- 1.1. ADHESIVE ANCHORS SHALL BE INSTALLED BY QUALIFIED PERSONNEL TRAINED TO INSTALL ADHESIVE ANCHORS IN ACCORDANCE WITH THE CONTRACT DOCUMENTS AND WITH STRICT ADHERENCE TO THE PROVISIONS WITHIN THE MANUFACTURER'S PRINTED INSTALLATION INSTRUCTIONS.
- 1.2. AT THE TIME OF ANCHOR INSTALLATION, IN ACCORDANCE WITH ACI 318—19 SECTION 17.1.2, ADHESIVE ANCHORS SHALL BE INSTALLED IN CONCRETE HAVING A MINIMUM AGE OF 21 DAYS.
- 1.3. WHERE THE AUTHORITY HAVING JURISDICTION OVER THIS PROJECT REQUIRES ADHERENCE TO ACI 318-19 SECTION 17.8.2.2, INSTALLATION OF ADHESIVE ANCHORS IN HORIZONTAL TO VERTICALLY OVERHEAD ORIENTATION SHALL BE DONE BY A CERTIFIED ADHESIVE ANCHOR INSTALLER (AAI) AS CERTIFIED THROUGH ACI AND IN ACCORDANCE WITH ACI 318-19 SECTION 17.8.2.2. PROOF OF CURRENT CERTIFICATION SHALL BE SUBMITTED TO THE ENGINEER FOR APPROVAL PRIOR TO COMMENCEMENT OF INSTALLATION. NOTE: THE STATE OF OREGON DOES NOT REQUIRE ADHERENCE TO ACI 318-19 SECTION 17.8.2.2.

#### 2. MECHANICAL:

MECHANICAL ANCHORS SHALL BE INSTALLED BY QUALIFIED PERSONNEL TRAINED TO INSTALL MECHANICAL ANCHORS IN ACCORDANCE WITH THE CONTRACT DOCUMENTS AND WITH STRICT ADHERENCE TO THE PROVISIONS WITHIN THE MANUFACTURER'S PRINTED INSTALLATION INSTRUCTIONS.

#### SHEATHING:

- 1. MINIMUM PANEL THICKNESS SHALL BE 34" OF SURE-BOARD SERIES 200.
- 2. INSTALLATION OF THE PANEL SHALL BE PERFORMED PER IAPMO ES ER-0126
- 3. BLOCK PANEL EDGES WITH 2"X43 MIL FLAT STRAP. ATTACH TO THE INTERMEDIATE SUPPORTS WITH #8 SCREWS @ 12" O.C.

#### STRUCTURAL OBSERVATION REQUIREMENTS:

- 1. THE OWNER SHALL EMPLOY THE ENGINEER OF RECORD OR AN ALTERNATE OREGON LICENSED PROFESSIONAL ENGINEER, APPROVED BY THE ENGINEER OF RECORD, TO PERFORM STRUCTURAL OBSERVATIONS IN ACCORDANCE WITH SECTION 1704.6 OF THE INTERNATIONAL BUILDING CODE.
- 2. STRUCTURAL OBSERVATION IS THE VISUAL OBSERVATION OF THE STRUCTURAL SYSTEM BY A REGISTERED DESIGN PROFESSIONAL FOR GENERAL CONFORMANCE TO THE APPROVED CONSTRUCTION DOCUMENTS AT SIGNIFICANT CONSTRUCTION STAGES AND AT COMPLETION OF THE STRUCTURAL SYSTEM. STRUCTURAL OBSERVATION DOES NOT INCLUDE OR WAIVE THE RESPONSIBILITY FOR ANY OTHER INSPECTION CRITERIA, INCLUDING SPECIAL INSPECTION, AS REQUIRED BY THE BUILDING OFFICIAL OR AS INDICATED WITHIN THE INTERNATIONAL BUILDING CODE.
- 3. DEFICIENCIES SHALL BE REPORTED IN WRITING TO THE OWNER AND THE BUILDING OFFICIAL (AND THE ENGINEER OF RECORD IF AN ALTERNATE ENGINEER IS USED FOR STRUCTURAL OBSERVATION). AT THE CONCLUSION OF THE STRUCTURAL WORK INCLUDED WITHIN THE PERMIT, THE STRUCTURAL OBSERVER SHALL SUBMIT TO THE BUILDING OFFICIAL AND THE OWNER (AND THE ENGINEER OF RECORD IF AN ALTERNATE ENGINEER IS USED FOR STRUCTURAL OBSERVATION) A WRITTEN STATEMENT THAT THE SITE VISITS HAVE BEEN MADE AND IDENTIFY ANY REPORTED DEFICIENCIES WHICH, TO THE BEST OF THE STRUCTURAL OBSERVER'S KNOWLEDGE, HAVE NOT BEEN RESOLVED.
- 4. THE CONTRACTOR SHALL MAKE AVAILABLE ALL MEANS AND METHODS NECESSARY FOR THE STRUCTURAL OBSERVER TO PERFORM THE REQUIRED STRUCTURAL OBSERVATIONS. IN ADDITION, THE CONTRACTOR SHALL NOTIFY THE OWNER AND STRUCTURAL OBSERVER A MINIMUM OF 48 HOURS BEFORE THE TIME AT WHICH THE SPECIFIED STRUCTURAL OBSERVATIONS MAY BE PERFORMED. IN ADDITION THE CONTRACTOR SHALL UPDATE THE STRUCTURAL OBSERVER OF THE CONSTRUCTION PROGRESS.

#### **SUBMITTALS:**

THE CONTRACTOR SHALL PROVIDE THE ENGINEER OF RECORD AND THE BUILDING OFFICIAL SUBMITTALS FOR APPROVAL, PRIOR TO CONSTRUCTION, FOR THE FOLLOWING ITEMS:

- 1. STEEL FABRICATION SHOP DRAWINGS FOR THE BRACES AND BRACKETS, MATERIAL CERTIFICATIONS & WELDING PROCEDURES
- 2. COLD FORM STEEL FABRICATION
- 3. CONCRETE MIX DESIGN AND PROPOSED ADMIXTURES
- 4. GROUT MIX DESIGN
- 5. DEMOLITION PLAN INCLUDING METHODS, EQUIPMENT ETC. & DEMOLITION SEQUENCE

#### JOB SITE CONDITIONS AND SAFETY:

1. CONTRACTOR AGREES THAT THEY SHALL ASSUME SOLE AND COMPLETE RESPONSIBILITY FOR JOB SITE CONDITIONS DURING THE COURSE OF DEMOLITION AND CONSTRUCTION OF THIS PROJECT, INCLUDING SAFETY OF ALL PERSONS AND PROPERTY; THAT THIS REQUIREMENT SHALL APPLY CONTINUOUSLY AND NOT BE LIMITED TO NORMAL WORKING HOURS; AND THAT THE CONTRACTOR SHALL DEFEND, INDEMNIFY, AND HOLD THE ENGINEER AND IT'S REPRESENTATIVE HARMLESS FROM ANY AND ALL LIABILITY, REAL OR ALLEGED, IN CONNECTION WITH THE PERFORMANCE OF WORK ON THIS PROJECT, EXCEPTING FOR LIABILITY ARISING FROM THE SOLE NEGLIGENCE OF THE ENGINEER.

#### SPECIAL INSPECTIONS:

- 1. AN INDEPENDENT TESTING LABORATORY CHOSEN BY THE OWNER SHALL PROVIDE SPECIAL INSPECTIONS IN ACCORDANCE WITH CHAPTER 17 OF THE INTERNATIONAL BUILDING CODE FOR THE STRUCTURAL SYSTEMS OUTLINED HEREIN. ALL OTHER ELEMENTS SHALL COMPLY WITH THE SPECIAL INSPECTION & TESTING REQUIREMENTS OF CHAPTER 17 OF THE INTERNATIONAL BUILDING CODE. REQUIRED SPECIAL INSPECTION OF STRUCTURAL SYSTEMS OUTLINED IN THESE CONSTRUCTION DOCUMENTS INCLUDE THE FOLLOWING AREAS OF WORK:
  - 1.1. CONCRETE:
    - CONCRETE:
      1.1.1. CYLINDER TESTS, SLUMP TEST, AIR CONTENT
    - 1.1.1. CYLINDER TESTS, SLUMP TEST, AIR CONTENT

      1.1.2. DURING PLACEMENT OF REINFORCING STEEL & ANCHOR BOLTS
  - 1.1.3. DURING PLACEMENT OF CAST IN PLACE CONCRETE (CIP)
  - 1.2. POST-INSTALLED ADHESIVE CONCRETE ANCHORS
  - 1.3. POST-INSTALLED MECHANICAL CONCRETE ANCHORS1.4. STRUCTURAL STEEL INCLUDING PARAPET BRACES AND BRACKETS
  - 1.5. STRUCTURAL WELDING, DOES NOT APPLY TO QUALIFIED SHOP WELDS. NOTE TO BE CONSIDERED QUALIFIED SHOP WELDS THEY MUST BE PERFORMED IN A PRE—QUALIFIED SHOP AS RECORDED BY THE HUBISDICTION OF PEOORD A WRITTEN VERIFICATION OF PEOORD A WRITTEN VERIFICATION OF PEOORD AS WRITTEN VERI
  - BY THE JURISDICTION OF RECORD, A WRITTEN VERIFICATION OF PRE—QUALIFICATION WITH THE JURISDICTION OF RECORD IS REQUIRED PRIOR TO PERFORMING ANY STRUCTURAL WELDING IN A SHOP WITHOUT SPECIAL INSPECTION.
  - 1.6. HIGH STRENGTH BOLTING
- 2. THE TESTING AGENCY SHALL PROVIDE THE ENGINEER OF RECORD, THE OWNER, AND THE BUILDING OFFICIAL COPIES OF ALL RELEVANT TEST REPORTS AND SPECIAL INSPECTIONS.



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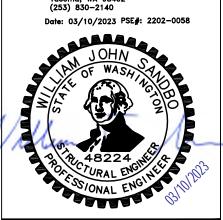


ABB Project # 22-7763.01

Skagit County Project # 3809

Skagit County Superior Court Rooftop Jailhouse Removal OWNER NAME / ADDRESS: Skagit County, a Municipal Corporation 1800 Continental Place Mount Vernon, WA 98273 PROPERTY ADDRESS: 205 W. Kincaid Street Mount Vernon, WA 98273 PROPERTY MANAGER: Skagit County Facilities Management 1800 Continental Place Mount Vernon, WA 98273 Contact: Ken Hansen

Mark	Description	Date
	PERMIT SET	03/10/23
	BID SET ISSUE	09/25/23
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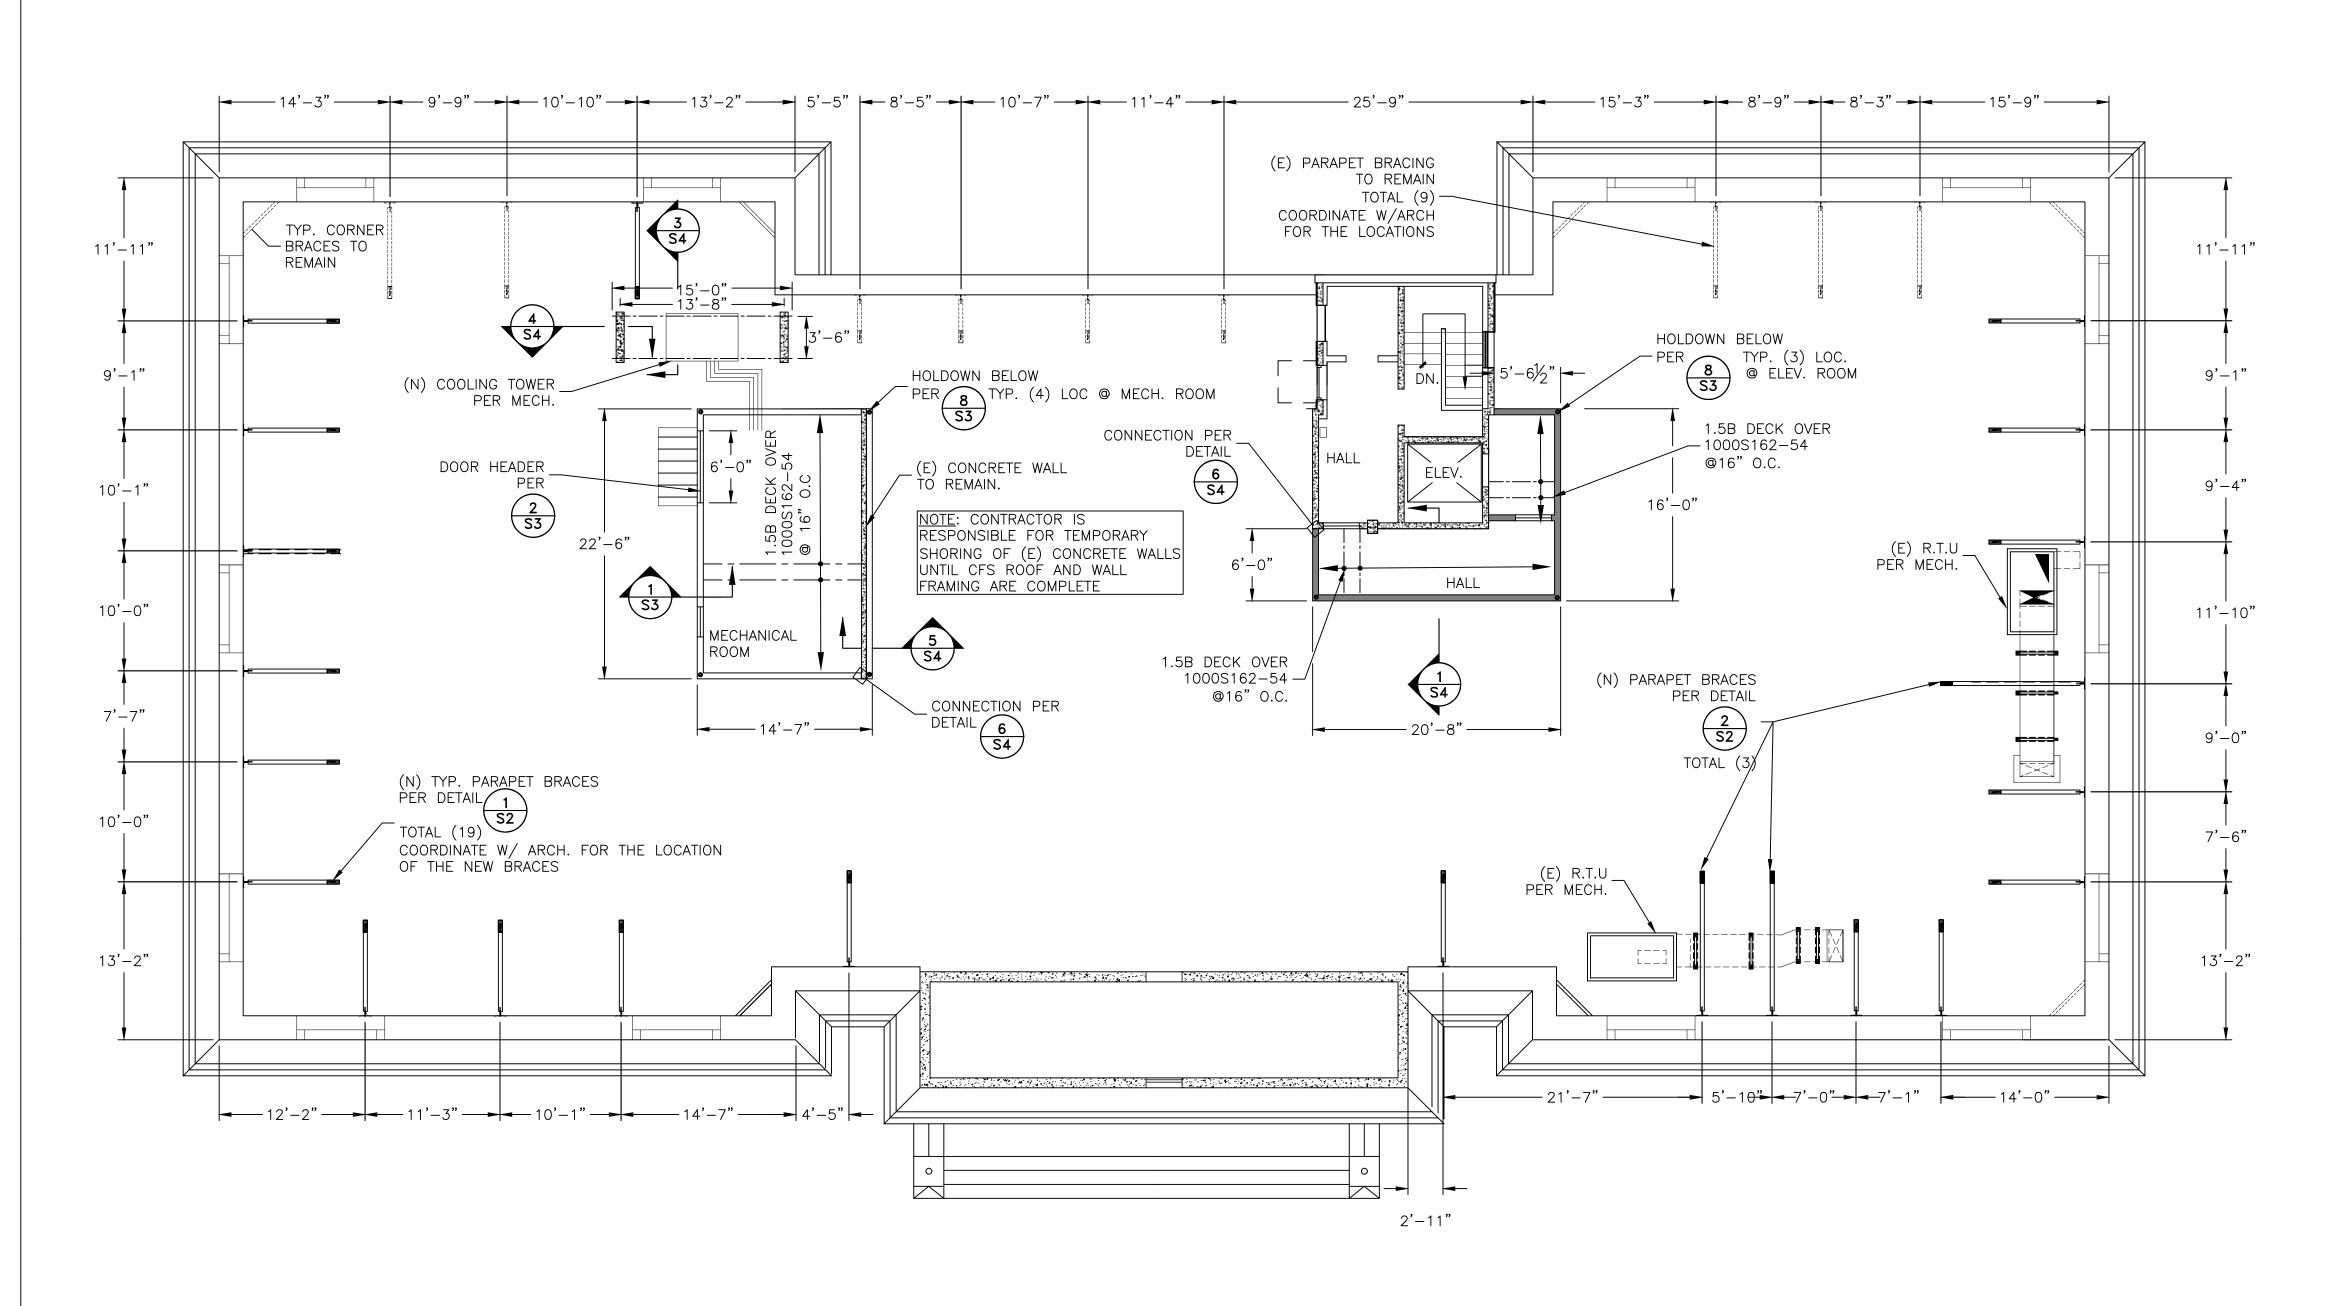
BUILDING DEPARTMENT PERMIT # TBD

SHEET TITLE

GENERAL NOTES & DESIGN CRITERIA

\_ \_

SCALE: NOTED ON DRAWINGS



## PROPOSED ROOF BRACING AND ENCLOSURE FRAMING LAYOUT

1/4" = 1'-0"

#### ENCLOSURE WALL SCHEDULE

ID	SHEATHING	PANEL ATTACHMENT @ EDGE	END STUD	HOLDOWN	NON-HOLDOWN ANCHORS
	¾" SURE-BOARD SERIES 200	#8 SDS SCREWS @ 6" O.C.		S/HDU6 HOLDOWNS ATTACH W/(12)#14 SCREWS	½"ø THRD'D ROD W/HILTI HIT RE 500 @ 48" O.C.

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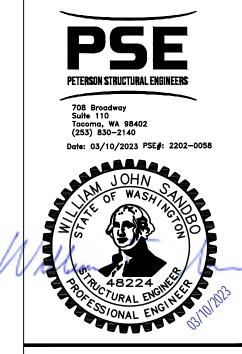


ABB Project # 22-7763.01

Skagit County Project # 3809

PROJECT NAME:
Skagit County Superior Court
Rooftop Jailhouse Removal
OWNER NAME / ADDRESS:
Skagit County,
a Municipal Corporation
1800 Continental Place
Mount Vernon, WA 98273
PROPERTY ADDRESS:
205 W. Kincaid Street
Mount Vernon, WA 98273
PROPERTY MANAGER:
Skagit County Facilities

Management

1800 Continental Place

Mount Vernon, WA 98273 Contact: Ken Hansen

Mark	Description	Date
	PERMIT SET	03/10/2
	BID SET ISSUE	09/25/2


BUILDING DEPARTMENT PERMIT # TBD

SHEET TITLE


PROPOSED ROOF LAYOUT


SCALE: NOTED ON DRAWINGS

**S1** 

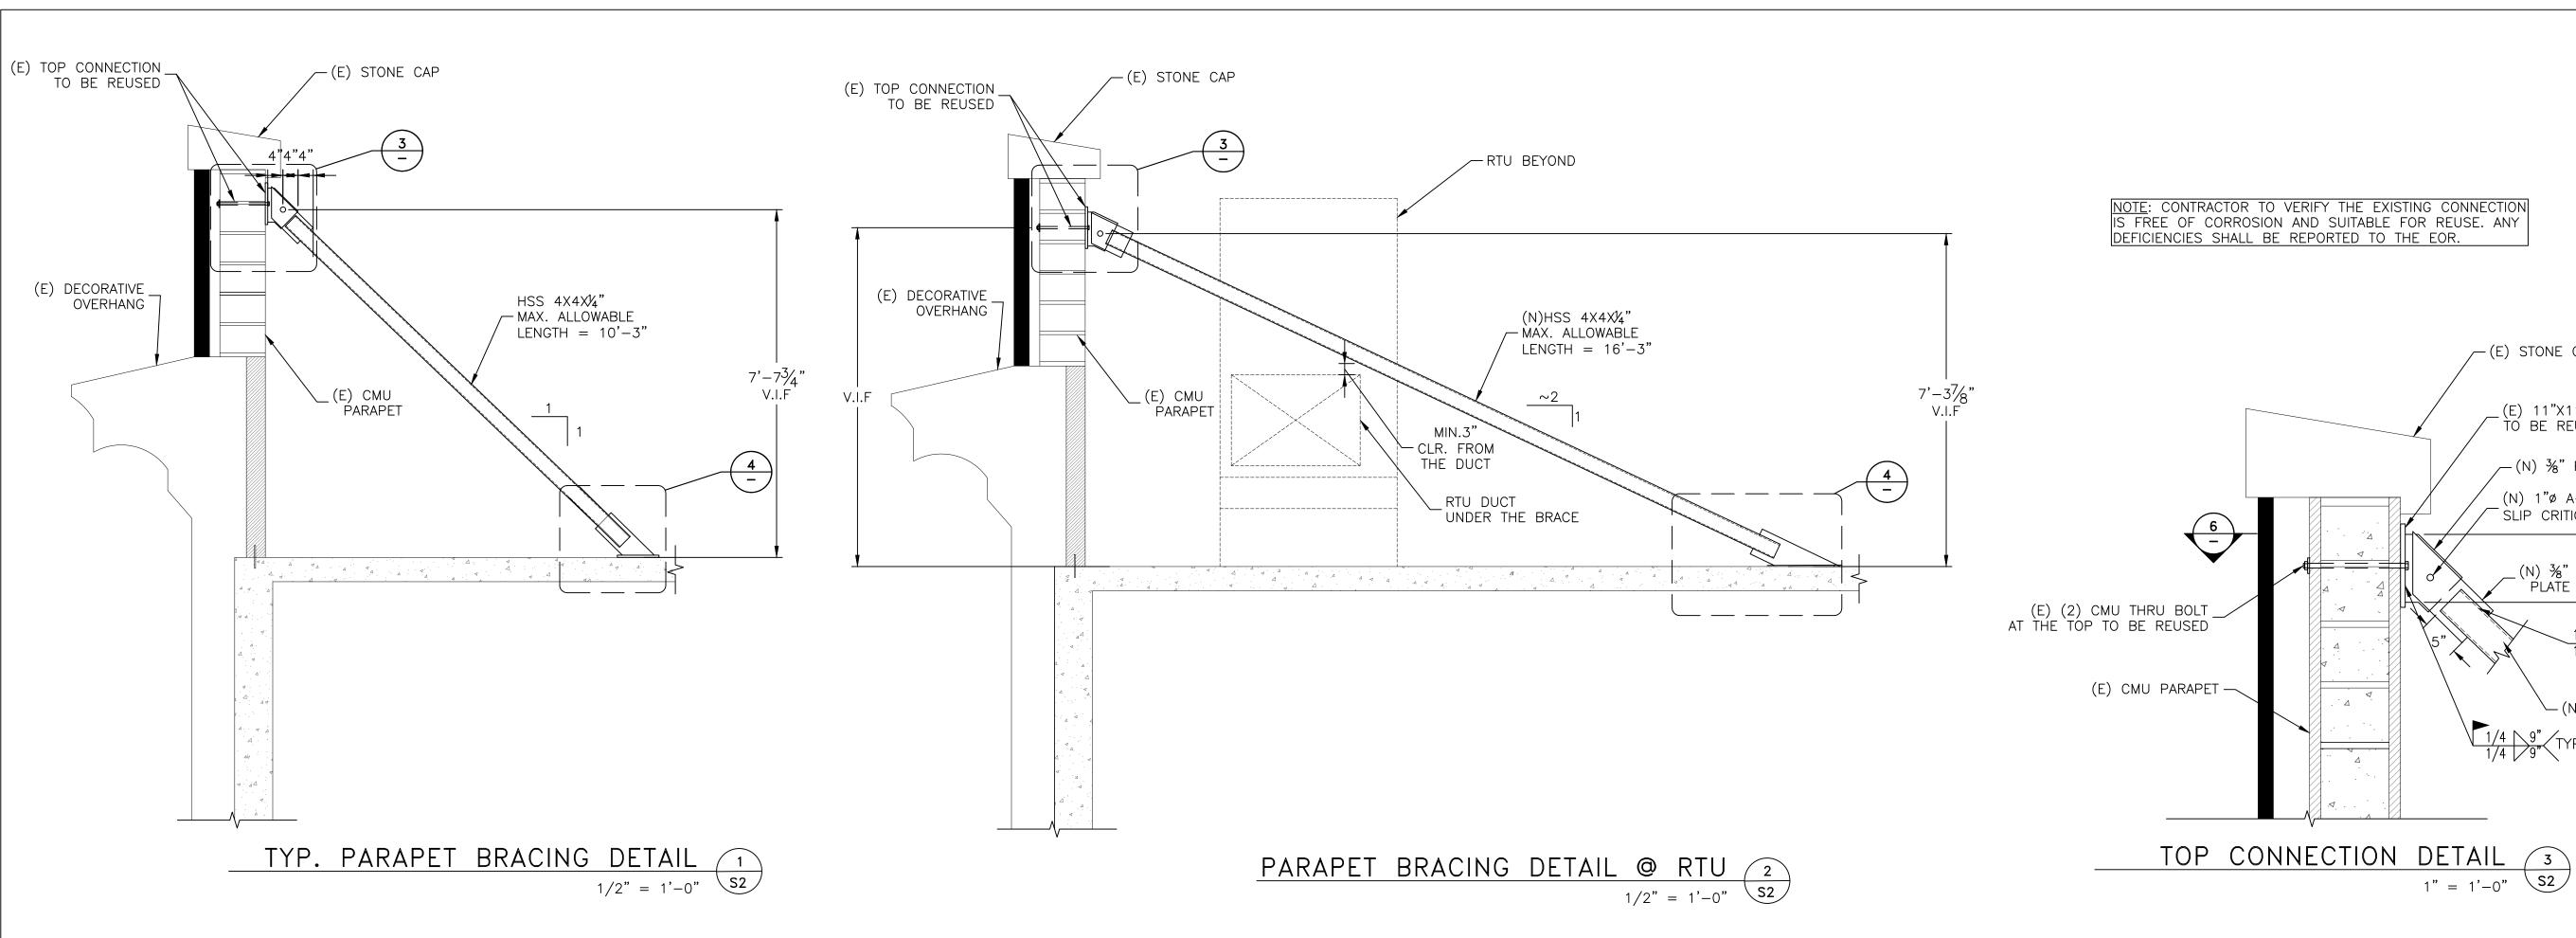


NOTE: CONTRACTOR TO VERIFY THE EXISTING CONNECTION IS FREE OF CORROSION AND SUITABLE FOR REUSE. ANY DEFICIENCIES SHALL BE REPORTED TO THE EOR.

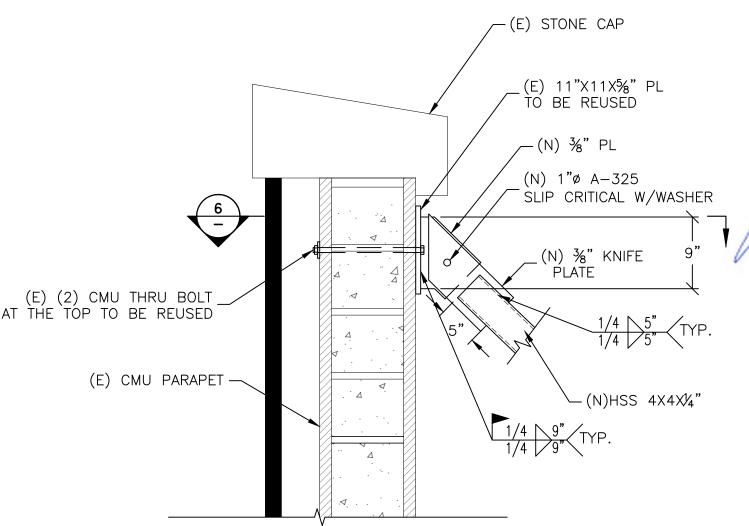

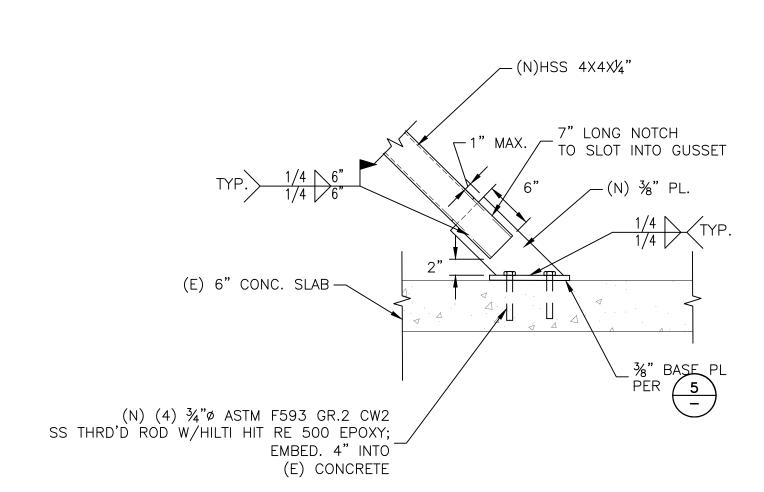


NEW BASE CONNECTION DETAIL 4

1" = 1'-0" S2

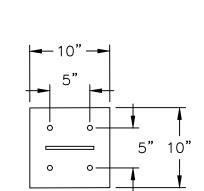

BASE PLATE DETAIL 5

1" = 1'-0" S2

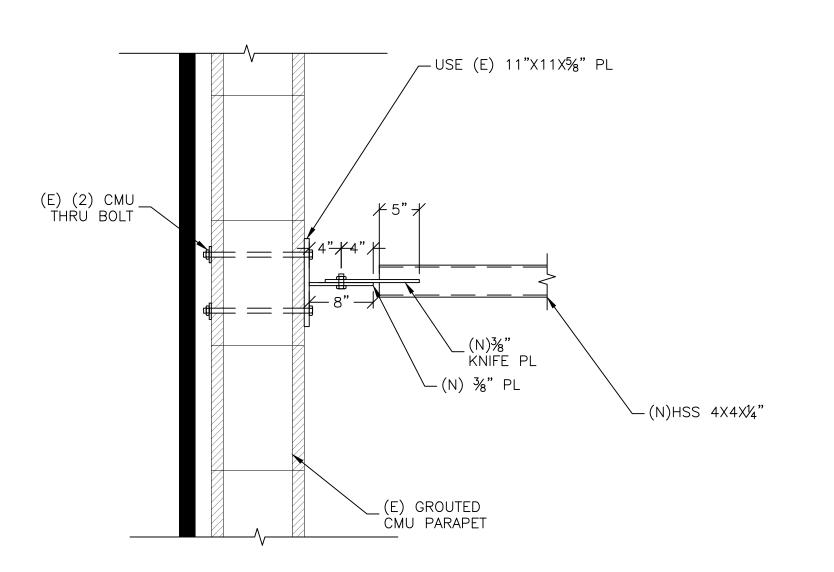

TOP CONNECTION SECTION 6 1" = 1'-0"



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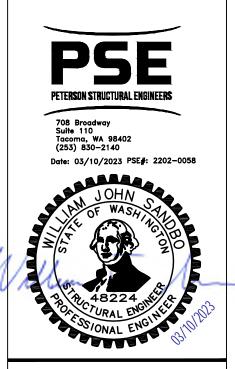


ABB Project # 22-7763.01

Skagit County Project # 3809

PROJECT NAME:
Skagit County Superior Court
Rooftop Jailhouse Removal OWNER NAME / ADDRESS: Skagit County, a Municipal Corporation 1800 Continental Place Mount Vernon, WA 98273 PROPERTY ADDRESS:

205 W. Kincaid Street Mount Vernon, WA 98273 PROPERTY MANAGER: Skagit County Facilities Management 1800 Continental Place Mount Vernon, WA 98273 Contact: Ken Hansen

Mark	Description	Date
	PERMIT SET	03/10/2
	BID SET ISSUE	09/25/2
_		


**BUILDING DEPARTMENT** PERMIT # TBD

SHEET TITLE

PARAPET **BRACE DETAIL** 

SCALE: NOTED ON DRAWINGS

**S2** 

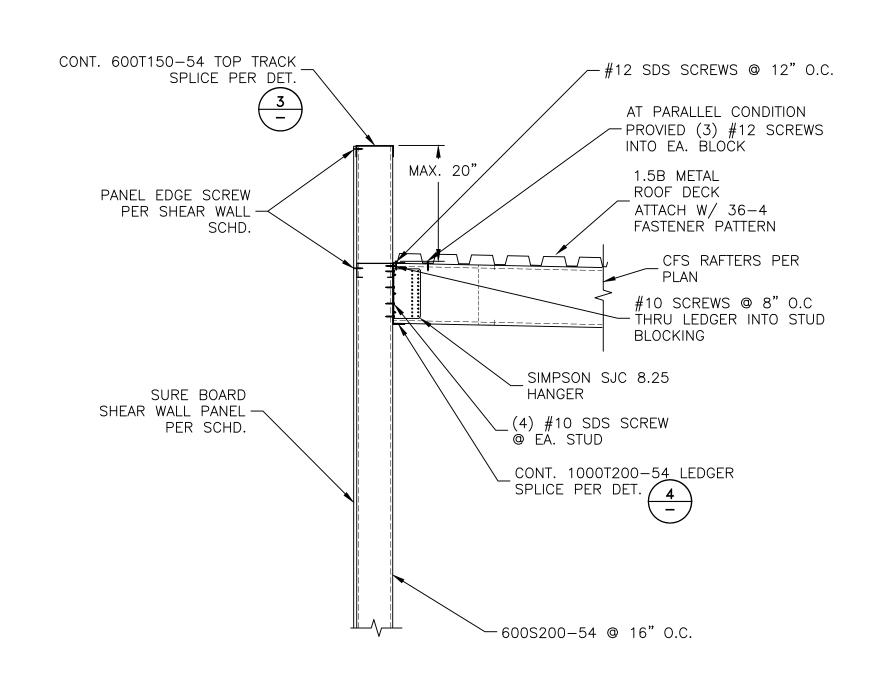

3/4" = 1'-0" S3

CONT. 2"X43 MIL

LS50 CONNECTOR \_W/ #10 SDS SCREWS

@ EÄ. END OF

1.5B METAL

ROOF DECK

S462-54 BLOCK

- BLOCK DEPTH SHALL BE 2" LESS THAN

RAFTER

@ EA. END AND @ 6'-0" O.C

STEEL STRAP

#10 SCREWS

ËA. STUD

STUD WALL SECTION (1)

600T150-54 BLOCK PIECE

INSTALL EA. END OF THE WALL —

NOTE: PROVIDE BLOCK AND STRAP BRIDGING

TYP. BRIDGING W/BLOCKING 5
N.T.S 53

AND REPEAT IN (2) BAYS EVERY 8' O.C.

AT 6'-0" O.C. VERTICAL SPACING.

(3) #10 SDS SCREWS \_


ROOF RAFTERS

CONT. 2"X43 MIL STEEL STRAP W/#10 -/


SCREWS TO EA. RÁFTER

PER PLAN


-600S200-54 @ 16" O.C.

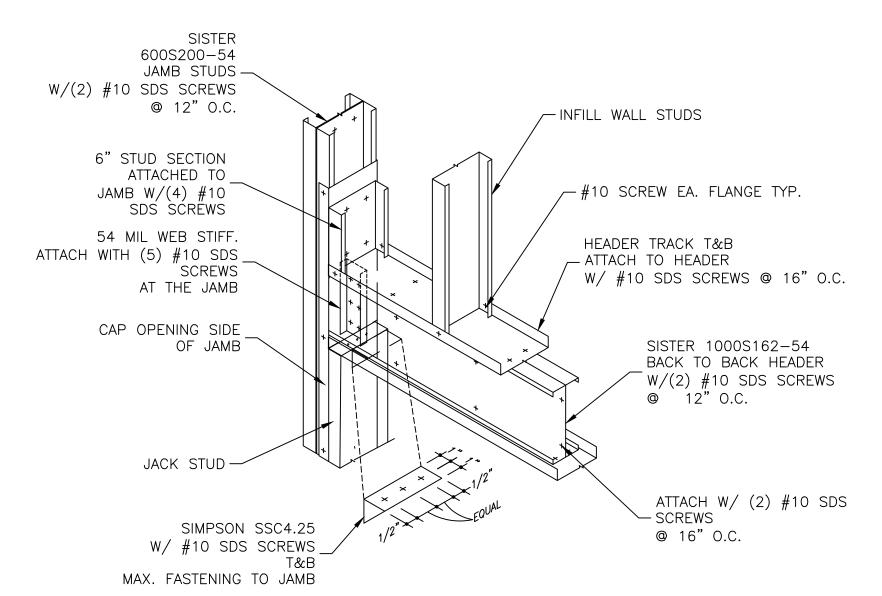

HEADER DETAIL 2

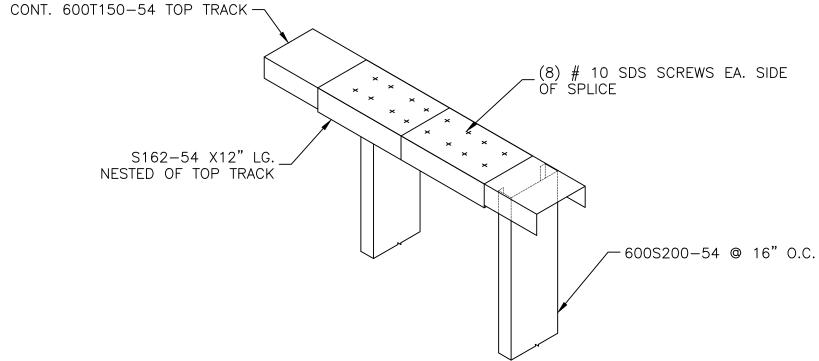





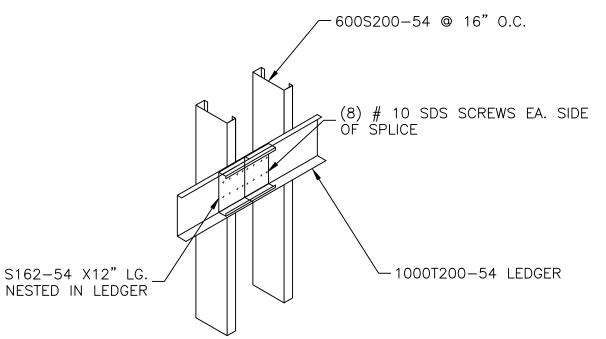


TYP. LEDGER SPLICE DETAIL (4)

# S162-54 X12" LG. NESTED IN LEDGER

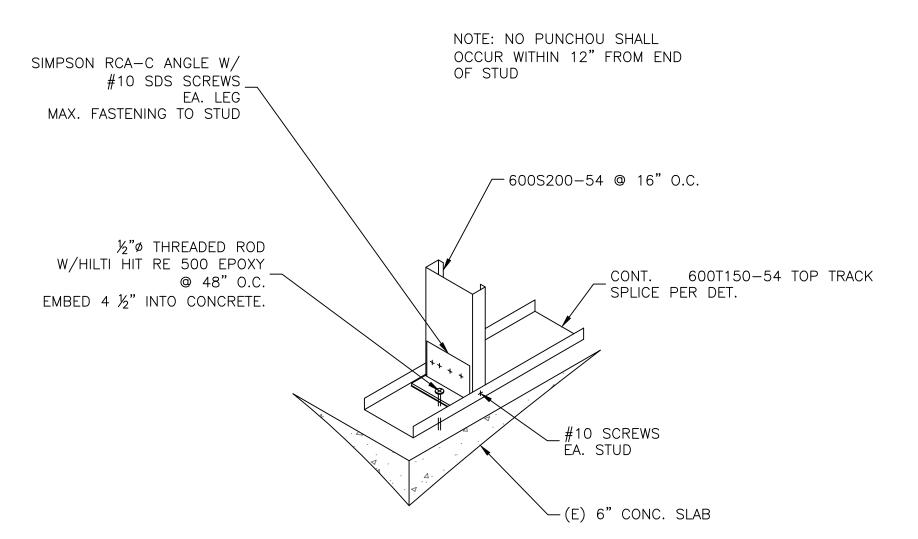

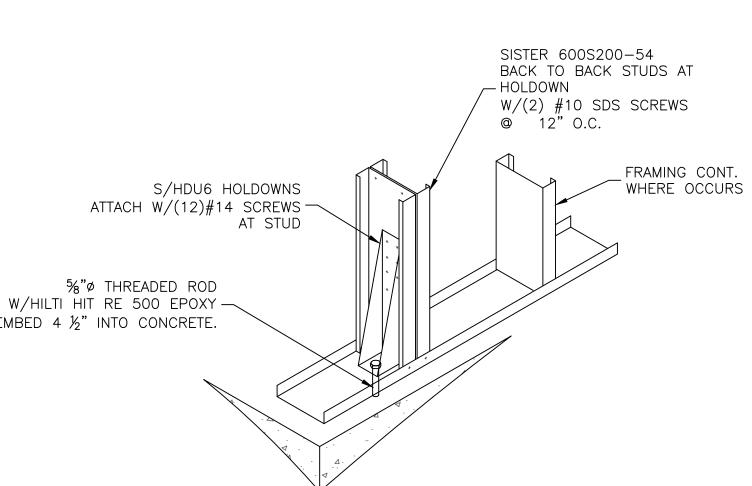

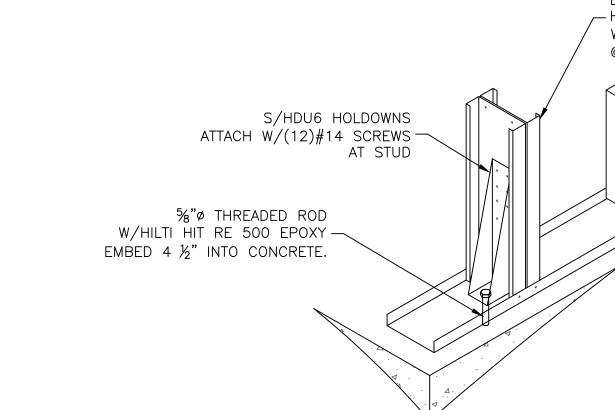

**CFS WALL DETAILS** 

SCALE: NOTED ON DRAWINGS

TYP. RAFTER BRIDGING DETAIL 6

LS70 CLIP EA.

END OF EA. BLOCK

WALL ANCHORAGE DETAIL 7

N.T.S S3

HOLDOWN DETAIL (8) N.T.S S3

**BUILDING DEPARTMENT** PERMIT # TBD

SHEET TITLE

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206-443-6499

PETERSON STRUCTURAL ENGINEERS

Date: 03/10/2023 PSE#: 2202-0058

ABB Project # 22-7763.01

Skagit County Project # 3809

Skagit County Superior Court Rooftop Jailhouse Removal

OWNER NAME / ADDRESS:

a Municipal Corporation

1800 Continental Place

Mount Vernon, WA 98273 PROPERTY ADDRESS: 205 W. Kincaid Street

Mount Vernon, WA 98273 PROPERTY MANAGER:

Skagit County Facilities

1800 Continental Place

PERMIT SET

Mount Vernon, WA 98273 Contact: Ken Hansen

Description

**BID SET ISSUE** 

Date


03/10/23

Management


Skagit County,

708 Broadway Suite 110 Tacoma, WA 98402 (253) 830—2140


**S3** 

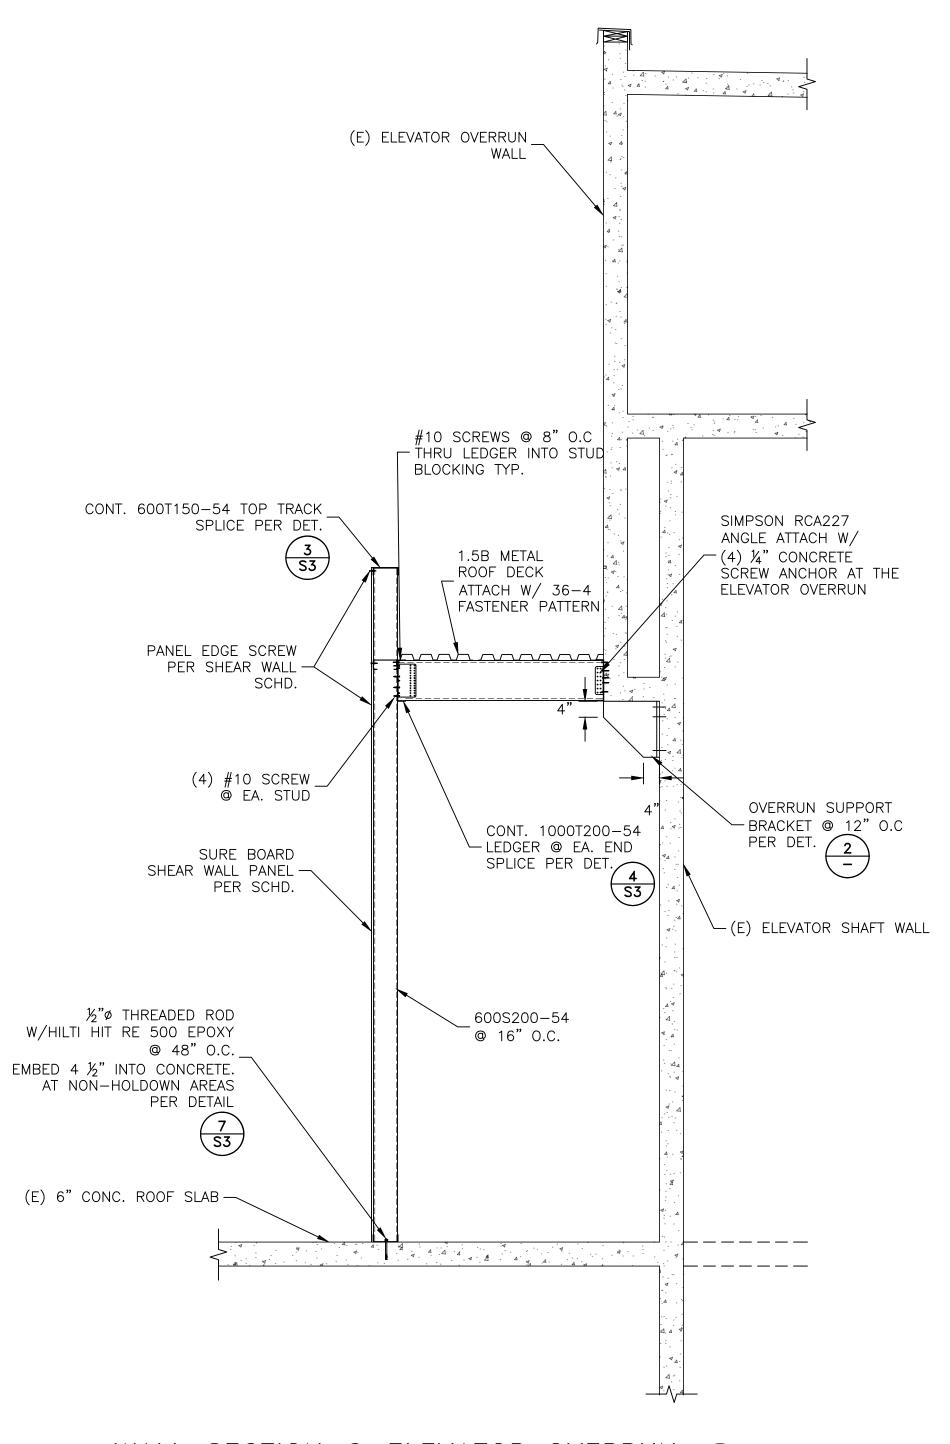




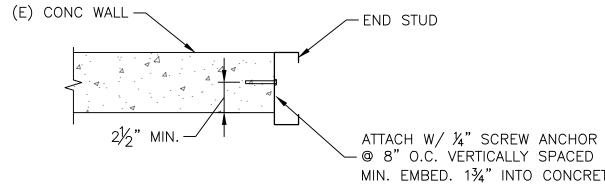


TYP. CONNECTION DETAIL @ CONCRETE WALL 6 1/2" = 1'-0" S4

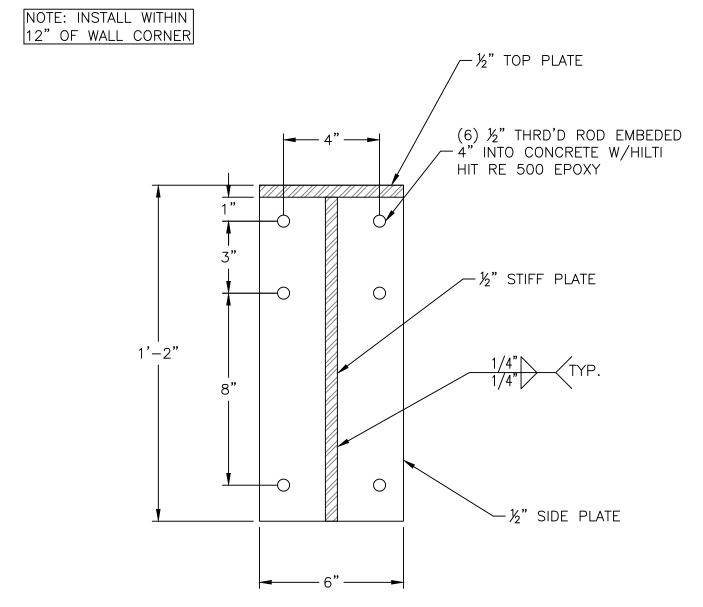


OVERRUN WALL SUPPORT BRACKET DETAIL (2) 3" = 1'-0" 54

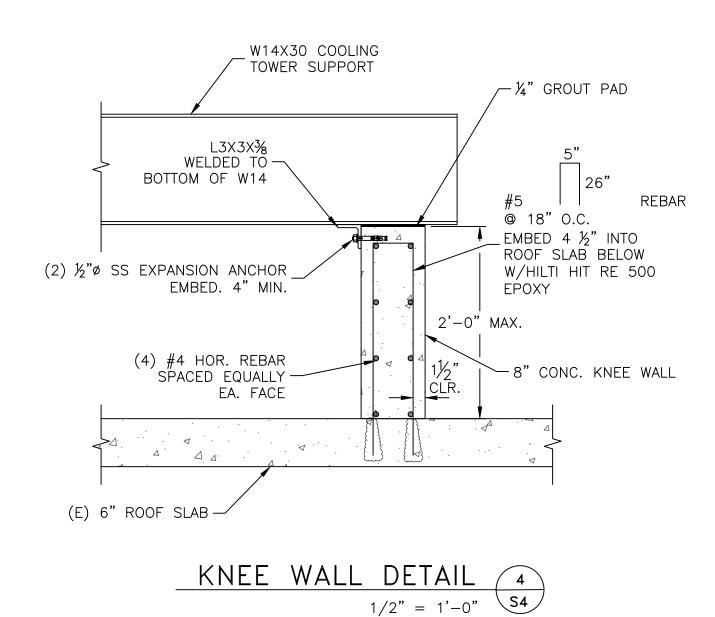

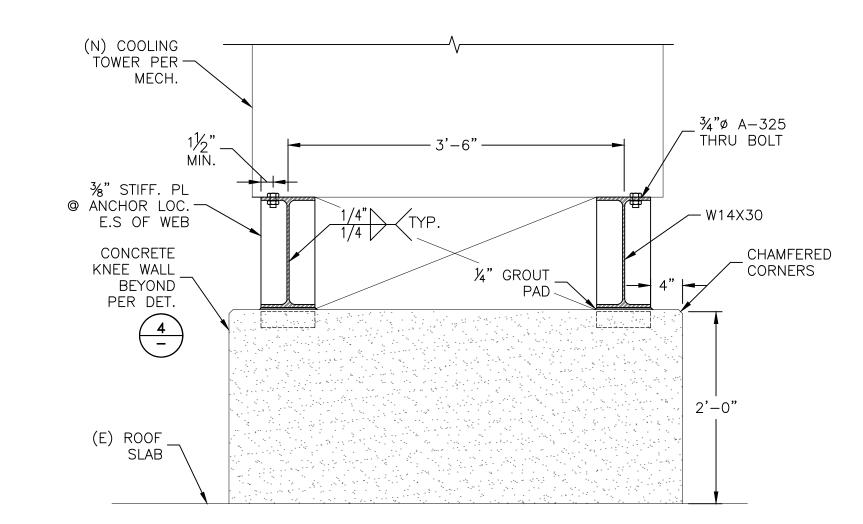



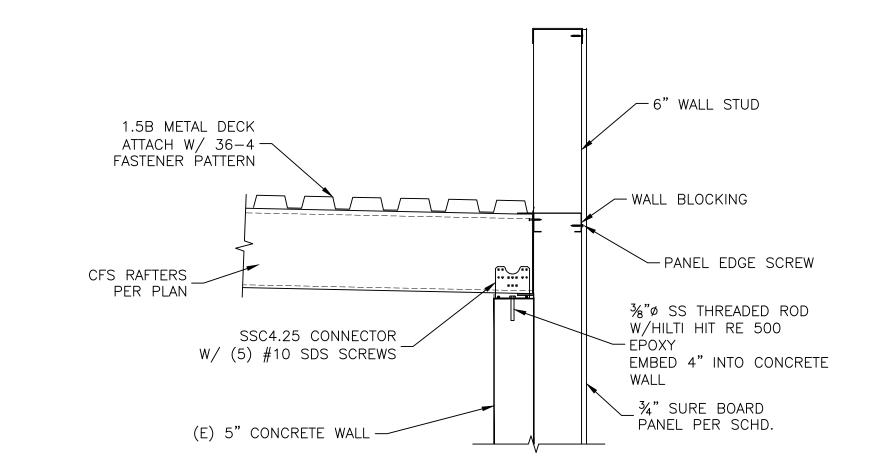

(E) CONCRETE WALL ATTACHMENT DETAIL 5
1/2" = 1'-0" S4



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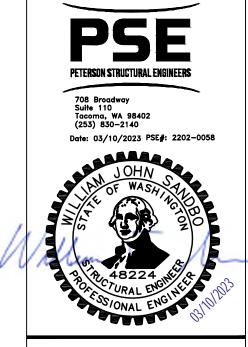


ABB Project # 22-7763.01

Skagit County Project # 3809

PROJECT NAME:
Skagit County Superior Court
Rooftop Jailhouse Removal OWNER NAME / ADDRESS: Skagit County, a Municipal Corporation 1800 Continental Place Mount Vernon, WA 98273 PROPERTY ADDRESS: 205 W. Kincaid Street Mount Vernon, WA 98273 PROPERTY MANAGER: Skagit County Facilities Management 1800 Continental Place

Mount Vernon, WA 98273

Mark	Description	Date
	PERMIT SET	03/10
	BID SET ISSUE	09/25


**BUILDING DEPARTMENT** PERMIT # TBD

SHEET TITLE

STRUCTURAL **DETAILS** 

SCALE: NOTED ON DRAWINGS

**S4** 

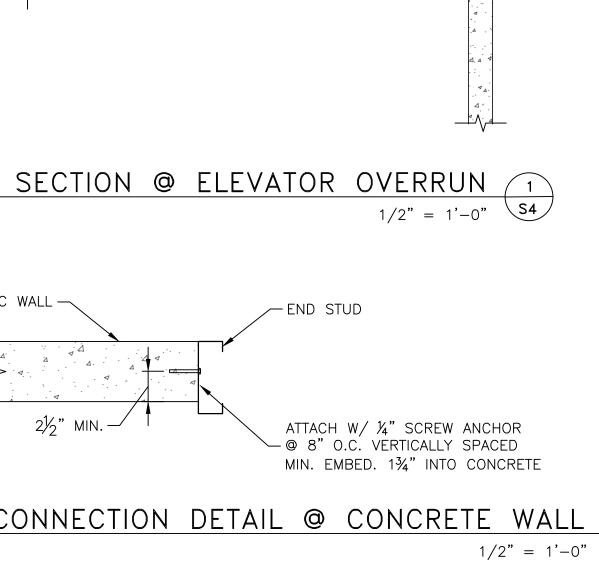

1. THE MAX. STOCK PILE LOAD SHALL BE AS NOTED. LISTED LOAD ARE TOTAL LOAD ON THE SLAB DURING DEMOLITION WORK.

2. CONTRACTOR SHALL PROVIDE ACTUAL WEIGHT OF THE DEMOLITION EQUIPMENTS. 3. DURING DEMOLITION WORK AND STOCKPILING, CARE SHOULD BE TAKEN TO AVOID IMPACTING OTHER STRUCTURAL ELEMENTS.


<u>LEGEND</u>

ALLOWABLE STOCKPILE ZONE, 200 PSF MAX. AVERAGE LOADING LIGHT DUTY STOCKPILE ZONE, 40 PSF MAX. AVERAGE LOADING

NO LOAD ZONE - STOCKPILING NOT ALLOWED

□□□□□□ EXISTING CONCRETE FLOOR BEAM BELOW

EXISTING CONCRETE COLUMN BELOW

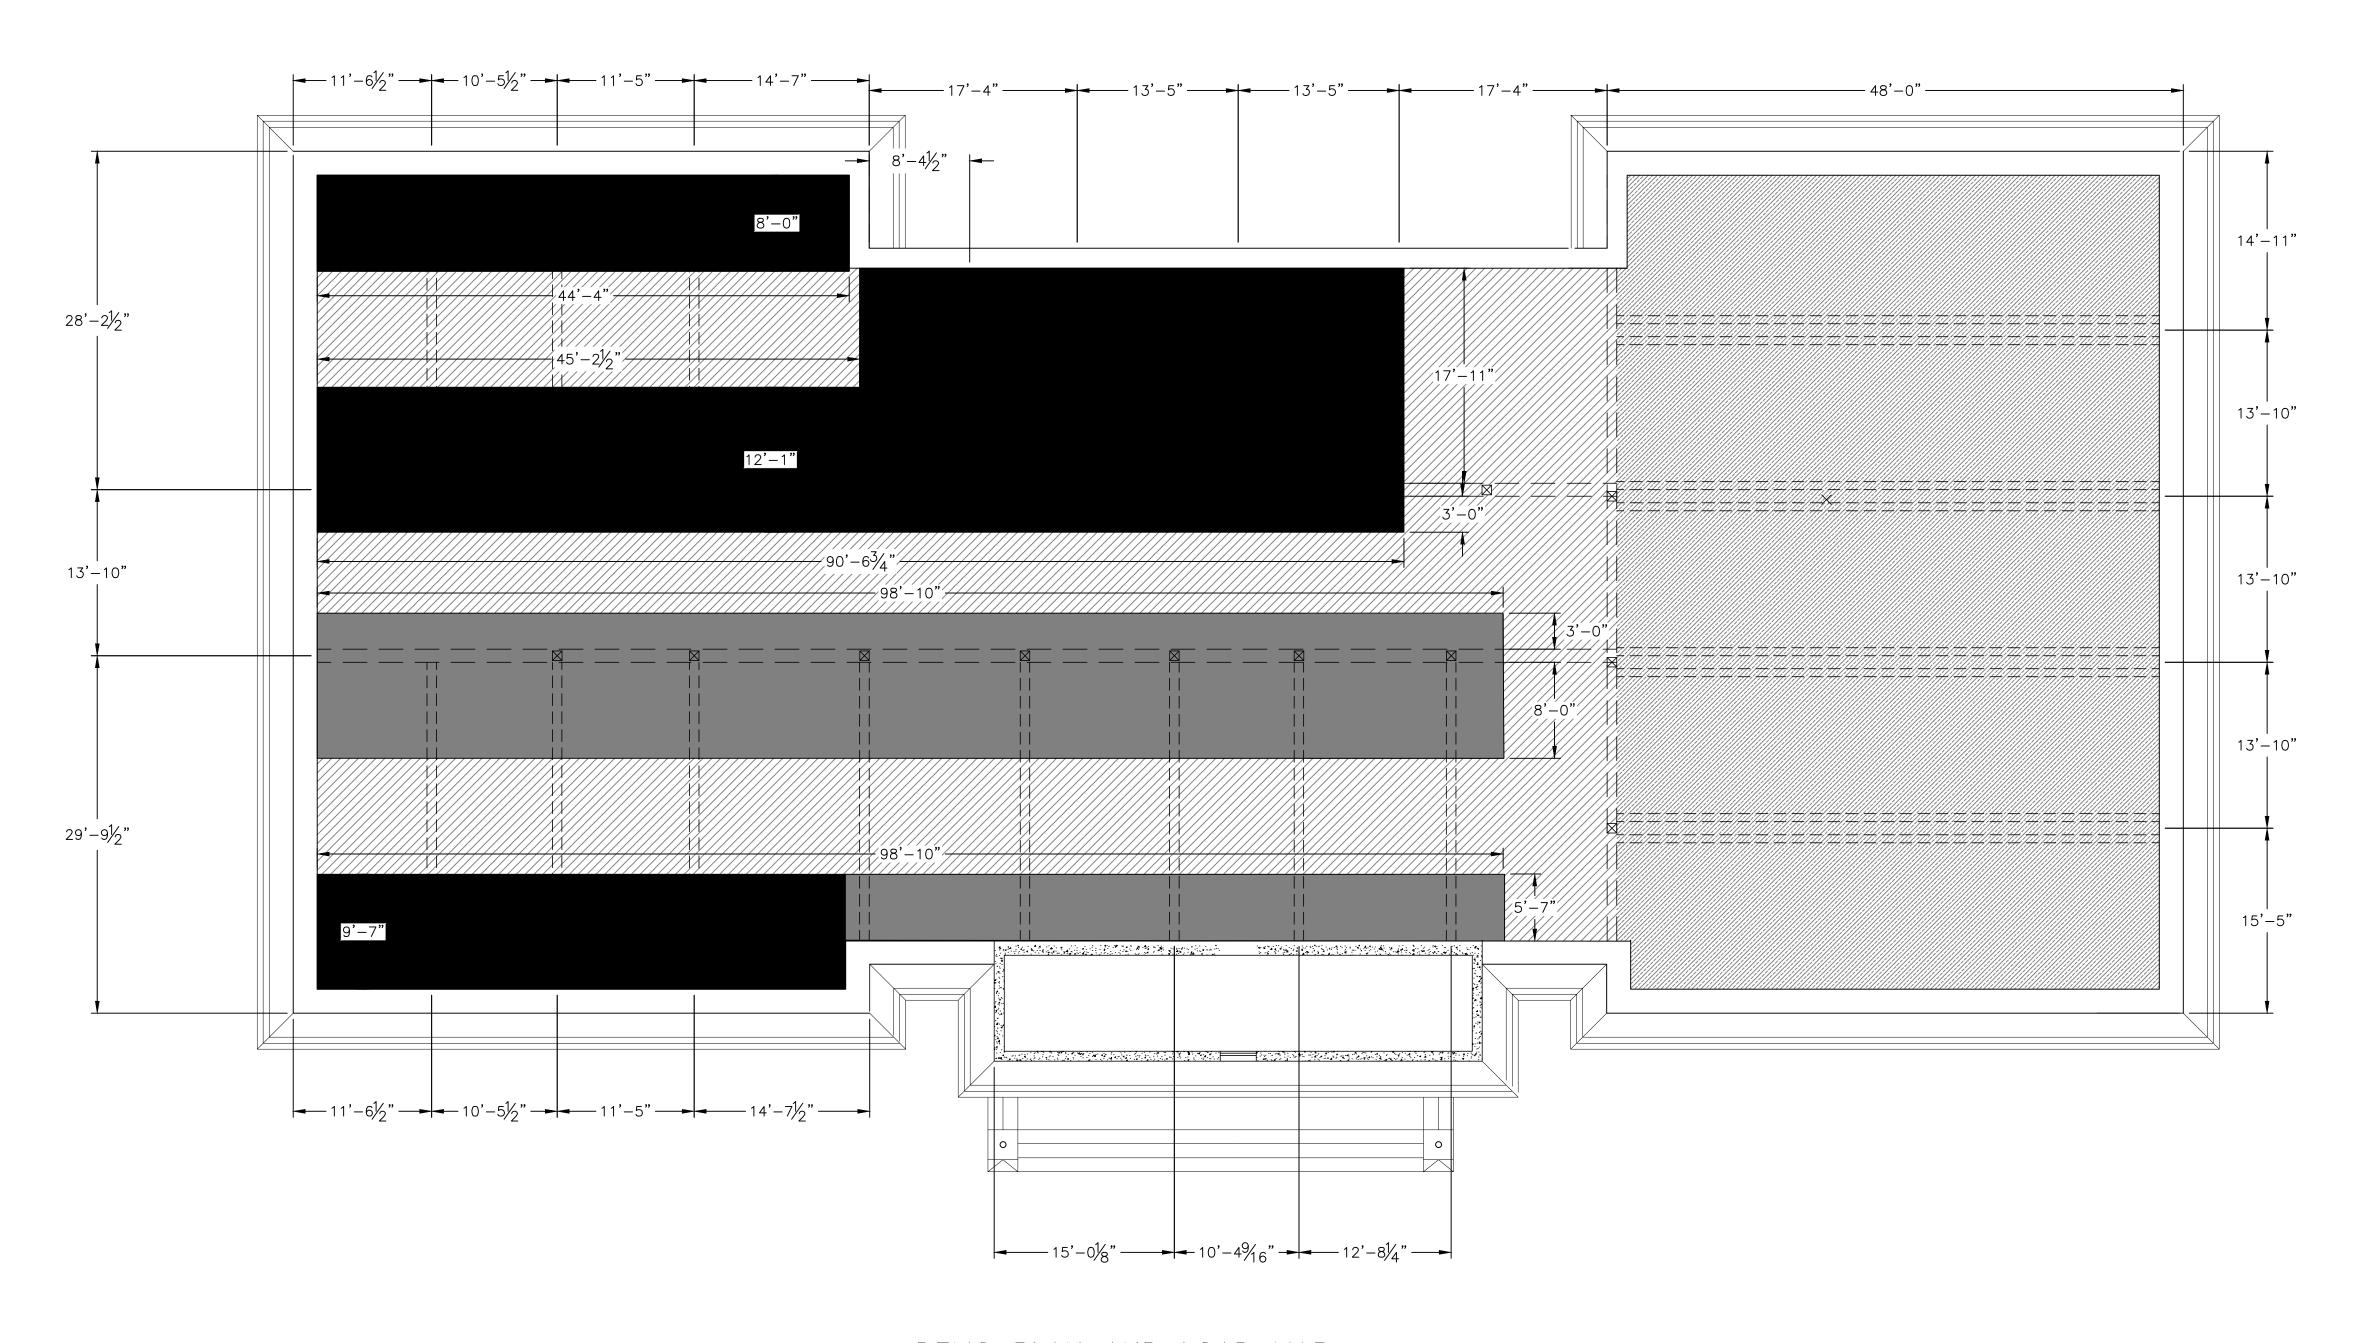


DEMO PLAN AND LOAD MAP

1/8" = 1'-0"



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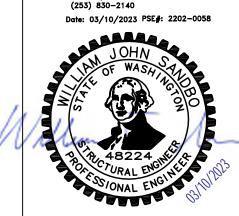


ABB Project # 22-7763.01

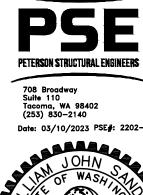Skagit County Project # 3809

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Skagit County Superior Court
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Mark	Description	Date
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	BID SET ISSUE	09/25/2
_		
l		

**BUILDING DEPARTMENT** PERMIT # TBD

SHEET TITLE

**DEMO PLAN** AND LOAD MAP

SCALE: NOTED ON DRAWINGS

**S5** 

## PLUMBING SYMBOL LIST

#### **Abbreviations**

CONT. CONTINUATION

DIA DIAMETER DN DOWN

DFU DRAINAGE FIXTURE UNIT

HVAC HEATING, VENTILATING AND AIR CONDITIONING L LAVATORY

NPCW NON-POTABLE COLD WATER

PLBG PLUMBING
POC POINT OF CONNECTION

QTY QUANTITY

RD ROOF DRAIN

SF SQUARE FEET

#### <u>General</u>

DEMOLISH (DASH-DOT)

----- EXISTING WORK

NEW WORK

POINT OF CONNECTION

#### **Piping Fittings**

——₃ CAP

√O VTR VENT THROUGH ROOF

#### **Piping Systems**

----NG------ NATURAL GAS PIPING, 2 LB

---NPCW - --- NON-POTABLE COLD WATER PIPING

SANITARY VENT PIPING

#### Valves

SHUTOFF VALVE, GENERAL

## **GENERAL PLUMBING NOTES**

- A. ALL WORK UNDER THIS CONTRACT SHALL CONFORM TO THE CURRENT STATE, COUNTY AND NATIONAL CODES AND STANDARDS ADOPTED BY THE LOCAL JURISDICTIONS INCLUDING APPLICABLE AMENDMENTS.
- B. CONDITIONS SHOWN ON THE PLANS RELATIVE TO THE WORK TO BE PERFORMED ARE BASED ON THE BEST INFORMATION AVAILABLE AND SUBJECT TO VERIFICATION. VERIFY LOCATIONS AND ELEVATIONS OF UTILITIES TO BE CROSSED OR CONNECTED. CORRECT DEFICIENCIES CAUSED BY FAILURE TO PERFORM SUCH VERIFICATIONS AT NO EXPENSE TO THE OWNER. IMMEDIATELY NOTIFY ARCHITECT AND ENGINEER OF THE CONDITION IN CONFLICT WITH THE DETAILS/PLANS.
- C. COORDINATE INSTALLATION OF PIPING, FIXTURES, EQUIPMENT AND THE LIKE WITH STRUCTURAL COMPONENTS AND ALL OTHER SYSTEM INSTALLATIONS.



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Seattle, WA 98119

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The undersigned has provided building enclosure documents that in my professional judgement are appropriate to satisfy the requirements of RCW 64.55.005 through 64.55.090

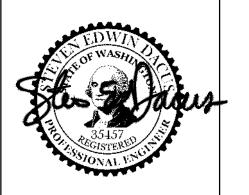


ABB PROJECT #: 22-7763.01

SCOPE OF WORK:

4th Floor Jail Demolition
& Re-roofing

OWNER NAME:
Skagit County Courthouse

PROPERTY ADDRESS:
205 W. Kincaid Street
Mount Vernon, WA 98273

PROPERTY MANAGER:
Skagit County Facilities
Management
1800 Continental Place
Mount Vernon, WA 98273

MIGIN	Bocomption	Date
	PERMIT SET	03/10/23
/1\	Permit Correction Bid Set	
	BID SET ISSUE	09/25/23

BUILDING DEPARTMENT PERMIT # TBD

## **SHEET INDEX**

- P0.1 SYMBOL LIST AND GENERAL NOTES PLUMBING
- P1.1 4TH FLOOR AND ROOF DEMO PLAN PLUMBING
- P2.1 4TH FLOOR AND ROOF PLAN PLUMBING



PROJECT 2022-0114
CONTACT Tracy Bethel


100 SW Main Street, Suite 1600 Portland, OR 97204 TEL 503.382.2266 www.interfaceengineering.com

SHEET TITLE

SYMBOL LIST AND GENERAL NOTES -PLUMBING

SCALE: NOTED ON DRAWINGS

P0.1

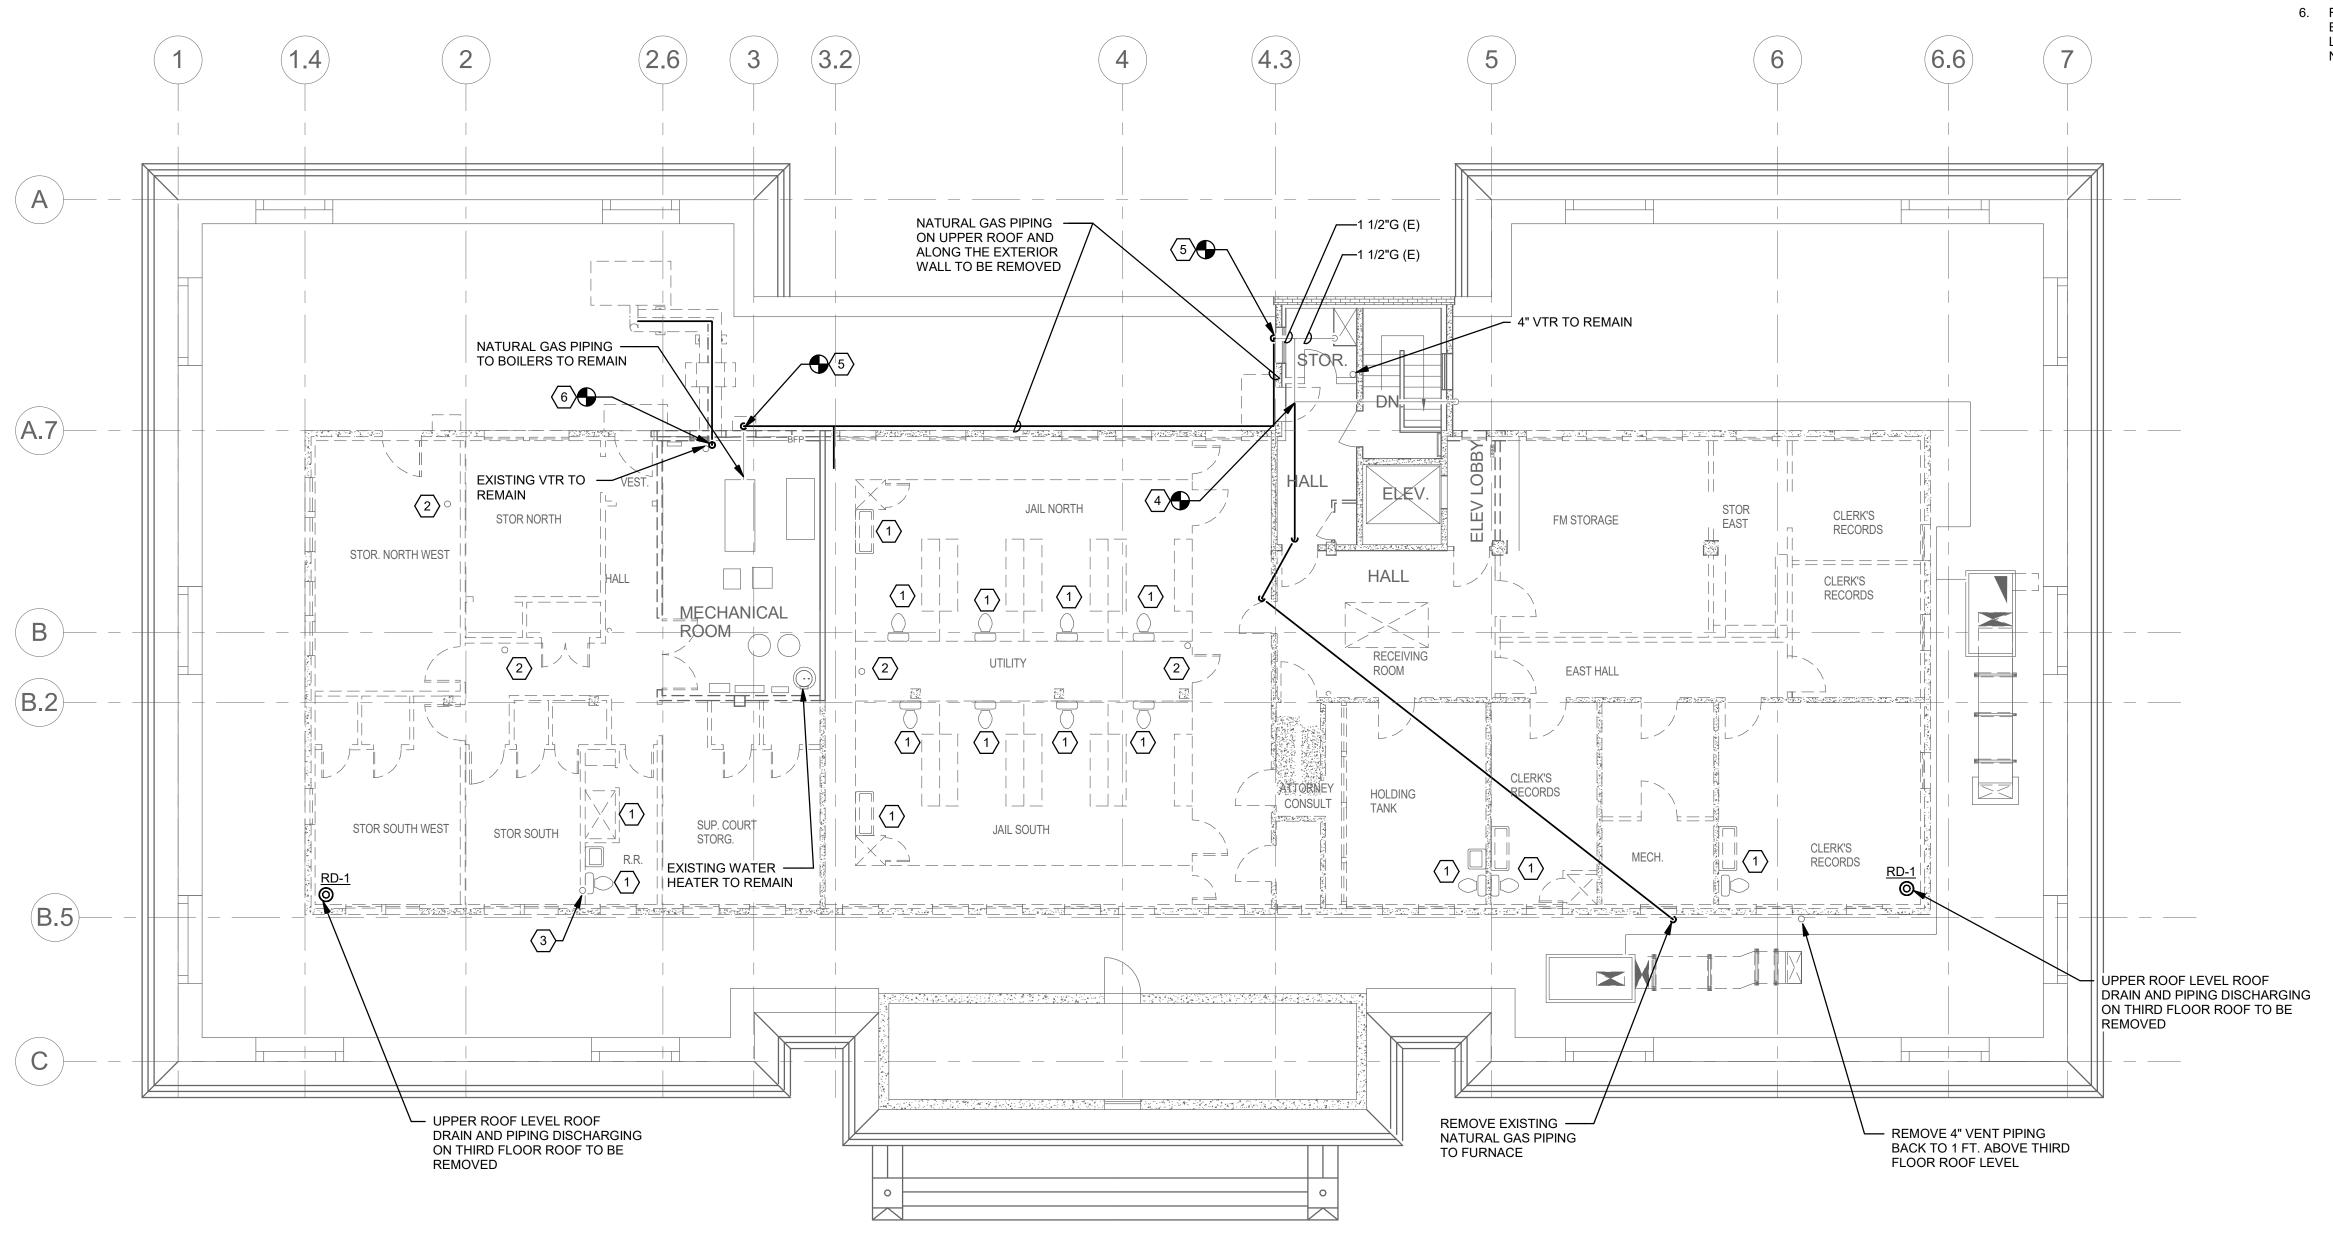

4TH FLOOR AND ROOF DEMO PLAN - PLUMBING

1/8" = 1'-0"

## ○ SHEET KEYNOTES

- 1. REMOVE EXISTING PLUMBING FIXTURE AND ASSOCIATED APPURTENANCES. REMOVE SANITARY SEWER PIPING BACK TO THIRD FLOOR ROOF AND CAP IN-PLACE, REMOVE VENT PIPING ENTIRELY, REMOVE WATER PIPING ENTIRELY.
- 2. REMOVE EXISTING VENT PIPING FROM UPPER ROOF BACK TO 1 FT ABOVE THIRD FLOOR ROOF.
- 3. REMOVE EXISTING VENT PIPING ENTIRELY.
- 4. REMOVE EXISTING GAS PIPING BACK TO THIS APPROXIMATE LOCATION AND CAP IN PLACE.
- 5. REMOVE EXISTING NATURAL GAS PIPING BACK TO THIS APPROXIMATE LOCATION. SEE SHEET P2.1 FOR NEW WORK
- REMOVE EXISTING NON-POTABLE WATER PIPING FROM EXISTING COOLING TOWER BACK TO THIS APPROXIMATE LOCATION IN MECHANICAL ROOM. SEE SHEET P2.1 FOR NEW WORK.



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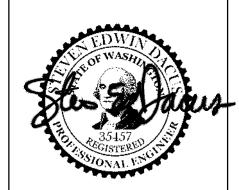


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4th Floor Jail Demolition
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OWNER NAME:
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205 W. Kincaid Street
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PROPERTY MANAGER:
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Management
1800 Continental Place
Mount Vernon, WA 98273

Mark Description Date

PERMIT SET 03/10/23

Permit Correction
Bid Set

BID SET ISSUE 09/25/23

BUILDING DEPARTMENT PERMIT # TBD



PROJECT 2022-0114
CONTACT Tracy Bethel


100 SW Main Street, Suite 1600 Portland, OR 97204 TEL 503.382.2266 www.interfaceengineering.com

SHEET TITLE

4TH FLOOR AND ROOF DEMO PLAN -PLUMBING

SCALE: NOTED ON DRAWINGS

P1.1

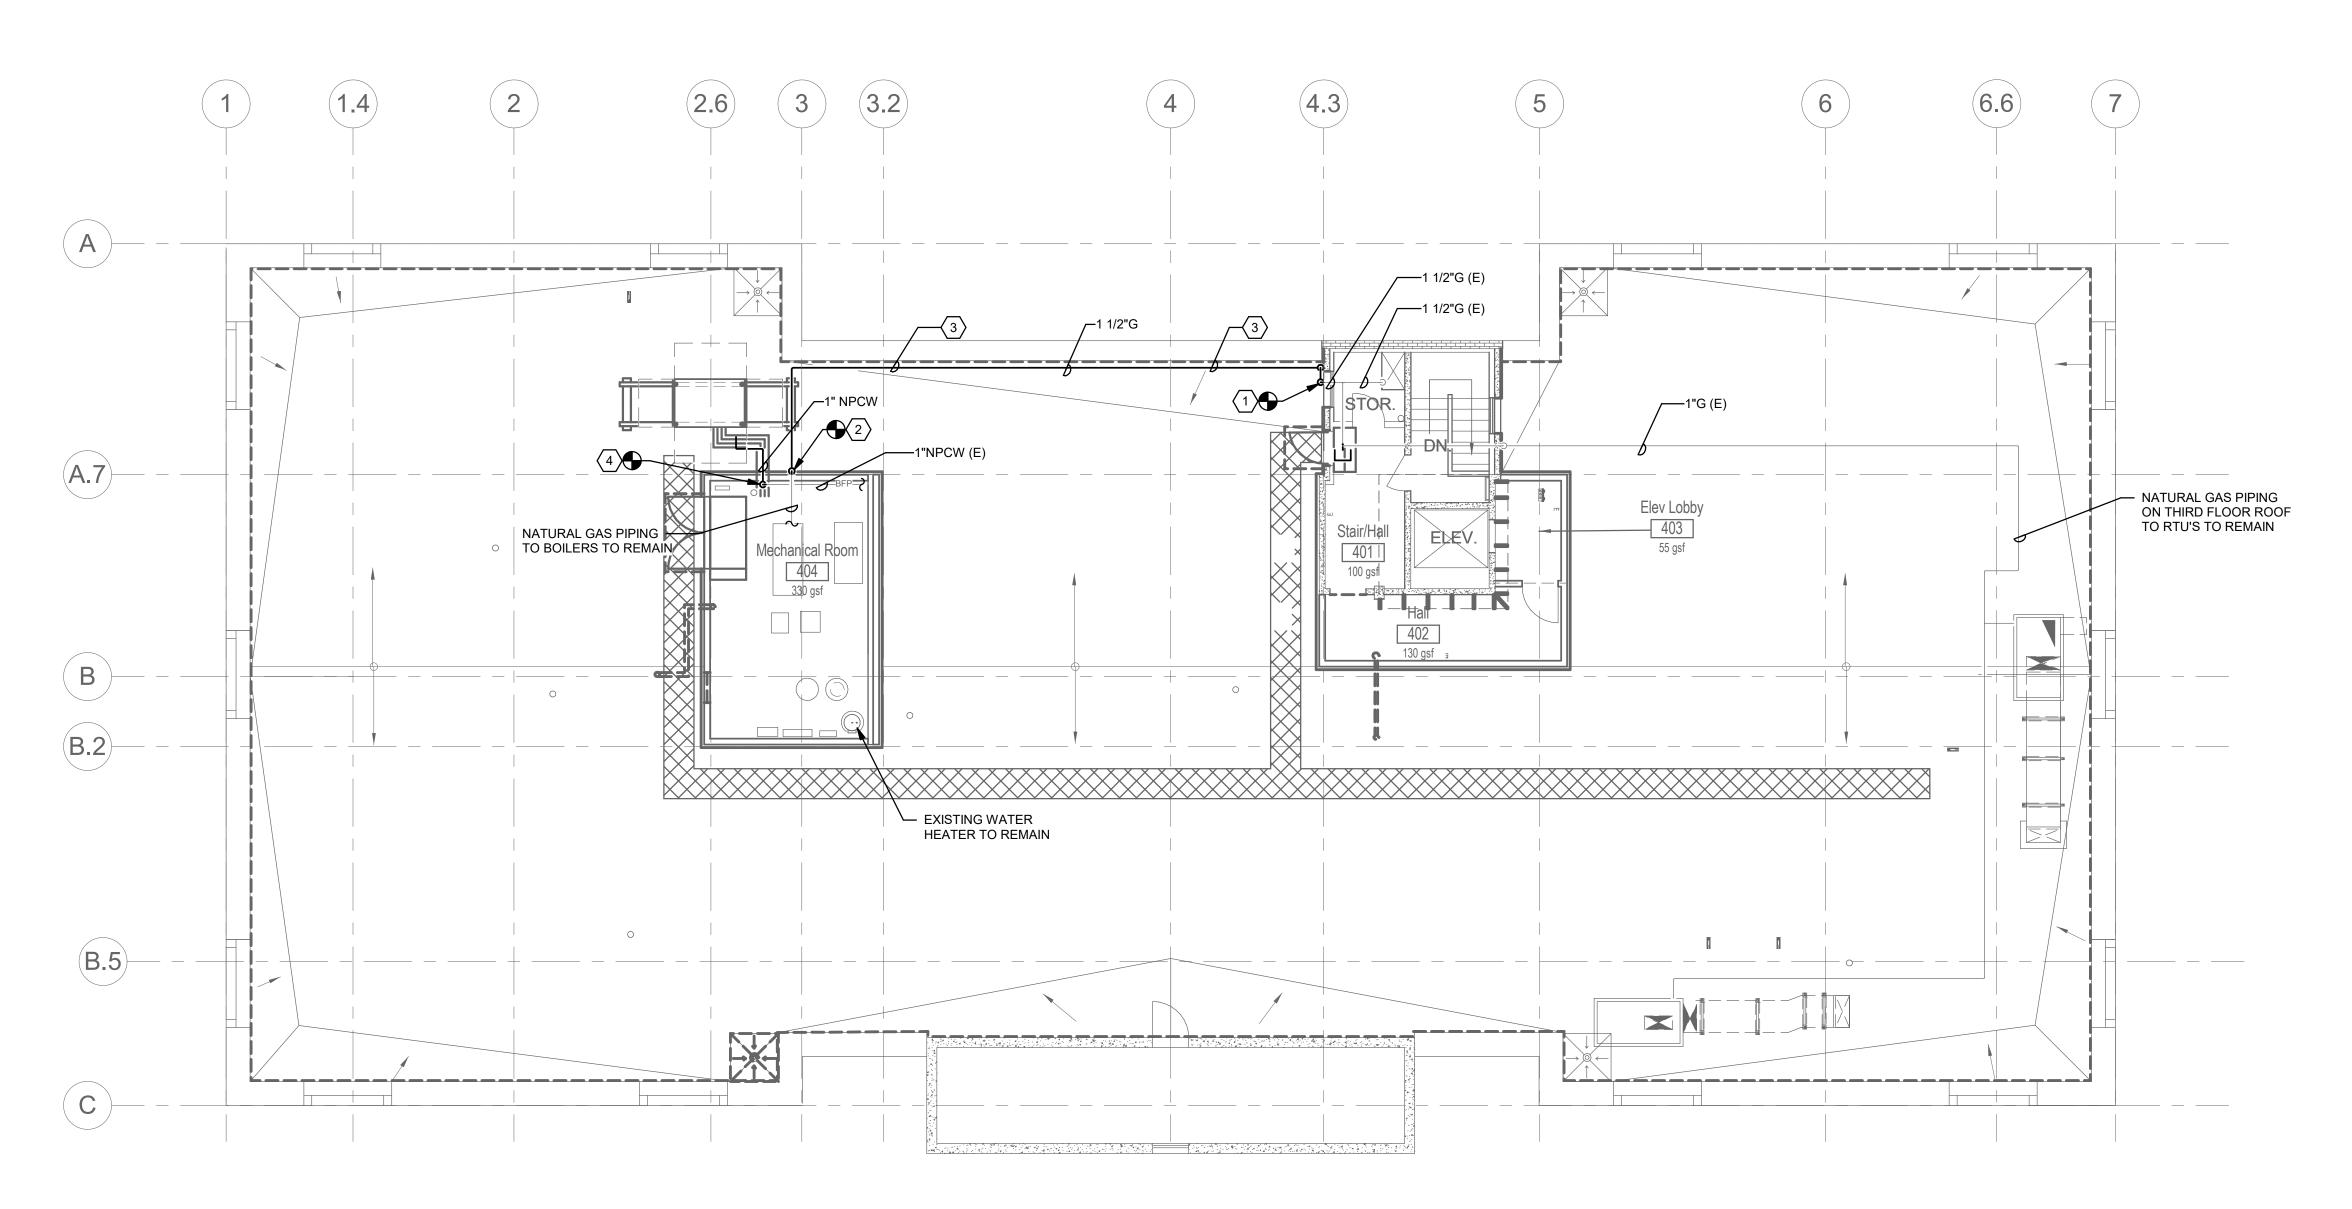

## ○ SHEET KEYNOTES

- CONNECT NEW NATURAL GAS PIPING TO EXISTING GAS PIPING THIS APPROXIMATE LOCATION. COORDINATE NATURAL GAS PIPING ROUTING WITH EXISTING WINDOW.
- 2. CONNECT NEW NATURAL GAS PIPING TO EXISTING GAS PIPING THIS APPROXIMATE LOCATION.
- 3. ROUTE NEW NATURAL GAS PIPING ON ROOF AS SHOWN AND PROVIDE PIPING SUPPORTS PER SPECIFICATIONS.
- 4. CONNECT NEW 1-INCH NON-POTABLE COLD WATER PIPING TO EXISTING NON-POTABLE COLD WATER PIPING THIS APPROXIMATE LOCATION AND ROUTE TO CONNECTION WITH NEW COOLING TOWER. COORDINATE EXACT CONNECTION LOCATION AND REQUIREMENTS WITH COOLING TOWER MANUFACTURER PRIOR TO INSTALLATION.



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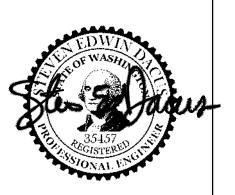


ABB PROJECT #: 22-7763.01

SCOPE OF WORK:

4th Floor Jail Demolition
& Re-roofing

OWNER NAME:
Skagit County Courthouse

PROPERTY ADDRESS:
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Mark Description Date

PERMIT SET 03/10/23

Permit Correction
Bid Set

BID SET ISSUE 09/25/23

BUILDING DEPARTMENT PERMIT # TBD



PROJECT 2022-0114
CONTACT Tracy Bethel

100 SW Main Street, Suite 1600

100 SW Main Street, Suite 1600 Portland, OR 97204 TEL 503.382.2266 www.interfaceengineering.com

SHEET TITLE

4TH FLOOR AND ROOF PLAN -PLUMBING

SCALE: NOTED ON DRAWINGS

P2.1



## MECHANICAL SYMBOL LIST

#### <u>Abbreviations</u>

AFF ABOVE FINISHED FLOOR

AD ACCESS DOOR

AIR CONDITION(ED) BDD

BACKDRAFT DAMPER BFP BACKFLOW PREVENTER

BELOW FINISHED FLOOR

BRAKE HORSEPOWER CD CEILING DIFFUSER

CV CHECK VALVE

COP COEFFICIENT OF PERFORMANCE

CW COLD WATER

CD CONDENSATE DRAIN

CU CONDENSING UNIT

CONT. CONTINUATION

DB DECIBEL

DIA DIAMETER DX DIRECT EXPANSION

D DROP

DRY BULB

EFF **EFFICIENT** 

ELECT ELECTRICAL EER ENERGY EFFICIENCY RATING

EAT ENTERING AIR TEMPERATURE

EWT ENTERING WATER TEMPERATURE

EXH **EXHAUST** 

EXHAUST FAN

FAHRENHEIT

FT FEET

FD FIRE DAMPER FLA FULL LOAD AMPS

GAL GALLONS

GALLONS PER HOUR

GPM GALLONS PER MINUTE

HD HEAD HTR HEATER

HTG **HEATING** 

HORSEPOWER HWC HOT WATER COIL

INCHES

INSIDE DIAMETER ID INVERT ELEVATION

KW KILOWATT

LATENT HEAT

LEAVING AIR TEMPERATURE LAT MAX MAXIMUM

MIN MINIMUM

MIXED AIR MA

MOTORIZED DAMPER N/A NOT APPLICABLE

NOT IN CONTRACT

NOT TO SCALE

NO. NUMBER OC

ON CENTER OBD OPPOSED BLADE DAMPER

OUTSIDE AIR

OD OUTSIDE DIAMETER

POUNDS POUNDS PER SQUARE INCH

PD PRESSURE DROP

PRESSURE REDUCING VALVE

PRV QTY QUANTITY

RET RETURN

RETURN AIR

RPM REVOLUTIONS PER MINUTE R

SEER SEASONAL ENERGY EFFICIENCY RATING SH SENSIBLE HEAT

SOV SHUT OFF VALVE

SF SQUARE FEET

STATIC PRESSURE

SUPPLY AIR T, TEMP TEMPERATURE

TD TEMPERATURE DIFFERENCE THOUSAND BTU'S PER HOUR MBH

TOTAL HEAT

TOTAL PRESSURE V VOLT

WC WATER COLUMN

WB

WET BULB WITH

#### <u>General</u>



DETAIL NUMBER AND SHEET LOCATION



**EQUIPMENT IDENTIFICATION** 



POINT OF CONNECTION

SECTION NUMBER AND SHEET LOCATION

DEMOLISH (DASH-DOT)

----- EXISTING WORK

ELECTRIC WALL HEATER SCHEDULE										
		AREA	BASIS OF	DESIGN			ELECT	TRICAL		
SYMBOL	LOCATION	SERVING	MFR	MODEL	TYPE	HEAT (kW)	VOLTS	PH	COMMENTS	
WH-1	MECHANICAL ROOM	MECHANICAL ROOM	INDEECO	WRI	RECESSED	1.5	120	1	INTEGRAL THERMOSTAT	
WH-2	HALL	HALL	INDEECO	WRI	RECESSED	1	120	1	INTEGRAL THERMOSTAT	

	COOLING TOWER SCHEDULE																						
		BASIS OF D	DESIGN	TOWER			FLUID			Α	IR	FAN		EL	ECTRIC	CAL							
				HEAT						AMB	IENT						MIN.				APPROX		
	SYSTEM			REJ.	EWT	LWT	FLUID	,	WPD	DB	WB						SCCR	VFD	EMERGENCY	CONTROLS	DIMS	MAX WT	
SYMBOL	SERVING	MFR	MODEL	(MBH)	(°F)	(°F)	TYPE	GPM	(FT)	(°F)	(°F)	MHP	VOLTS	PH	MCA	MOCP	(KAIC)	(Y/N)	POWER (Y/N)	REF	(LxWxH)	(LBS)	COMMENTS
CT-1	WATER-SOURCE HEAT PUMP LOOP	BALTIMORE AIR COIL	VT0-41-J	747	90	80	WATER	145	12.00	95	69	7.5	208	3	30.3	60	10	Y	Y	ELECTRONIC	6'x4'x7'-6"	1650	2 KW BASIN HEATER

## **SHEET INDEX**

SYMBOL LIST AND GENERAL NOTES - MECHANICAL

M1.1 4TH FLOOR AND ROOF DEMO PLAN - MECHANICAL

M2.1 4TH FLOOR AND ROOF PLAN - MECHANICAL



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The undersigned has provided building enclosure documents that in my professional judgement are appropriate to satisfy the requirements of RCW 64.55.005 through 64.55.090



#### ABB PROJECT #: 22-7763.01

SCOPE OF WORK: 4th Floor Jail Demolition & Re-roofing OWNER NAME: Skagit County Courthouse PROPERTY ADDRESS: 205 W. Kincaid Street Mount Vernon, WA 98273 PROPERTY MANAGER: Skagit County Facilities 1800 Continental Place Mount Vernon, WA 98273

Mark	Description	Date
	PERMIT SET	03/10/23
/1\	Permit Correction Bid Set	
	BID SET ISSUE	09/25/23

PERMIT # TBD

**BUILDING DEPARTMENT** 



PROJECT 2022-0114 CONTACT Steve Dacus 100 SW Main Street, Suite 1600

Portland, OR 97204 TEL 503.382.2266 www.interfaceengineering.com

## SYMBOL LIST

SHEET TITLE


AND GENERAL NOTES -**MECHANICAL** 


SCALE: NOTED ON DRAWINGS


M0.1

## ○ SHEET KEYNOTES

- 1. DEMOLISH EXISTING STEAM RADIATOR AND CAP PIPING WITIN 6 INCHES OF FINISHED FLOOR.
- 2. DEMOLISH EXISTING NATURAL GAS UNIT HEATER, PIPING, AND FLUE.
- 3. DEMOLISH EXISTING NATURAL GAS FURNACE, PIPING, DUCTWORK, AND
- 4. EXISTING EXHAUST FAN, DUCTWORK, AND CONTROLS TO REMAIN. PROTECT DURING CONSTRUCTION.
- 5. DEMOLISH EXISTING CONDENSER WATER SUPPLY AND RETURN BETWEEN MECHANICAL ROOM AND EXISTING COOLING TOWER. SEE M2.4 FOR NEW WORK.

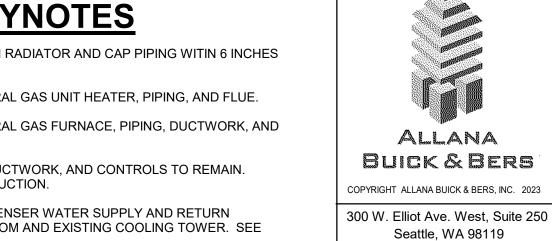

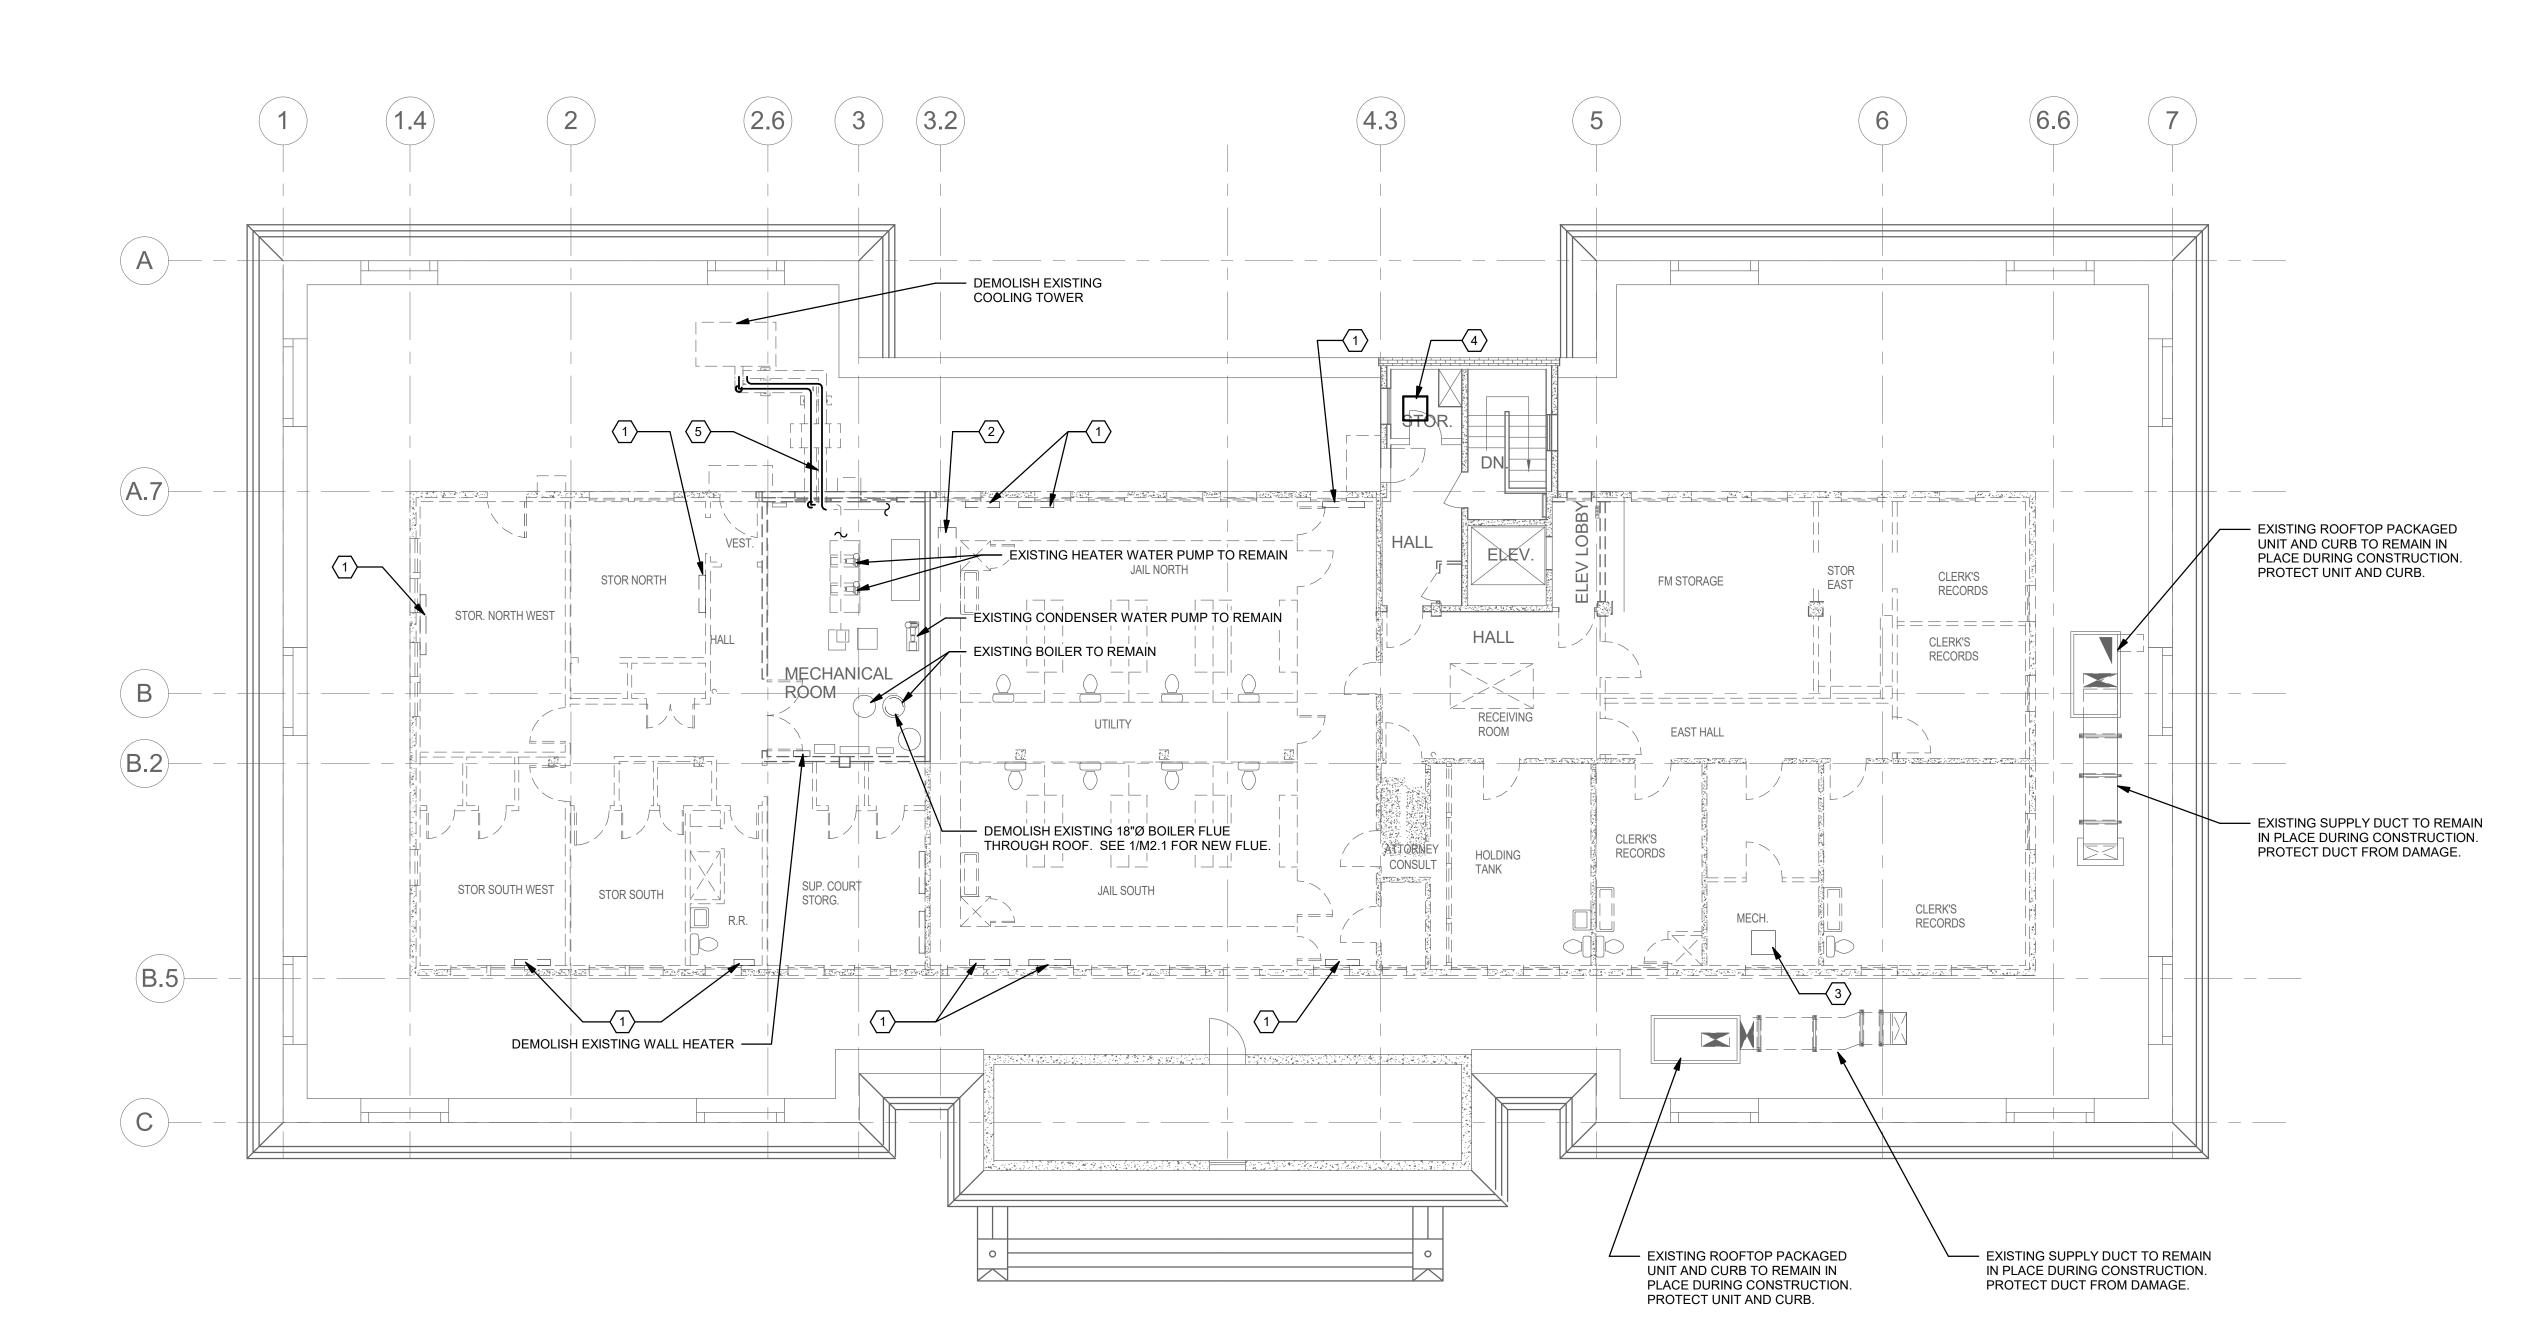

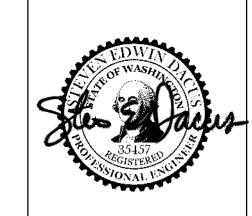

206-443-6499

The undersigned has provided building enclosure documents that in my professional judgement are appropriate to satisfy the requirements of RCW 64.55.005

through 64.55.090

ABB PROJECT #: 22-7763.01

SCOPE OF WORK: 4th Floor Jail Demolition & Re-roofing OWNER NAME: Skagit County Courthouse PROPERTY ADDRESS: 205 W. Kincaid Street Mount Vernon, WA 98273 PROPERTY MANAGER: Skagit County Facilities
Management 1800 Continental Place Mount Vernon, WA 98273

Description PERMIT SET 03/10/23 1 Permit Correction Bid Set BID SET ISSUE 09/25/23

> BUILDING DEPARTMENT PERMIT # TBD



PROJECT 2022-0114 CONTACT Steve Dacus 100 SW Main Street, Suite 1600

Portland, OR 97204 TEL 503.382.2266 www.interfaceengineering.com

SHEET TITLE

4TH FLOOR AND ROOF DEMO PLAN -**MECHANICAL** 


SCALE: NOTED ON DRAWINGS

M1.1

SHEET




1/8" = 1'-0"

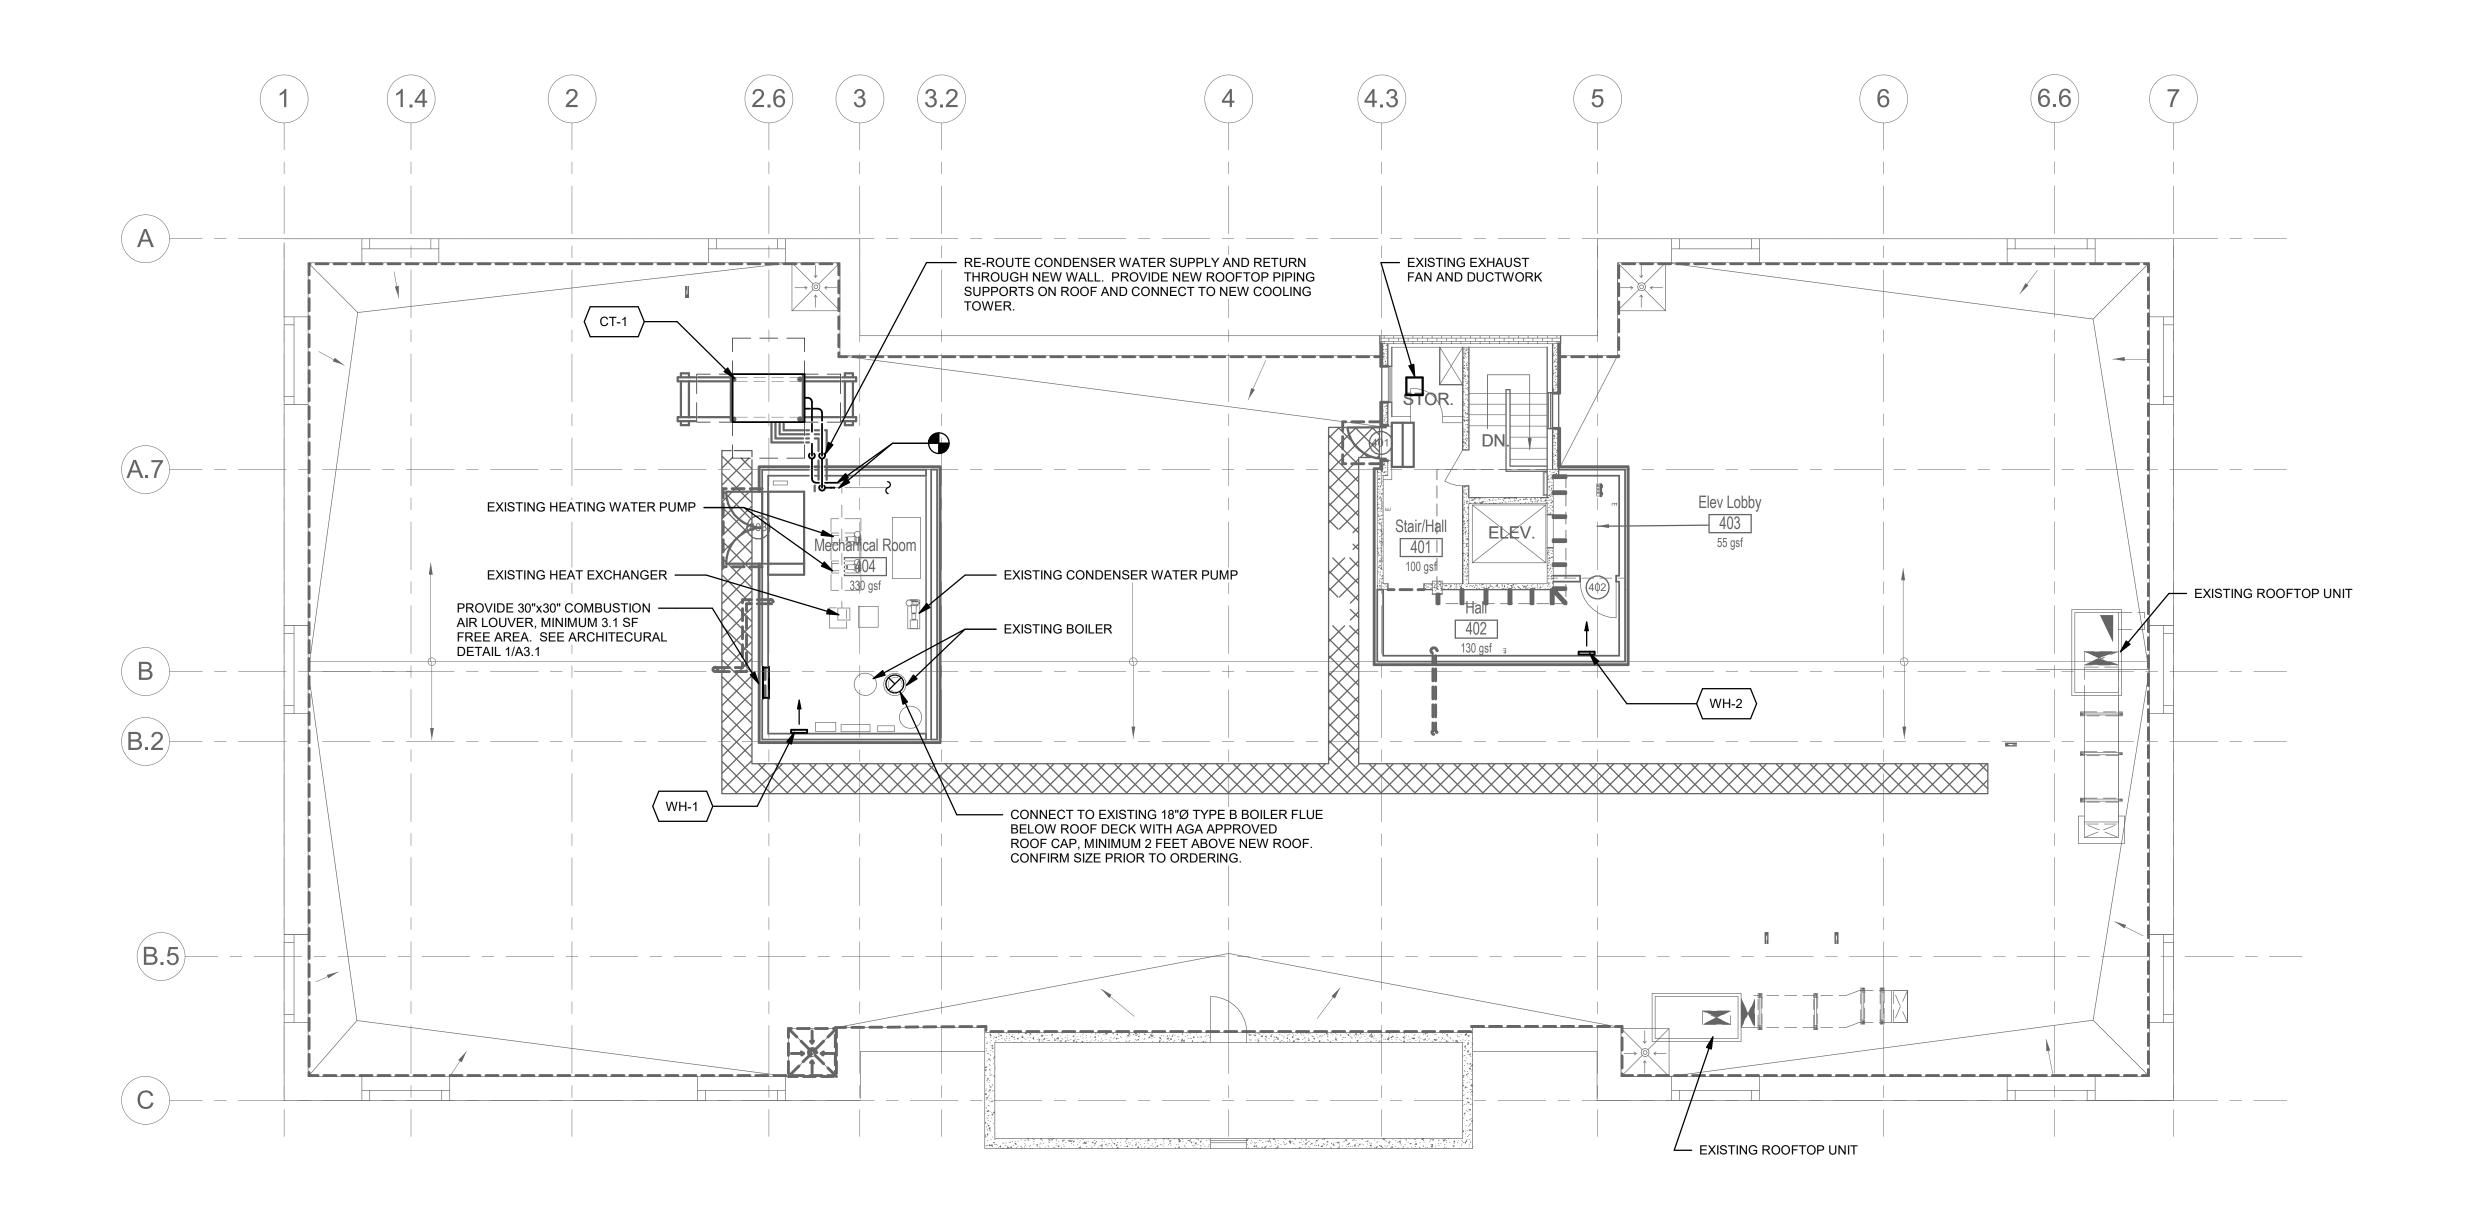

LEVEL 4 MECHANICAL PLAN - OVERALL

1/8" = 1'-0"

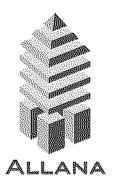

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300 W. Elliot Ave. West, Suite 250
Seattle, WA 98119
206-443-6499

The undersigned has provided building enclosure documents that in my professional judgement are appropriate to satisfy the requirements of RCW 64.55.005 through 64.55.090



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SCOPE OF WORK:

4th Floor Jail Demolition
& Re-roofing

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PROPERTY ADDRESS:
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4TH FLOOR AND ROOF PLAN -MECHANICAL

SCALE: NOTED ON DRAWINGS

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## **ELECTRICAL SYMBOL LIST**

NOTE: This is a standard symbol list and not all items listed may be used.

MADIC VICE	<u>ons</u>	<b>Connections</b>	/ Equipment
AFC	ABOVE FINISHED CEILING		COMBINATION ADJUSTABLE FREQUENCY DRIVE WITH SAFETY
AFF	ABOVE FINISHED FLOOR	VFO	DISCONNECT SWITCH
ANSI AWG	AMERICAN NATIONAL STANDARDS INSTITUTE AMERICAN WIRE GAUGE		
AWG A	AMPERES, AMBER	⊠Ł	COMBINATION MOTOR STARTER/FUSED DISCONNECT SWITCH
AHJ	AUTHORITY HAVING JURISDICTION		COMBINATION MOTOR CTARTERY COLD DICCONNECT CWITCH
AIC	AVAILABLE INTERRUPTING CAPACITY		
BAS	BUILDING AUTOMATION SYSTEM	F	HEAVY DUTY FUSED DISCONNECT SWITCH
CA	CATEGORY		
CAT	CATEGORY CEILING		
CLG C	CONDUIT, CLOSE, CONTROL	$\wp$	MOTOR CONNECTION
COORD	COORDINATE		
CU	COPPER	<b>-</b>	NON FLICED DISCONNECT CWITCH
dB	DECIBEL	D	NON-FUSED DISCONNECT SWITCH
(X)	DEMOLISH		
DTL	DETAIL	T	TRANSFORMER
DIA	DIAMETER	ت	TO WAS STANLEY
DIM	DIMENSION		
DIV DN	DIVISION DOWN	FSD	FIRE SMOKE DAMPER
DWG	DRAWING		
EA	EACH		
EMT	ELECTRICAL METALLIC TUBING	<b>®</b>	SMOKE DAMPER
EL	ELEVATION		
Е	EMERGENCY		OF ILINO MOUNTED HUNOTION DOV
EF	EXHAUST FAN	<b>(</b>	CEILING MOUNTED JUNCTION BOX
(E)	EXISTING		
FF	FINISH FLOOR	J	FLOOR MOUNTED JUNCTION BOX
FA FACP	FIRE ALARM FIRE ALARM CONTROL PANEL	i di	. 15 S.K. M. S.K. L. B. GORGERON BOX
FMC	FLEXIBLE METAL CONDUIT		
FMC	FOOT, FEET	<b>P</b>	WALL-MOUNTED JUNCTION BOX
FBO	FURNISHED BY OTHERS	<del></del> -	
G, GND	GROUND	Fire Alarm	
GFCI	GROUND FAULT CIRCUIT INTERRUPTER		
GFI	GROUND FAULT INTERRUPTER	FACP	FIRE ALARM CONTROL PANEL
GFP	GROUND FAULT PROTECTION	<u></u>	
HH	HANDHOLE	General	
HT	HEIGHT IDENTIFICATION		
ID IN	INCH, INCHES	( <u>X</u> )	DETAIL NUMBER AND SHEET LOCATION
IEEE	INSTITUTE OF ELECTRICAL AND ELECTRONICS ENGINEERS	$\stackrel{\times}{\smile}$	
IMC	INTERMEDIATE METAL CONDUIT	/	
IG	ISOLATED GROUND	( xx-x )	EQUIPMENT IDENTIFICATION
KV	KILOVOLT	LOCATION	
KVA	KILOVOLT AMPERES	<b>,</b>	
KW	KILOWATT	(1)	KEYED NOTE
LED	LIGHT EMITTING DIODE		
LFMC	LIQUIDTIGHT FLEXIBLE METAL CONDUIT		DEMOLIQUE
LV	LOW VOLTAGE	—X—X—	DEMOLISH
MOCP	MAXIMUM OVERCURRENT PROTECTION MILLIAMPERES		
mA MIN	MINIMUM		EXISTING WORK
MCA	MINIMUM CIRCUIT AMPS		LAIGHING WORK
MISC	MISCELLANEOUS		
MCC	MOTOR CONTROL CENTER		NEW WORK
MT, MTD	MOUNT, MOUNTED		
NEC	NATIONAL ELECTRIC CODE	<b>Lighting</b>	
NESC	NATIONAL ELECTRIC SAFETY CODE		
NEMA N	NATIONAL ELECTRICAL MANUFACTURERS ASSOCIATION NEUTRAL		RECESSED 1' X 4' LUMINAIRE
	NEW		
(N) N/A	NOT APPLICABLE		RECESSED 1' X 4' LUMINAIRE CONNECTED TO EMERGENCY/LIFE
N.I.C.	NOT IN CONTRACT		SAFETY CIRCUIT OR WITH INTEGRAL EMERGENCY BATTERY
NTS	NOT TO SCALE		CONNECTED TO UNSWITCHED CIRCUIT
OC	ON CENTER	<u> </u>	DECEDED OF A STATE OF THE STATE
OFCI	OWNER FURNISHED, CONTRACTOR INSTALLED		RECESSED 2' X 2' LUMINAIRE
PNL	PANEL		
PH	PHASE		RECESSED 2' X 2' LUMINAIRE CONNECTED TO EMERGENCY/LIFE SAFETY CIRCUIT OR WITH INTEGRAL EMERGENCY BATTERY
PVC	POLY-VINYL-CHLORIDE POWER		CONNECTED TO UNSWITCHED CIRCUIT
PWR QTY	POWER QUANTITY		
REF	REFERENCE		RECESSED 2' X 4' LUMINAIRE
(R)	RELOCATE	I	- · · · · · · · · · · · · · · · · ·
RFI	REQUEST FOR INFORMATION		RECESSED 2' X 4' LUMINAIRE CONNECTED TO EMERGENCY/LIFE
REQD	REQUIRED		SAFETY CIRCUIT OR WITH INTEGRAL EMERGENCY BATTERY
RMC	RIGID METAL CONDUIT	<u> </u>	CONNECTED TO UNSWITCHED CIRCUIT
RM	ROOM		
SHT	SHEET		RECESSED LUMINAIRE
SIM	SIMILAR		
STD SPD	STANDARD SURGE PROTECTION DEVICE	raen	RECESSED LUMINAIRE CONNECTED TO EMERGENCY/LIFE
SWBD	SURGE PROTECTION DEVICE SWITCHBOARD		SAFETY CIRCUIT
TBD	TO BE DETERMINED		OUDEAGE MOUNTED OF YOUR PRINTINGS OF THE SECTION OF
XFMR	TRANSFORMER		SURFACE MOUNTED 2' X 2' LUMINAIRE CONNECTED TO EMERGENCY/LIFE SAFETY CIRCUIT OR WITH INTEGRAL
TVSS	TRANSIENT VOLTAGE SURGE SUPPRESSOR		EMERGENCY BATTERY CONNECTED TO UNSWITCHED CIRCUIT
TYP	TYPICAL		
UG	UNDERGROUND		SURFACE MOUNTED 2' X 4' LUMINAIRE
UL	UNDERWRITERS LABORATORIES		
UPS	UNINTERRUPTIBLE POWER SUPPLY		SURFACE MOUNTED 2' X 4' LUMINAIRE CONNECTED TO
UON	UNLESS OTHERWISE NOTED		EMERGENCY/LIFE SAFETY CIRCUIT OR WITH INTEGRAL
VFD	VARIABLE FREQUENCY DRIVE		EMERGENCY BATTERY CONNECTED TO UNSWITCHED CIRCUIT
	VOLTS, VOLTAGE		
V	MEATHERRESSE		
WP	WEATHERPROOF		SURFACE OR PENDANT MOUNTED 1' X 4' LUMINAIRE
WP WG	WIRE GUARD		SURFACE OR PENDANT MOUNTED 1' X 4' LUMINAIRE
WP			SURFACE OR PENDANT MOUNTED 1' X 4' LUMINAIRE  SURFACE OR PENDANT MOUNTED 1' X 4' LUMINAIRE  CONNECTED TO EMERGENCY/LIFE SAFETY CIRCUIT OR WITH

UNSWITCHED CIRCUIT

•	SURFACE OR PENDANT MOUNTED LUMINAIRE CONNECTED TO EMERGENCY/LIFE SAFETY CIRCUIT OR WITH INTEGRAL EMERGENCY BATTERY CONNECTED TO UNSWITCHED CIRCUIT
	SURFACE OR PENDANT MOUNTED STRIPLIGHT
<u> </u>	WALL MOUNTED 6" WIDE LUMINAIRE
<b>⋤</b>	WALL MOUNTED 6" WIDE LUMINAIRE CONNECTED TO EMERGENCY/LIFE SAFETY CIRCUIT OR WITH INTEGRAL EMERGENCY BATTERY CONNECTED TO UNSWITCHED CIRCUIT
	WALL MOUNTED 12" WIDE LUMINAIRE
<u>, •</u>	WALL MOUNTED 12" WIDE LUMINAIRE CONNECTED TO EMERGENCY/LIFE SAFETY CIRCUIT OR WITH INTEGRAL EMERGENCY BATTERY CONNECTED TO UNSWITCHED CIRCUIT
오	WALL MOUNTED LUMINAIRE
•	WALL MOUNTED LUMINAIRE CONNECTED TO EMERGENCY/LIFE SAFETY CIRCUIT OR WITH INTEGRAL EMERGENCY BATTERY CONNECTED TO UNSWITCHED CIRCUIT
#10 #10 B-27,29,31.	BRANCH CIRCUIT WIRING. ARROW INDICATES HOME RUN TO PANEL WITH CIRCUITS AS NOTED. WIRE SIZE IS #12 AWG MINIMUM UNLESS NOTED OTHERWISE. SHORT TICK MARKS INDICATE PHASE CONDUCTORS. LONG TICK MARKS INDICATE NEUTRAL CONDUCTORS. A SINGLE CURVED TICK MARK INDICATES INSULATED GREEN GROUND CONDUCTOR. SECOND CURVED TICK MARK INDICATES "ISOLATED GROUND" (GREEN INSULATION WITH YELLOW STRIPE) CONDUCTOR.
	BRANCH PANEL
	CIRCUIT BREAKER
	DRY TYPE TRANSFORMER
_	FLUSH WALL MOUNTED BRANCH PANEL
GB	GROUND BAR
	MAIN DISTRIBUTION PANEL / SUB DISTRIBUTION PANEL
<u>Raceways</u>	
***************************************	CONDUIT CONCEALED IN WALL OR CEILING SPACE
220 220m AMAY 20220 20200 4200 420	CONDUIT ROUTED BELOW FLOOR / GRADE
	CONDUIT ELLED DOWN
	CONDUIT ELLED UP
	CONDUIT/WIRING CONTINUATION
	CONDUIT/WIRING STUBBED OUT WITH END CAP OR INSULATED PLASTIC BUSHING
·····	FLEXIBLE CONDUIT
Switches and	DUPLEX RECEPTACLE (MULTIPLE LETTERS INDICATE MULTIPLE OPTIONS)  A = ABOVE COUNTER  B = CLOCK HANGER  C = FLUSH CEILING MOUNTED  E = EMERGENCY  F = ARC FAULT PROTECTED BY BREAKER IN PANEL  G = GROUND FAULT CIRCUIT INTERRUPTER  H = HOSPITAL GRADE  K = CHILD RESISTANT COVER  L = ISOLATED GROUND  P = PENDANT MOUNTED WITH CORD GRIPS. VERIFY PENDANT  LENGTH  R1 = HALF SWITCHED BY OCCUPANCY SENSOR RELAY  R2 = FULLY SWITCHED BY OCCUPANCY SENSOR RELAY  S = SPLIT WIRED  T = TAMPER RESISTANT SHUTTERED RECEPTACLE  U = USB PORT(S)  W = WEATHERPROOF CONTINUOUS USE COVER, GFCI  PROTECTED, WITH WEATHER-RESISTANT RECEPTACLE
	DUPLEX RECEPTACLE, FLUSH FLOOR
<b>(</b>	DOUBLE DUPLEX RECEPTACLE, FLUSH FLOOR
<del></del>	DOUBLE DUPLEX RECEPTACLE. SEE LETTER CODE LIST AT DUPLEX RECEPTACLE FOR OPTIONS

**EQUIPMENT ELECTRICAL CONNECTION** SPECIAL PURPOSE RECEPTACLE. LETTER CODE DENOTES RECEPTACLE CONFIGURATION LX-XXR = NEMA CONFIGURATION TWIST-LOCK RECEPTACLE X-XXR = NEMA CONFIGURATION STRAIGHT BLADE RECEPTACLE D. P = PENDANT MOUNT WITH CORD GRIPS. VERIFY PENDANT LENGTH X = COORDINATE RECEPTACLE CONFIGURATION WITH **EQUIPMENT BEING SUPPLIED** CEILING MOUNTED OCCUPANCY SENSOR P = PASSIVE INFRARED D = DUAL TECHNOLOGY U = ULTRASONIC, 360 DEG RANGE H = ULTRASONIC, HALLWAY PATTERN v (LOWERCASE) = VACANCY CONTROL DESIGNATION WALL MOUNTED OCCUPANCY SENSOR P = PASSIVE INFRARED D = DUAL TECHNOLOGY v (LOWERCASE) = VACANCY CONTROL DESIGNATION WALL MOUNTED OCCUPANCY SENSOR/SWITCH S = PASSIVE INFRARED WITH INTEGRAL "OFF" SWITCH T = DUAL RELAY PASSIVE INFRARED WITH TWO INTEGRAL "OFF" SWITCHES D = PASSIVE INFRARED WITH INTEGRAL DIMMER TO OFF. v (LOWERCASE) = VACANCY CONTROL DESIGNATION MULTIPLE CHANNEL SURFACE METAL RECEPTACLE RACEWAY WITH LOW VOLTAGE DIVIDERS, LENGTH AND RECEPTACLES AS INDICATED PHOTO ELECTRIC SWITCH D = CONTINUOUS DIMMING PHOTOCELL

S = SWITCHED PHOTOCELL SINGLE POLE SWITCH 2 = DOUBLE POLE SWITCH 3 = THREE-WAY SWITCH 4 = FOUR-WAY SWITCH

a THRU z (LOWERCASE) = LUMINAIRE CONTROL DESIGNATION D = DIMMER

F = FAN SPEED CONTROL K = KEY OPERATED SWITCH L = LIGHTED HANDLE M = MANUAL MOTOR STARTER WITH THERMAL OVERLOAD

P = SWITCH WITH PILOT LIGHT S = SENTRY SWITCH

T = INTERVAL TIMER

W = WEATHERPROOF SWITCH V = LOW VOLTAGE SWITCH

#### <u>Telecommunications</u>

RACEWAY ONLY DATA/TELEPHONE OUTLET. PROVIDE DOUBLE GANG BACK BOX AND SINGLE GANG ADAPTER PLATE WITH 1" C. AND PULLSTRING TO ACCESSIBLE CEILING SPACE. (MULTIPLE LETTERS INDICATE MULTIPLE OPTIONS)

A = ABOVE COUNTER C = CEILING MOUNTED ABOVE ACCESSIBLE CEILING F = FLUSH CEILING MOUNTED R = SURFACE MOUNTED ON RACEWAY

RACEWAY ONLY TELEPHONE OUTLET. PROVIDE DOUBLE GANG BACK BOX AND SINGLE GANG ADAPTER PLATE WITH 3/4" C. AND PULLSTRING TO ACCESSIBLE CEILING SPACE. SEE LETTER CODE LIST AT DATA/TELEPHONE OUTLET FOR OPTIONS.

**GENERAL ELECTRICAL NOTES** 

ALL ELECTRICAL MATERIAL AND INSTALLATIONS SHOWN AND/OR SPECIFIED TO BE INSTALLED PER THE MANUFACTURER'S RECOMMENDATIONS AND IN ACCORDANCE WITH THE LATEST EDITION OF THE NEC.

REFER TO ARCHITECTURAL DRAWINGS TO COORDINATE LOCATION AND MOUNTING HEIGHT

REFER TO MECHANICAL AND PLUMBING DRAWINGS FOR EXACT LOCATION OF ALL MECHANICAL AND PLUMBING EQUIPMENT.

MAXIMUM VOLTAGE DROP OF BRANCH CIRCUITS TO BE 3%. ELECTRICAL CONTRACTOR TO

E. NO WIRE SMALLER THAN #12 AWG SHALL BE USED FOR BRANCH CIRCUIT WIRING.

F. IN FINISHED INTERIOR AREAS RUN ALL CONDUITS CONCEALED UNLESS OTHERWISE NOTED. PAINT ALL EXPOSED CONDUITS AND ELECTRICAL EQUIPMENT. REFER TO ARCHITECTURAL PAINTING SPECIFICATIONS FOR REQUIREMENTS.

G. ALL EXPOSED CONDUIT TO BE RUN PARALLEL TO BUILDING LINES.

PROVIDE DEDICATED NEUTRALS FOR ALL BRANCH CIRCUITS UNLESS OTHERWISE NOTED.

ALL IN-SLAB OR BURIED CONDUIT TO BE COMPLETE WITH EQUIPMENT GROUNDING CONDUCTOR.

J. ALL EMPTY CONDUITS TO BE COMPLETE WITH PULL WIRE.

OF ALL ELECTRICAL DEVICES.

SIZE WIRING TO SUIT.

MC CABLE SHALL NOT BE USED WITHOUT PERMISSION FROM THE ENGINEER.

ALL CONDUIT ROUTED IN AREAS SUBJECT TO MECHANICAL DAMAGE TO BE RIGID.

M. THE BUILDING IS DESIGNED TO SEISMIC CATEGORY D. THE ELECTRICAL INSTALLATION SHALL COMPLY WITH BOTH CHAPTER 13 REQUIREMENTS OF ASCE 7 FOR SEISMIC CATEGORY D BUILDINGS AND FEMA 413: INSTALLING SEISMIC RESTRAINTS FOR ELECTRICAL EQUIPMENT. FOR EXAMPLE, GENERATORS ARE TO BE DESIGNED AND INSTALLED TO RESIST THE EFFECTS OF SEISMIC ACTIVITIES.

CARE SHALL BE TAKEN TO ENSURE ELECTRICAL SYSTEMS ARE NOT DAMAGED BY ANY RELATIVE MOVEMENT OF THE BUILDING ELEMENTS. ENSURE THAT CONDUITS, SIMILAR RACEWAYS AND CONDUCTORS ARE INSTALLED SO AS TO ALLOW FOR THESE MOVEMENTS WITHOUT COMPROMISING THE INSTALLATION. USE MANUFACTURER RECOMMENDED PRODUCTS SUCH AS EXPANSION FITTINGS, SLACK IN CONDUCTORS, ETC.. REFER TO STRUCTURAL DRAWINGS FOR LOCATIONS OF EXPANSION JOINTS AND ANTICIPATED BUILDING

## **GENERAL LIGHTING NOTES**

COORDINATE LIGHTING WITH ARCHITECTURAL DRAWINGS PRIOR TO ORDERING TO CONFIRM LUMINAIRES WILL FIT IN INTENDED ARCHITECTURAL FEATURES, CEILING GRIDS, COVES, ETC.

COORDINATE LIGHTING INSTALLATION REQUIREMENTS WITH SPRINKLER CONTRACTOR

PRIOR TO SPRINKLER LINE INSTALLATION. ALL ROOM WALL SWITCHES, DIMMERS AND MOTION SENSORS TO BE SUBORDINATE TO THE

## **GENERAL POWER NOTES**

LOW VOLTAGE SWITCHING ZONE THEY ARE LOCATED IN.

A. USE #10 AWG FOR 20A, 120V CIRCUITS LONGER THAN 70'.

B. USE #8 AWG FOR 20A, 120V CIRCUITS LONGER THAN 100'.

## **GENERAL DEMOLITION NOTES**

A. ALL UNUSED CONDUIT, LOOSE CABLE, WIRE, HANGERS, ETC., SHALL BE REMOVED FROM CEILING SPACE. THE INTENT IS TO KEEP THE CEILING SPACE CLEAN

B. THE CONTRACTOR SHALL RECORD AS-BUILT INFORMATION SHOWING EXISTING JUNCTION BOXES, CONDUIT ROUTES AND CIRCUIT NUMBERS AND ALL OTHER ELECTRICAL EQUIPMENT

C. THE CONTRACTOR SHALL TURN OVER EQIPMENT BEING REMOVED TO THE LANDLORD. EQUIPMENT NOT REQUIRED BY BUILDING MANAGEMENT SHALL BE REMOVED FROM SITE BY

D. ALL SUPPLEMENTARY ELECTRICAL, POWER CONDUIT AND WIRE RISERS AND COMMUNICATIONS CONDUIT AND CABLING RISERS BETWEEN FLOORS NOT REQUIRED SHALL

E. THE CONTRACTOR SHALL SEAL ALL UNUSED OPENINGS DUE TO ELECTRICAL DEMOLITION TO ENSURE THAT FIRE-RESISTANCE IS MAINTAINED. FIRE STOPPING CAULKING PRODUCT SHALL BE NUCO INC. TYPE GG-200 SELF SEALANT.

F. PROVIDE AND INSTALL BLANK COVERPLATES FOR DEVICES SHOWN TO BE REMOVED.

G. SWITCHES ON WALLS BEING DEMOLISHED SHALL BE REMOVED.

H. ALL EXISTING LUMINARES LOCATED IN DEMOLISHED CEILINGS ARE TO BE REMOVED. REMOVE ALL ASSOCIATED CONTROLS SUCH AS SLAVE AND DIMMER SWITCHES.

I. EXISTING LIGHTING CIRCUITS ARE TO BE BROUGHT BACK TO THE PANEL BOARD.

J. UNUSED CONDUIT AND WIRE IS TO BE REMOVED.

K. ALLOW FOR SOME TEMPORARY BASE BUILDING LIGHTS.

EXISTING DISTRIBUTION EQUIPMENT INCLUDING PANELS, TRANSFORMERS, DISCONNECT SWITCHES, SPLITTERS, ETC., LOCATED IN AREAS UNDER CONSTRUCTION ARE TO REMAIN.

M. POWER CONNECTIONS AND OUTLETS ARE TO BE REMOVED FROM WALLS TO BE

N. ALL CIRCUITS ORIGINATING FROM THE PANEL BOARDS AND AFFECTED BY DEMOLITION SHALL SHEET TITLE BE REMOVED BACK TO THE POINT OF ORIGIN.

O. COORDINATE WITH THE SCHOOL PRIOR TO THE COMMENCEMENT OF THE WORK.

P. ENSURE THAT BASE BUILDING WIRING SUCH AS CONTROL-WIRING, ETC. IS NOTDAMAGED.

## **SHEET INDEX**

E0.1 SYMBOL LIST AND GENERAL NOTES - ELECTRICAL

E0.2 LUMINAIRE SCHEDULE

E1.1 4TH FLOOR AND ROOF DEMO PLAN - ELECTRICAL

E2.1 4TH FLOOR AND ROOF PLAN - ELECTRICAL



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INTERFACE ENGINEERING

PROJECT 2022-0114 CONTACT Cody Bargholz


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SYMBOL LIST AND GENERAL NOTES -**ELECTRICAL** 

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E0.1

	LUMINAIRE SCHEDULE										
TYPE	DESCRIPT ION	HOUSING	SHIELDIN G	MOUNTIN G	FINISH	UL/IP RATING	DRIVER/P OWER SUPPLY	LIGHT SOURCE	INPUT WATTS	MFG/CATA LOG #	NOTES
'A1'									0.0		
'A2'									0.0		
'B1' 'C1'		NOMINAL 12"W x 8.5"H x 0.5"D; DIE CAST ALUMINUM HOUSING; CONTRACTOR TO VERIFY BACKBOX REQUIREMEN TS DURING ROUGH-IN		REFER TO ARCHITECTUR AL DRAWINGS FOR MOUNTING CONDITIONS		UL DAMP	INTEGRAL DRIVER		10.0 2.0	EVENLITE RAZOR SERIES; ISOLITE, PATHWAY, SURE-LITES TPX, BARRON LIGHTING, OR APPROVED	
'X'		NOMINAL 12"W x 8.5"H x 0.5"D; DIE CAST ALUMINUM HOUSING; CONTRACTOR TO VERIFY BACKBOX REQUIREMEN TS DURING ROUGH-IN		REFER TO ARCHITECTUR AL DRAWINGS FOR MOUNTING CONDITIONS		UL DAMP	INTEGRAL DRIVER		2.0	EVENLITE RAZOR SERIES; ISOLITE, PATHWAY, SURE-LITES TPX, BARRON LIGHTING, OR APPROVED	



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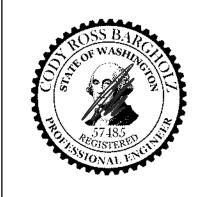

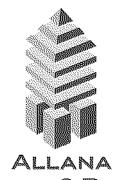
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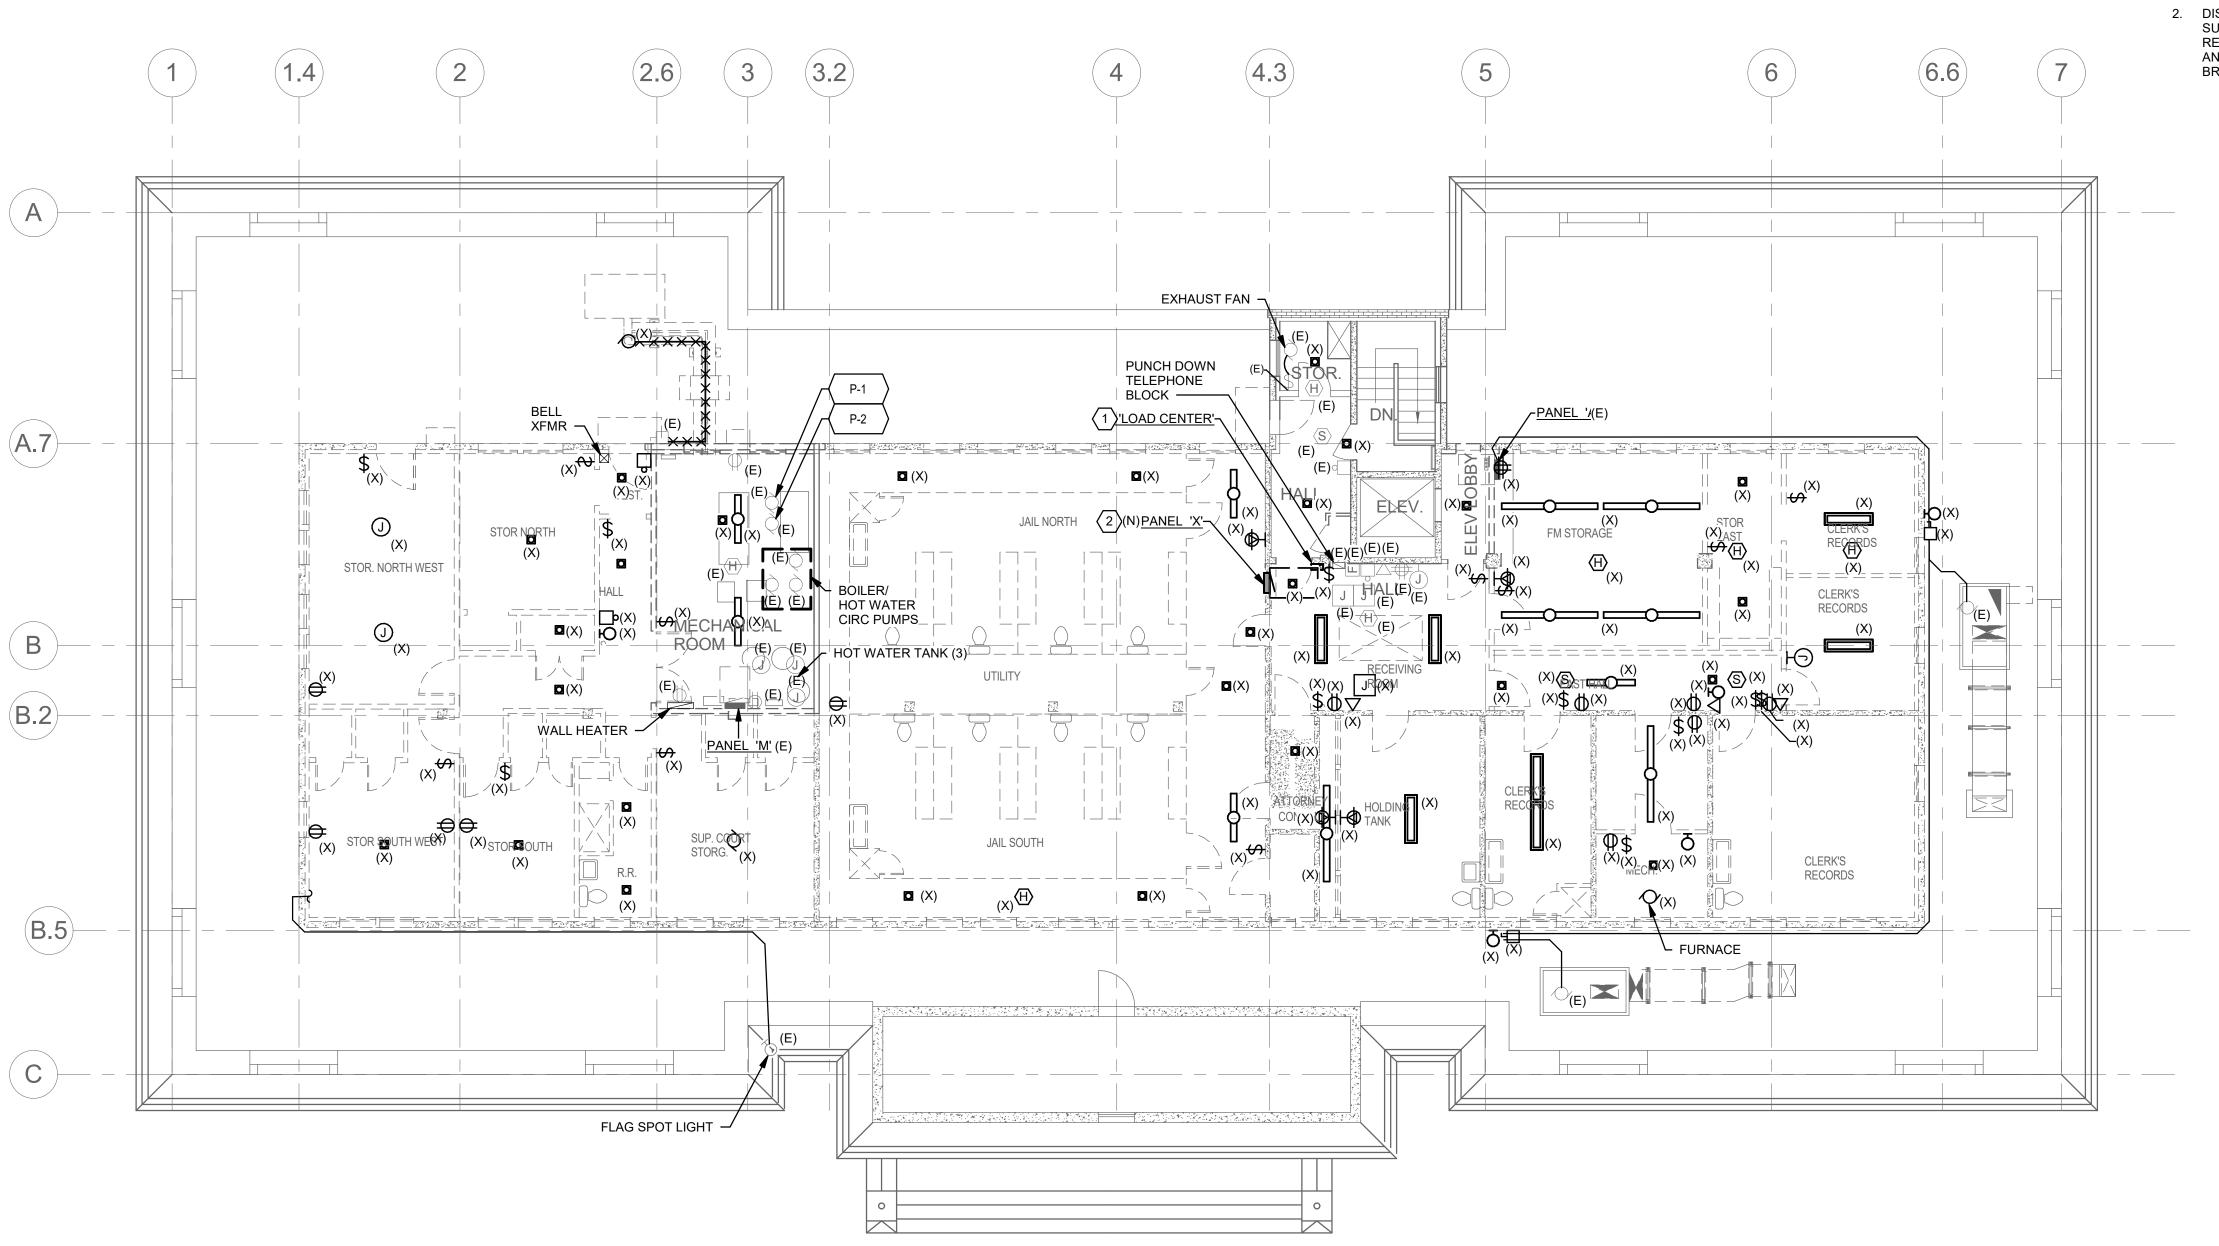
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SHEET TITLE

LUMINAIRE SCHEDULE

SCALE: NOTED ON DRAWINGS

E0.2



LEVEL 4 DEMO ELECTRICAL PLAN - OVERALL

1/8" = 1'-0"



## ○ SHEET KEYNOTES

- 1. DISCONNECT EXISTING BRANCH CIRCUIT WIRING, DEMOLISH EXISITNG LOAD CENTER AND FEEDER. EXTEND EXISITNG BEANCH CIRCUIT WIRING TO NEW BREAKERS AT PANEL X.
- 2. DISCONNECT EXISTING FEEDER. TURN PANELBOARD OVER TO OWNER. SUPPLY AND INSTALL NEW 42 CIRCUIT RECESSED PANELBOARD RETROFIT KIT. RECONNECT EXISITING FEEDERS TO NEW PANELBOARD AND RECONNECT EXISITING BRANCH CIRCUIT WIRING TO NEW REPEAKERS



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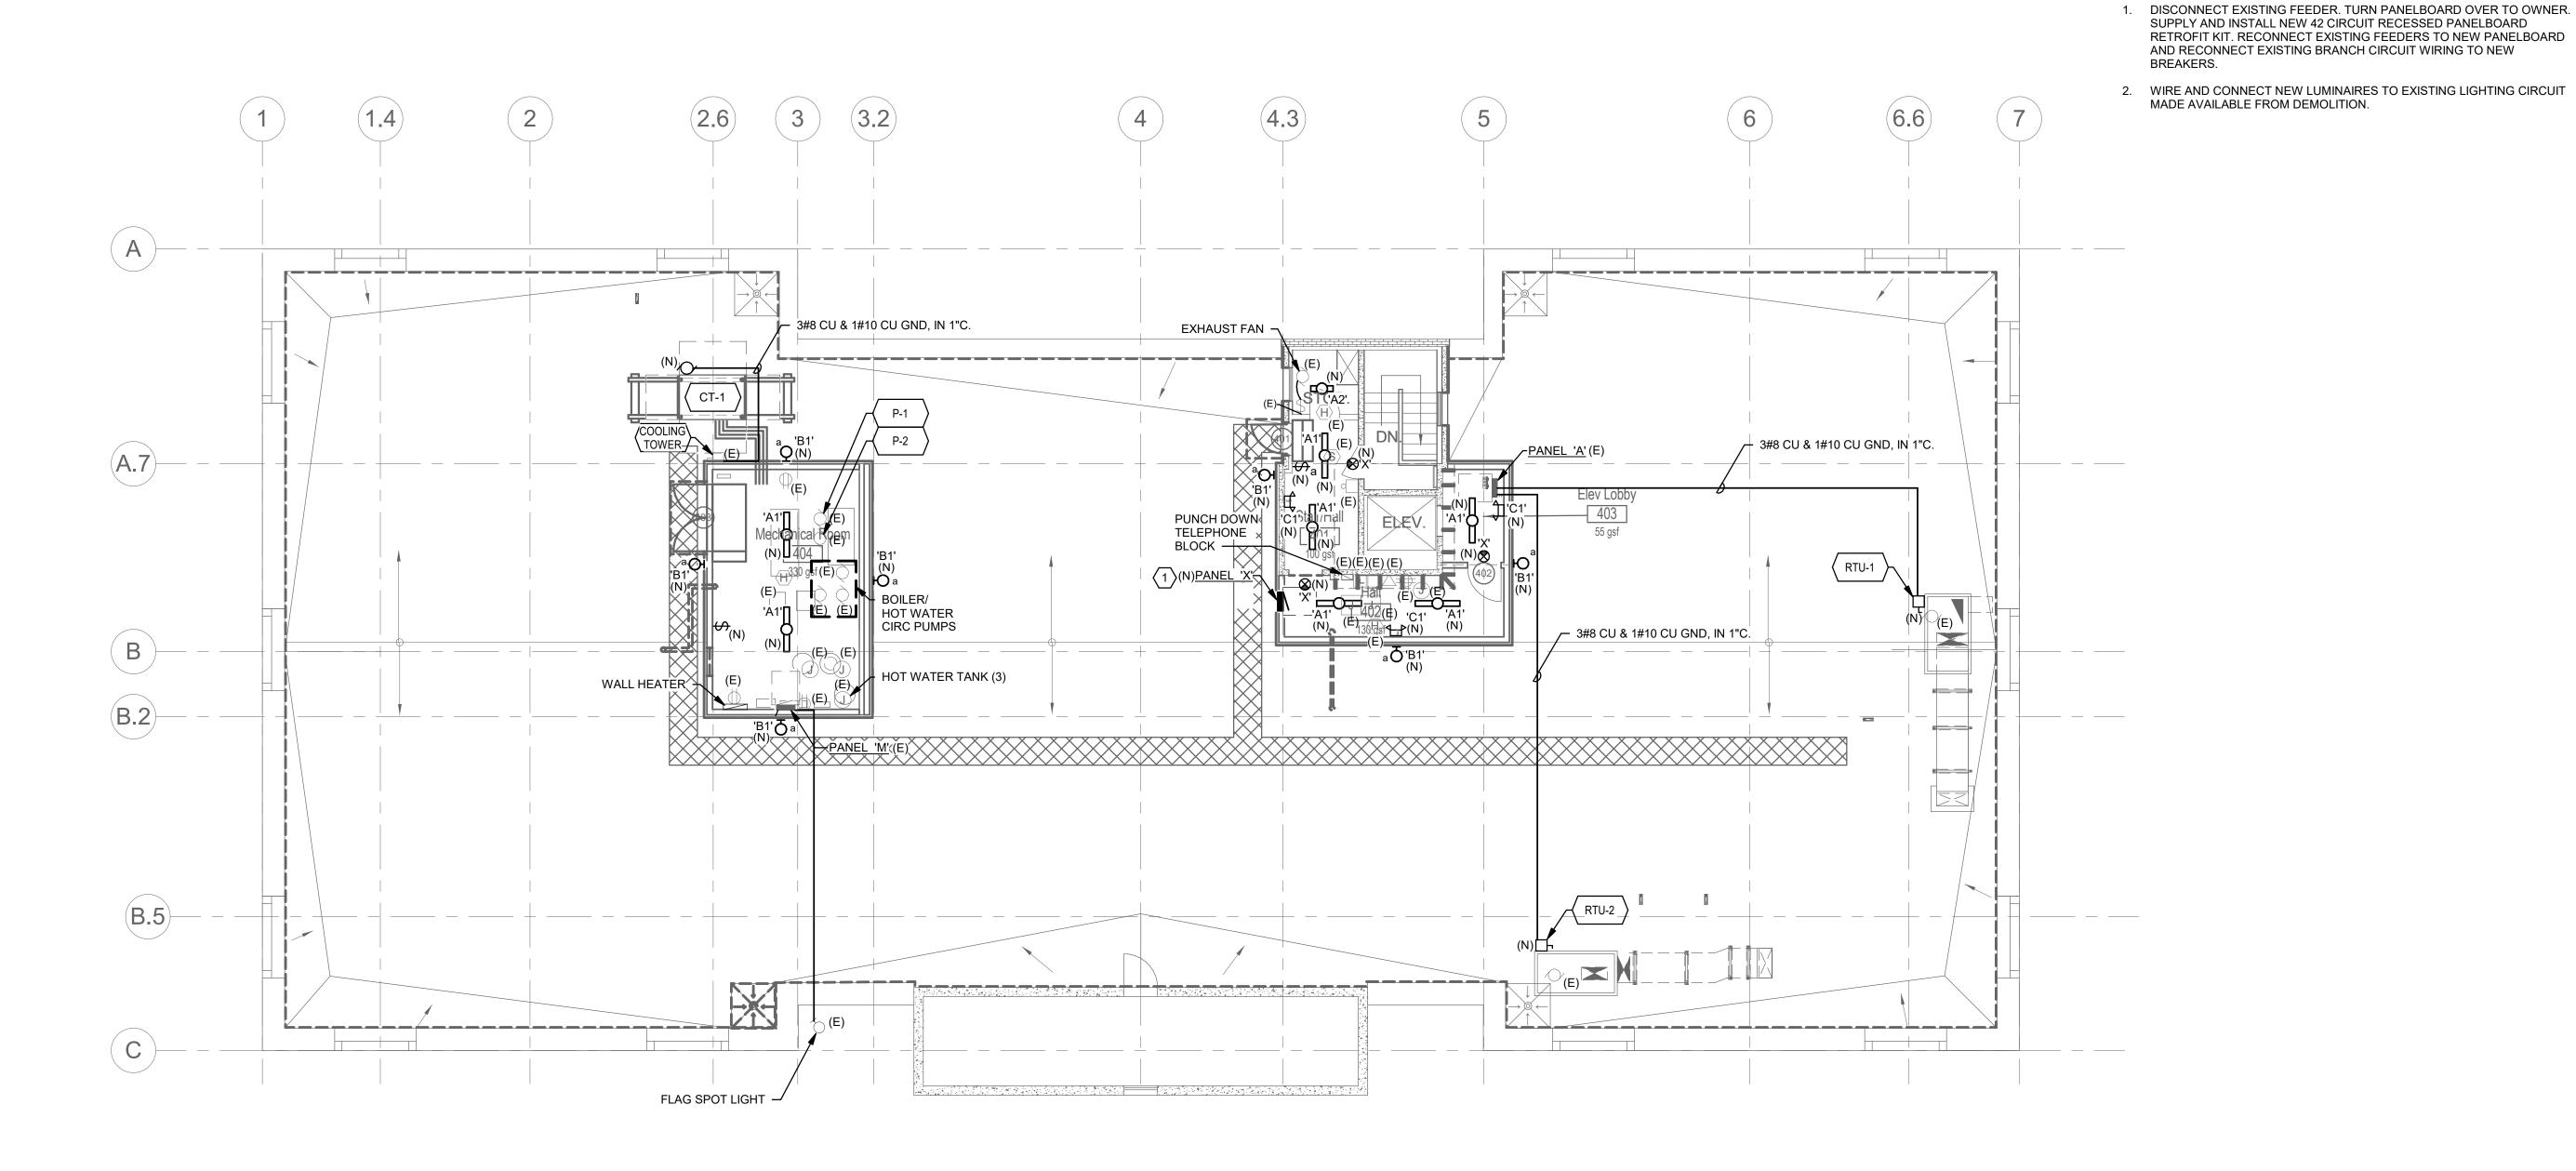
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4TH FLOOR AND ROOF DEMO PLAN -ELECTRICAL

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○ SHEET KEYNOTES

The undersigned has provided building enclosure documents that in my professional judgement are appropriate to satisfy the requirements of RCW 64.55.005 through 64.55.090



ABB PROJECT #: 22-7763.01

SCOPE OF WORK:

4th Floor Jail Demolition
& Re-roofing

OWNER NAME:
Skagit County Courthouse

PROPERTY ADDRESS:
205 W. Kincaid Street
Mount Vernon, WA 98273

PROPERTY MANAGER:
Skagit County Facilities
Management
1800 Continental Place
Mount Vernon, WA 98273

PERMIT SET 03/10/23
Permit Correction
Bid Set
BID SET ISSUE 09/25/23

BUILDING DEPARTMENT PERMIT # TBD



PROJECT 2022-0114 CONTACT Cody Bargholz

100 SW Main Street, Suite 1600 Portland, OR 97204 TEL 503.382.2266 www.interfaceengineering.com

SHEET TITLE

4TH FLOOR AND ROOF PLAN -ELECTRICAL

SCALE: NOTED ON DRAWINGS

E2.1

